# Certificate of Appropriateness Case Report Consent Calendar

**HEARING DATE: JULY 6, 2011** 

Filing Date: January 13, 2010
Case No.: **2010.0015A** 

Project Address: 415 Geary Street/333 Mason Street

Historic Landmark: No. 82 – Geary Theater and Geary Theater Annex

Zoning: C-3-G (Downtown, Commercial, General)

80-130-F Height and Bulk District

Block/Lot: 0316/001A

Applicant: Evan Shepherd Reiff for

at&t Mobility

430 Bush Street, 5<sup>th</sup> Floor San Francisco, CA 94105

Staff Contact Aaron Hollister - (415) 575-9078

aaron.hollister@sfgov.org

*Reviewed By* Tim Frye – (415) 575-6822

tim.frye@sfgov.org

#### PROPERTY DESCRIPTION

415 Geary Street/333 Mason Street, southwest corner of Geary and Mason Streets, in Assessor's Block 0316, Lot 001A. The subject site contains City Landmark No. 82 – the Geary Theater and the Geary Theater Annex. The theater and annex occupy the entire "L"-shaped lot with the theater fronting on Geary Street and the annex fronting on Mason Street. The neo-classical Geary Theater was constructed between 1908 and 1910 and is presently known as the ACT Theater. The tripartite, brick Geary Theatre Annex was also constructed between 1908 and 1910 and abuts the rear of the Geary Theatre. The annex currently serves as the loading and stage door entrance to the Geary Theatre. The subject site is located within a C-3-G (Downtown, Commercial, General) Use District, an 80-130-F Height and Bulk Districts, and the Kearny-Market-Mason-Sutter Conservation District.

#### PROJECT DESCRIPTION

The project proposes to install a wireless telecommunications service (WTS) facility operated by at&t Mobility that would include up to seven panel antennas and associated equipment cabinets. The panel antennas would be split into two sectors. "Sector A" would contain three antennas and would be located on the secondary, north-facing façade of the Geary Theater Annex at a maximum height of approximately 48.25 feet. The "Sector A" antennas would not exceed the height of their mounting surface and would be painted to match their mounting surface. "Sector B" would contain four antennas and would be located on the south façade of a non-historic penthouse that is located at the rear of the theater at a maximum of height of approximately 95.3 feet. The "Sector B" antennas would also not exceed the height of their mounting surface and would be painted to match their mounting surface.

1650 Mission St. Suite 400 San Francisco, CA 94103-2479

Reception: 415.558.6378

Fax: 415.558.6409

Planning

Information: **415.558.6377** 

The associated equipment cabinets would be located in the basement of a separate property located at 401-405 Geary Street, which is located at the corner of Geary and Mason Streets. The two-story commercial building is not a part of City Landmark No. 82 and is not subject to the Certificate of Appropriateness request. 401-405 Geary Street is a Category V (Unrated) Structure in the Kearny-Market-Mason-Sutter Conservation District.

#### OTHER ACTIONS REQUIRED

None.

#### COMPLIANCE WITH THE PLANNING CODE PROVISIONS

The proposed project is in compliance with all other provisions of the Planning Code.

#### APPLICABLE PRESERVATION STANDARDS

#### **ARTICLE 10**

A Certificate of Appropriateness is required for any construction, alteration, removal, or demolition of a designated Landmark for which a City permit is required. In appraising a proposal for a Certificate of Appropriateness, the Historic Preservation Commission should consider the factors of architectural style, design, arrangement, texture, materials, color, and other pertinent factors. Section 1006.7 of the Planning Code provides in relevant part as follows:

The proposed work shall be appropriate for and consistent with the effectuation of the purposes of Article 10.

The proposed work shall be compatible with the historic structure in terms of design, materials, form, scale, and location. The proposed project will not detract from the site's architectural character as described in the designating ordinance. For all of the exterior and interior work proposed, reasonable efforts have been made to preserve, enhance or restore, and not to damage or destroy, the exterior architectural features of the subject property which contribute to its significance.

#### THE SECRETARY OF THE INTERIOR'S STANDARDS

Rehabilitation is the act or process of making possible a compatible use for a property through repair, alterations, and additions, while preserving those portions or features that convey its historical, cultural, or architectural values. The Rehabilitation Standards provide, in relevant part(s):

#### Standard 2.

The historic character of a property shall be retained and preserved. The removal of historic materials or alteration of features and spaces that characterize a property shall be avoided.

The proposal will not change the use or the overall character of the existing buildings. The proposed antennas on the theater building would be located on a non-historic mechanical penthouse, which is not a distinctive characteristic feature of the subject building. The proposed antennas on the theater annex would be located on a blank, secondary façade, which does not contain historic materials or character-defining features of the building.

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PLANNING DEPARTMENT 2

#### Standard 9.

New additions, exterior alterations, or related new construction will not destroy historic materials, features, and spatial relationships that characterize the property. The new work will be differentiated from the old and will be compatible with the historic materials, features, size, scale and proportion, and massing to protect the integrity of the property and its environment.

The proposed WTS facility installation is anticipated not to be visible from many viewscapes as viewed from adjacent public rights-of-way and public places. When visible, the WTS facility is anticipated to be minimally visible from the immediately adjacent public rights-of-way and public places. The proposed antennas on the mechanical penthouse would be flush-mounted to and painted to match the penthouse façade. The antennas on the annex would not be visible from several viewpoints, but when visible, the antennas would be minimally visible as the antennas would be flush-mounted and painted to match the mounting surface, a concrete, secondary blank façade. The blank façade does not contain character-defining features of the annex building. By mounting the antennas in such fashion, the antennas would not disrupt the primary parapet lines of the building and would be compatible with the building and the surrounding environment.

#### Standard 10.

New additions and adjacent or related new construction shall be undertaken in such a manner that if removed in the future, the essential form and integrity of the historic property and its environment would be unimpaired.

The WTS facility would be able to be removed without impairment to the buildings or the surrounding environment. The antennas would be respectively mounted to the façade of a non-historic penthouse and a blank, concrete wall that does not contain character-defining features of the building.

#### PUBLIC/NEIGHBORHOOD INPUT

The Department has received no public input on the project at the date of this report.

#### **ISSUES & OTHER CONSIDERATIONS**

None.

#### STAFF ANAYLSIS

Particular to WTS facilities, staff considered the proposed location, method of attachment, screening material, size and number in relation to the subject building. Based on the requirements of Article 10 and the Secretary of Interior's Standards, staff has determined that the proposed work will not adversely affect the subject landmark site and is conformance with Article 10 and the Secretary of the Interior's Standards for Rehabilitation. Staff has found that the historic character of the property would be retained and preserved. Furthermore, staff finds that the proposed project would not impact any of the character-defining features of the Landmark buildings and the proposal is reversible as described in the following discussion.

The components of the proposed wireless telecommunication facility have been positioned to be minimally visible or not visible from adjacent rights-of-way. All seven of the wireless communication antennas would be located on features of the respective buildings that are not are not distinctive characteristic features of the buildings – a secondary, concrete blank façade and a mechanical penthouse. The antennas that would be mounted to the blank façade of the annex would be at a height not to exceed the structure to which the antennas are attached; therefore, no antenna would disrupt the existing parapet line or add undesired height and bulk to the building. Furthermore, mounting the antennas on the blank façade would also be consistent with existing utility features mounted to the secondary facades of the theater and the annex.

The proposed antennas that would be located on the mechanical penthouse of the theater portion of the site are not anticipated to be visible from nearby public rights-of-way. The proposed antennas that would be on the non-historic penthouse would not exceed the height of the penthouse; therefore, the antennas would not add undesirable height and bulk to the theater, nor would the antennas affect surrounding buildings in the area. The proposed, off-site equipment cabinets would not be visible as the equipment cabinets would be located in the basement of the structure at 401-405 Geary Street.

#### **ENVIRONMENTAL REVIEW STATUS**

The Planning Department has determined that the proposed project is exempt from environmental review, pursuant to CEQA Guideline Section 15303 (Class Three-New Construction of Small Structures) because the project is a minor alteration of an existing structure and meets the *Secretary of the Interior's Standards*.

#### PLANNING DEPARTMENT RECOMMENDATION

Planning Department staff recommends APPROVAL of the proposed project is appropriate for and consistent with the purposed of Article 10, meets the standards of Article 10 and the *Secretary of Interior's Standards for Rehabilitation*.

#### **ATTACHMENTS**

Draft Motion
Photo Simulations of Proposed Project
Plans
Zoning Maps

AJH: G:IDOCUMENTSIProjectsIC of Al415 Geary Streetl415 Geary Street Certificate of Appropriateness Case Report.doc

## **Historic Preservation Commission Draft Motion**

**HEARING DATE: JULY 6, 2011** 

1650 Mission St. Suite 400 San Francisco, CA 94103-2479

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ADOPTING FINDINGS FOR A CERTIFICATE OF APPROPRIATENESS FOR PROPOSED WORK DETERMINED TO BE APPROPRIATE FOR AND CONSISTENT WITH THE PURPOSES OF ARTICLE 10, TO MEET THE STANDARDS OF ARTICLE 10 AND TO MEET THE SECRETARY OF INTERIOR'S STANDARDS FOR REHABILITATION, FOR THE PROPERTY LOCATED ON LOT 001A IN ASSESSOR'S BLOCK 0316, WITHIN A C-3-G (DOWNTOWN, COMMERCIAL, GENARAL) ZONING DISTRICT AND AN 80-130-F HEIGHT AND BULK DISTRICT.

#### **PREAMBLE**

WHEREAS, on January 15, 2010, at&t Mobility (Project Sponsor) filed an application with the San Francisco Planning Department (hereinafter "Department") for a Certificate of Appropriateness for installation of a wireless telecommunications service ("WTS") facility operated by at&t Mobility by adding include up to seven panel antennas and associated equipment cabinets. The panel antennas would be split into two sectors. "Sector A" would contain three antennas and would be located on the secondary, north-facing façade of the Geary Theater Annex at a maximum height of approximately 48.25 feet. The "Sector A" antennas would not exceed the height of their mounting surface and would be painted to match their mounting surface. "Sector B" would contain four antennas and would be located on the south façade of a non-historic penthouse that is located at the rear of the theater at a maximum of height of approximately 95.3 feet. The "Sector B" antennas would also not exceed the height of their mounting surface and would be painted to match their mounting surface. The subject buildings are located on Lot 001A in Assessor's Block 0316.

WHEREAS, the Project was determined by the Department to be categorically exempt from environmental review pursuant to CEQA Guideline Section 15303 (Class Three-New Construction of

**CASE NO 2010.0015A** 415 Geary Street/333 Mason Street

Small Structures). The Historic Preservation Commission (hereinafter "Commission") has reviewed and concurs with said determination.

WHEREAS, on July 6, 2011, the Commission conducted a duly noticed public hearing on the current project, Case No. 2010.0015A ("Project") for its appropriateness.

WHEREAS, in reviewing the Application, the Commission has had available for its review and consideration case reports, plans, and other materials pertaining to the Project contained in the Department's case files, has reviewed and heard testimony and received materials from interested parties during the public hearing on the Project.

MOVED, that the Commission hereby grants the Certificate of Appropriateness, in conformance with the architectural plans dated received March 1, 2011, and labeled Exhibit A on file in the docket for Case No. 2010.0015A based on the following findings:

#### **FINDINGS**

Having reviewed all the materials identified in the recitals above and having heard oral testimony and arguments, this Commission finds, concludes, and determines as follows:

- 1. The above recitals are accurate and also constitute findings of the Commission.
- 2. Findings pursuant to Article 10:
  - The proposed WTS facility would not impact any of the character-defining features of the Landmark buildings and the proposal is reversible.
  - The historic character of the property will be retained and preserved. The proposed antennas will be located on a blank, secondary façade and a non-historic mechanical penthouse, which are not distinctive characteristic features of the subject building.
  - The proposed WTS facility has been located so it is not visible or minimally visible from adjacent public rights-of-way and public open spaces.
  - The proposed antennas would be located on secondary elevations at a height not to exceed the structure to which the antennas are attached; therefore, no antenna would disrupt the existing parapet line.
  - The proposed project meets the following Secretary of the Interior's Standards for Rehabilitation:

#### Standard 2.

The historic character of a property shall be retained and preserved. The removal of historic materials or alteration of features and spaces that characterize a property shall be avoided

SAN FRANCISCO
PLANNING DEPARTMENT 2

#### Standard 9.

New additions, exterior alterations, or related new construction will not destroy historic materials, features, and spatial relationships that characterize the property. The new work will be differentiated from the old and will be compatible with the historic materials, features, size, scale and proportion, and massing to protect the integrity of the property and its environment.

#### Standard 10.

New additions and adjacent or related new construction shall be undertaken in such a manner that if removed in the future, the essential form and integrity of the historic property and its environment would be unimpaired.

3. **General Plan Compliance.** The proposed Certificate of Appropriateness is, on balance, consistent with the following Objectives and Policies of the General Plan:

#### I. URBAN DESIGN ELEMENT

THE URBAN DESIGN ELEMENT CONCERNS THE PHYSICAL CHARACTER AND ORDER OF THE CITY, AND THE RELATIONSHIP BETWEEN PEOPLE AND THEIR ENVIRONMENT.

#### **GOALS**

The Urban Design Element is concerned both with development and with preservation. It is a concerted effort to recognize the positive attributes of the city, to enhance and conserve those attributes, and to improve the living environment where it is less than satisfactory. The Plan is a definition of quality, a definition based upon human needs.

#### **OBJECTIVE 1**

EMPHASIS OF THE CHARACTERISTIC PATTERN WHICH GIVES TO THE CITY AND ITS NEIGHBORHOODS AN IMAGE, A SENSE OF PURPOSE, AND A MEANS OF ORIENTATION.

#### POLICY 1.3

Recognize that buildings, when seen together, produce a total effect that characterizes the city and its districts.

#### **OBJECTIVE 2**

CONSERVATION OF RESOURCES WHICH PROVIDE A SENSE OF NATURE, CONTINUITY WITH THE PAST, AND FREEDOM FROM OVERCROWDING.

#### POLICY 2.4

Preserve notable landmarks and areas of historic, architectural or aesthetic value, and promote the preservation of other buildings and features that provide continuity with past development.

#### POLICY 2.7

Recognize and protect outstanding and unique areas that contribute in an extraordinary degree to San Francisco's visual form and character.

CASE NO 2010.0015A 415 Geary Street/333 Mason Street

The goal of a Certificate of Appropriateness is to provide additional oversight for buildings and districts that are architecturally or culturally significant to the City in order to protect the qualities that are associated with that significance.

The proposed project qualifies for a Certificate of Appropriateness and therefore furthers these policies and objectives by maintaining and preserving the character-defining features of 415 Geary Street/333 Mason Street for the future enjoyment and education of San Francisco residents and visitors.

- 4. The proposed project is generally consistent with the eight General Plan priority policies set forth in Section 101.1 in that:
  - A) The existing neighborhood-serving retail uses will be preserved and enhanced and future opportunities for resident employment in and ownership of such businesses will be enhanced:

Numerous neighborhood-serving retail uses will be enhanced with improved at&t Mobility coverage provided by this site.

B) The existing housing and neighborhood character will be conserved and protected in order to preserve the cultural and economic diversity of our neighborhoods:

The proposed project will maintain neighborhood character by respecting the character-defining features of the landmark in conformance with the Secretary of the Interior's Standards.

C) The City's supply of affordable housing will be preserved and enhanced:

The project will not affect the affordable housing supply of the City.

D) The commuter traffic will not impede MUNI transit service or overburden our streets or neighborhood parking:

The proposed project will not result in commuter traffic impeding MUNI transit service or overburdening the streets or neighborhood parking.

E) A diverse economic base will be maintained by protecting our industrial and service sectors from displacement due to commercial office development. And future opportunities for resident employment and ownership in these sectors will be enhanced:

The proposed will not have any impact on industrial and service sector jobs.

F) The City will achieve the greatest possible preparedness to protect against injury and loss of life in an earthquake.

The Project is designed and will be constructed to conform to the structural and seismic safety requirements of the Building Code.

#### CASE NO 2010.0015A 415 Geary Street/333 Mason Street

- G) That landmark and historic buildings will be preserved:
  - The proposed project is in conformance with Article 10 of the Planning Code and the Secretary of the Interior's Standards.
- H) Parks and open space and their access to sunlight and vistas will be protected from development:
  - The proposed project will not impact the access to sunlight or vistas for the parks and open space.
- 5. For these reasons, the proposal overall, is appropriate for and consistent with the purposes of Article 10, meets the standards of Article 10, and the Secretary of Interior's Standards for Rehabilitation, General Plan and Prop M findings of the Planning Code.

CASE NO 2010.0015A 415 Geary Street/333 Mason Street

#### **DECISION**

That based upon the Record, the submissions by the Applicant, the staff of the Department and other interested parties, the oral testimony presented to this Commission at the public hearings, and all other written materials submitted by all parties, the Commission hereby **GRANTS a Certificate of Appropriateness** for the property located at Lot 001A in Assessor's Block 0316 for proposed work in conformance with the renderings and architectural sketches dated March 1, 2011, and labeled Exhibit A on file in the docket for Case No. 2010.0015A.

APPEAL AND EFFECTIVE DATE OF MOTION: The Commission's decision on a Certificate of Appropriateness shall be final unless appealed within thirty (30) days. Any appeal shall be made to the Board of Appeals, unless the proposed project requires Board of Supervisors approval or is appealed to the Board of Supervisors as a conditional use, in which case any appeal shall be made to the Board of Supervisors (see Charter Section 4.135).

**Duration of this Certificate of Appropriateness:** This Certificate of Appropriateness is issued pursuant to Article 10 of the Planning Code and is valid for a period of three (3) years from the effective date of approval by the Historic Preservation Commission. The authorization and right vested by virtue of this action shall be deemed void and canceled if, within 3 years of the date of this Motion, a site permit or building permit for the Project has not been secured by Project Sponsor.

THIS IS NOT A PERMIT TO COMMENCE ANY WORK OR CHANGE OF OCCUPANCY UNLESS NO BUILDING PERMIT IS REQUIRED. PERMITS FROM THE DEPARTMENT OF BUILDING INSPECTION (and any other appropriate agencies) MUST BE SECURED BEFORE WORK IS STARTED OR OCCUPANCY IS CHANGED.

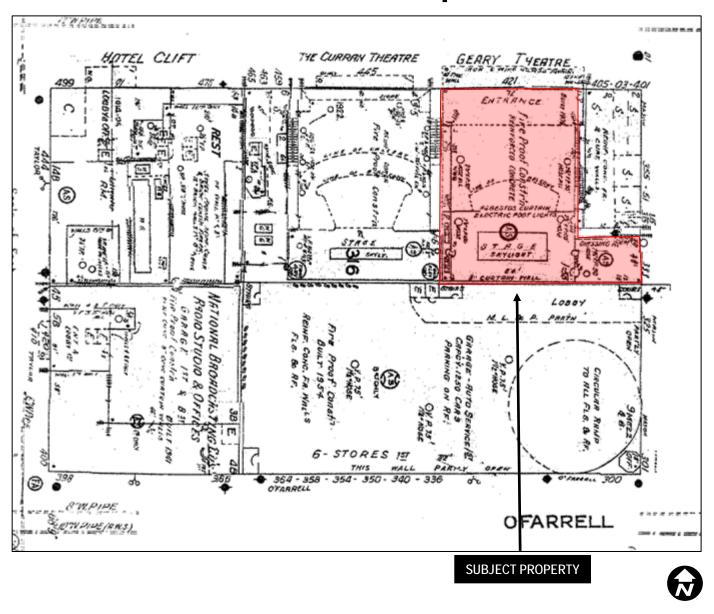
I hereby certify that the Historical Preservation Commission ADOPTED the foregoing Motion on July 6, 2011.

Commission Secretary
AYES:
NAYS:
ABSENT:
ADOPTED: July 6, 2011

Linda D. Avery

SAN FRANCISCO
PLANNING DEPARTMENT

## Sanborn Map\*



\*The Sanborn Maps in San Francisco have not been updated since 1998, and this map may not accurately reflect existing conditions.

Certificate of Appropriateness Request

Case Number 2010.0015A

Geary Theater & Annex – Landmark No. 82

415 Geary Street/333 Mason Street


## **Aerial Photo**



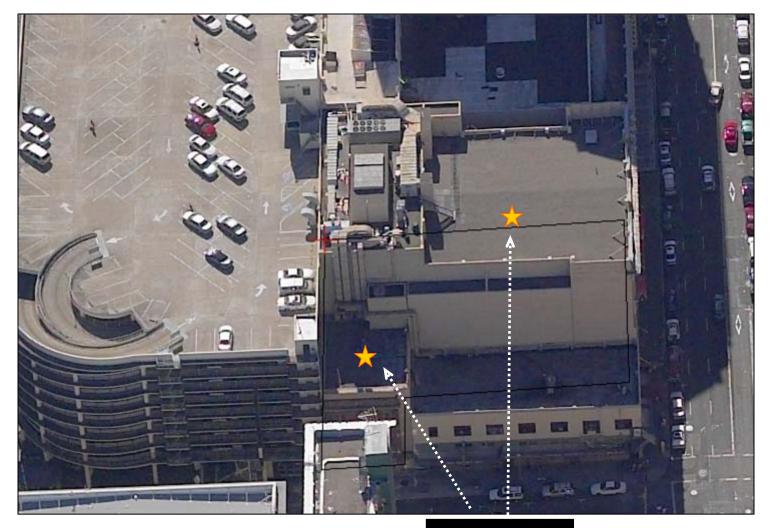SUBJECT PROPERTY



## **Aerial Photo**



SUBJECT PROPERTY



## **401-405 & 415 Geary Contextual Photos-2010.0015A**



View South East on Geary from Geary and Taylor



View North East on Geary from Geary and Taylor



View South West on Mason from Mason and Geary



View South East on Mason from Mason and Geary



View North West on Geary from Mason and Geary





**SFA130** 

American Conservatory
Theatre

401-405 & 415 Geary St. San Francisco, CA 94102











**SFA130** 

American Conservatory
Theatre

401-405 & 415 Geary St. San Francisco, CA 94102





# **SFA130**

## **AMERICAN CONSERVATORY THEATRE**

401-405 & 415 GEARY ST. SAN FRANCISCO, CA 94102

## **APPROVALS** CONSTRUCTION MGR-RF ENGINEER: ZONING MANAGER: UTILITY COORDINATOR: \_\_ PROGRAM REGIONAL MANAGER: NETWORK OPERATIONS MANAGER:

#### **CONTRACTOR NOTES**

DO NOT SCALE DRAWING:

CONTRACTOR SHALL VERIFY ALL PLANS AND EXISTING DIMENSIONS AND CONDITIONS ON THE JOB SITE AND SHALL IMMEDIATELY NOTIFY THE ARCHITECT IN WRITING OF ANY DISCREPANCIES BEFORE PROCEEDING WITH THE WORK OR BE RESPONSIBLE FOR SAME.

#### CODE COMPLIANCE

ALL WORK AND MATERIALS SHALL BE PERFORMED AND INSTALLED IN ACCORDANCE WITH THE CURRENT EDITIONS OF THE FOLLOWING CODES AS ADOPTED BY THE LOCAL GOVERNING AUTHORITIES. NOTHING IN THESE PLANS IS TO BE CONSTRUCTED TO PERMIT WORK NOT CONFORMING TO THESE CODES.

- CALIFORNIA CODE DE REGULATIONS
- . 2010 CALIFORNIA BUILDING CODE . 2010 CALIFORNIA MECHANICAL CODE
- . 2010 CALIFORNIA PLUMBING CODE . 2010 CALIFORNIA ELECTRIC CODE
- . ANY LOCAL BUILDING CODE AMENDMENTS TO THE ABOVE 7. CITY/COUNTY ORDINANCES

HANDICAP REQUIREMENTS: FACILITY IS UNMANNED AN NOT FOR HUMAN HABITATION. HANDICAPPED ACCESS NOT REQUIRED IN ACCORDANCE WITH CALIFORNIA ADMINISTRATIVE STATE CODE PART 2, TITLE 24, CHAPTER 11B, SECTION 1103B.

#### PROJECT DESCRIPTION

THE PROJECT CONSISTS OF THE REMOVAL OF (2) EXISTING ANTENNAS AND INSTALLATION OF (7) (N) PANEL ANTENNAS (7 TOTAL) FLUSH MOUNTED ON (E) THEATRE BUILDING PENTHOUSE & WALL. THE REMOVAL OF EXISTING EQUIPMENT CABINETS AND THE ADDITION OF FIVE NEW CABINETS INSIDE THE BASEMENT EQUIPMENT / STORAGE ROOM.

#### DRIVING DIRECTIONS

FROM AT&T OFFICE - 430 BUSH ST., SAN FRANCISCO

- HEAD EAST ON BUSH ST. TOWARD CLAUDE LN.
   TURN RIGHT AT MONTGOMERY ST.
   TURN RIGHT AT MARKET ST.
- SLIGHT RIGHT AT KEARNY ST
- 5. CONTINUE ONTO GEARY ST. ARRIVE AT SITE LOCATION ON THE LEFT HAND SIDE.

## SHEET

C-1 A-1

A-2

A-3

A-4

A-5

A-6

D-1

D-2

D-3

EN-1

E-3

SITE PLAN

ENLARGED SITE PLAN

ANTENNA LAYOUT

EAST ELEVATION

DETAILS

DETAILS

DETAILS

NORTH ELEVATION

FLECTRICAL NOTES

GROUNDING DETAILS

ELECTRICAL SITE PLAN, NOTES, SINGLE LINE DIAGRAM

LIGHTING PLAN, ALARM RELAY DIAGRAM, SURGE ARRESTOR SINGLE LINE

RF DATA SHEET, COAX CABLE RISER DIAGRAM

GROUNDING PLAN, NOTES, GROUNDING DIAGRAM

EQUIPMENT LAYOUT

	SHEET INDEX						
SHEET	DESCRIPTION	1					
T-1	TITLE SHEET, SITE INFORMATION AND VICINITY MAP	1					
T-1.1	FIRE DEPARTMENT CHECKLIST	1					
T-1.2	RF EXPOSURE REPORT / STRIPING DETAILS	1					
T-2	GENERAL CONSTRUCTION NOTES, GENERAL NOTES, & ABBREVIATIONS LEGEND	1		2	06/22/11	CONSTRUCTION	EN
T-3	GENERAL NOTES & SPECIFICATIONS	1		1	04/04/11	PERMIT	DC
T-4	SIGNAGE & CABLE TAGGING GUIDE	1		0	03/02/11	90% CONSTRUCTION	JPC
T-5	TENANT IMPROVEMENT NOTES	1	lE	CIVIL	ENGINEER:		
C-1	TOPOCRAPHIC SURVEY	1					



430 BUSH ST., 5TH FLOOR SAN FRANCISCO, CA 94108

> **SFA130** USID 12923 FA #1088093

401-405 & 415 GEARY ST. SAN FRANCISCO, CA 94102

06/22/2011

CONSTRUCTION

REV.:=DATE: DESCRIPTION:

PROJECT INFORMATION:

CURRENT ISSUE DATE:=

ISSUED FOR:=

CONSULTING CIVIL ENGINEERS 26455 RANCHO PKWY SOUTH LAKE FOREST CA 92630. CDG#: 08-8034

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JPC	DC	DC
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г	=LICENSER: =		

SHEET TITLE:=

TITLE SHEET SITE INFORMATION AND VICINITY MAP

SHEET NUMBER:

T-1

### **PROJECT TEAM**

#### ARCHITECT/ENGINEER:

CONNELL DESIGN GROUP 26455 RANCHO PKWY SOUTH LAKE FOREST, CA 92630 CONTACT: DAN CONNELL OFFICE PHONE: (949) 753–8807 OFFICE FAX: (949) 753-8833 EMAIL: dconnell@connelldesigngroup.com

#### SITE ACQUISITION:

EVAN SHEPHERD REIFF, MRP AT&T AUTHORIZED REPRESENTATIVE 430 BUSH STREET, 5TH FLOOR SAN FRANCISCO, CA 94108 PHONE: (415) 498-0755 E-MAIL: esreiff@gmail.com

#### RF ENGINEER:

AT&T MOBILITY CONTACT: NAREN PRABHAKAR PHONE: (801) 635-4444 F-MAIL: np.356s@att.com

#### APPLICANT/LESSEE:

AT&T MOBILITY 430 BUSH ST., 5TH FLOOR SAN FRANCISCO CA 94108

ZONING MANAGER: EVAN SHEPHERD REIFF, MRP AT&T AUTHORIZED REPRESENTATIVE 430 BUSH STREET, 5TH FLOOR SAN FRANCISCO, CA 94108 PHONE: (415) 498-0755 E-MAIL: esreiff@gmail.com

#### **CONSTRUCTION MANAGER:**

ERICSSON 430 BUSH STREET, 5TH FLOOR SAN FRANCISCO, CA 94108
CONTACT: EARL EARLEY
PHONE: (925) 595-6513
E-MAIL: EARL\_EARLEY@ericsson.com

#### PROJECT INFORMATION

SITE ADDRESS: 401-405 & 415 GFARY ST.

PROPERTY OWNER: AMERICAN CONSERVATORY THEATER FOUNDATION

SAN FRANCISCO, CA 94108

LATITUDE: 37°47'12.67" N LONGITUDE: 122'24'36.80" W FI EVATION: 69' FT ASML ZONING: C-3-G HEIGHT/BULK: 80-130-F

JURISDICTION: CITY OF SAN FRANCISCO

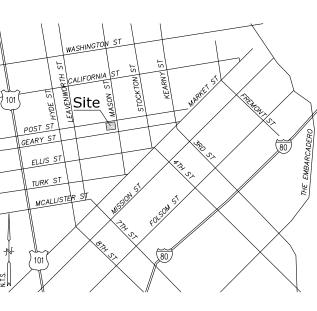
TYPE OF CONSTRUCTION:

BUILDING USE 401-405 GEARY: RESTAURANT/RETAIL/OFFICE BUILDING USE 415 GEARY: THEATRE

NUMBER OF STORIES: 1 STORY & 2 STORIES FOR 401-405

OCCUPANCY: R / A TELEPHONE AT&T POWER: PG&E

### VICINITY MAP



2.06 PERMIT APPLICATION CHECKLIST FOR CELLULAR ANTENNA SITES AND ALL EQUIPMENT SERVING

THIS CHECKLIST SHALL BE PRINTED ON A DRAWING SHEET AND SUBMITTED AS PART OF THE PLANS SUBMITTED WITH ANY BUILDING PERMIT APPLICATION CREATING OR MODIFYING CELLULAR ANTENNA SITES REGARDLESS OF RF EMISSION QUANTITIES. THIS CHECKLIST IS DESIGNED TO ASSIST DESIGNERS. INSTALLERS, PLAN REVIEWERS, AND FIELD INSPECTORS. CHECKLIST SHALL BE PREPARED BY THE DESIGN PROFESSIONAL AND SHALL BE STAMPED AND

THIS DOCUMENT IS NOT ALL-INCLUSIVE OF ALL REQUIREMENTS FOR CELLULAR ANTENNA SITES AND IT IS THE RESPONSIBILITY OF THE DESIGNER TO RESEARCH THE APPLICABLE CODES. DOCUMENTS REFERENCED FOR THIS BULLETIN ARE AS FOLLOWS:

FCC OET BULLETIN 56 - QUESTIONS AND ANSWERS ABOUT BIOLOGICAL EFFECTS AND POTENTIAL HAZARDS OF RADIO FREQUENCY ELECTROMAGNETIC FIELDS (AUGUST 1999) FCC OET BULLETIN 65 - EVALUATING COMPLIANCE WITH FCC GUIDELINES FOR HUMAN EXPOSURE TO RADIOFREQUENCY ELECTROMAGNETIC FIELDS (ED. 97-01:AUGUST 1997)

FCC - A LOCAL GOVERNMENT OFFICIAL'S GUIDE TO TRANSMITTING ANTENNA RF EMISSION SAFETY: RULES, PROCEDURES, AND PRACTICAL GUIDANCE (JUNE 2, 2000)

2007 CALIFORNIA BUILDING CODE (2001 CBC)

2007 CALIFORNIA FIRE CODE (2001 CFC)

2007 CALIFORNIA MECHANICAL CODE (2001 CMC)

2007 SAN FRANCISCO FIRE CODE (2001 SFFC)

COMPLETE.

**EXISTING** 

OR N/A

COMPLETE

**EXISTING** 

COMPLETE

COMPLETE

COMPLETE

N/A

COMPLETE

COMPLETE

COMPLETE

SHFFT

LOCATION

T-1

A-1 A-2

T-1.1

A-1

T-1.3

N/A

A-2

N/A

A-2

2002 NEPA 13 AUTOMATIC SPRINKLER SYSTEMS 2002 NFPA 72 NATIONAL FIRE ALARM CODE DESCRIPTION OF SCOPE OF WORK (BOTH ON THE APPLICATION AND PLANS) SHALL MATCH

THE ACTUAL WORK BEING DONE.

PLANS SHALL INCLUDE PLAN VIEWS AND ELEVATIONS SHOWING ALL EQUIPMENT LOCATIONS

SUBMIT ON A DRAWING SHEET THE SAN FRANCISCO HEALTH DEPARTMENT CELLULAR ANTENNA SITE (WTS) CHECKLIST/PROPOSAL/ENGINEER'S RF REPORT. THE FCC REQUIRES CARRIERS TO INFORM AND PREVENT OCCUPATIONAL EXPOSURE (I.E. BUILDING MAINTENANCE WORKERS, FIRE FIGHTERS, ETC.) THE RF REPORT SHALL NOT SPECIFY LOCKING THE ROOF ACCESS DOOR TO KEEP THE GENERAL PUBLIC OFF OF THE ROOF PER 2001 SFFC 1207.7.1. THE RF REPORT SHALL BE WET STAMPED AND SIGNED BY AN ENGINEER.

DRAWINGS SHALL REFLECT THE STRIPED/EXCLUSION AREAS PER THE ABOVE RF REPORT WITH A MINIMUM RADIUS BEING 1 FOOT.

NOTICE TO WORKERS WARNING SIGNAGE AS APPLICABLE PER THE ABOVE RE REPORT: SIGNAGE SHALL BE IN ENGLISH, CHINESE AND SPANISH; THE SIGNAGE SHALL BE PERMANENTLY MOUNTED AT THE STAIRWELL SIDE OF THE ROOF-ACCESS STAIRWELL, DOOR, IN THE FIRE CONTROL ROOM WITHIN PROXIMITY OF THE CELL-SITE SHUTDOWN SIGNAGE AND ANY OTHER SPACE NECESSARY TO WARN WORKERS (IE. PARAPETS, STREET SIDE OF FIRE ESCAPES); THE SIGNAGE SHALL BE CLEARLY LABELED AND VISIBLE FROM ANY DIRECTION OF APPROACH; THE SIGN SHALL BE WEATHERPROOF WITH CONTRASTING BACKGROUND AND LETTERING COLORS AND SHALL BE READABLE FROM AT LEAST FIFTEEN (15) FEET FROM THE SIGN; THERE IS A YELLOW TRIANGLE AROUND THE ANTENNA SYMBOL (SEE ANSI C95.2-1999); AND LOCATION AND SIGNAGE DETAIL WITH SITE SPECIFIC INFORMATION SHALL BE INCLUDED ON A DRAWING SHEET.

PROVIDE A QUANTITATIVE THREE-DIMENSIONAL PERIMETER OF THE RF LEVELS IF THE ANTENNAS APPEAR TO ENCROACH ON ANY MEANS OF EXITING.

CAMOUFLAGED ANTENNAS SHALL HAVE 4INCH X 4INCH SIGNAGE PERMANENTLY MOUNTED TO THE EXTERIOR OF THE RF SCREEN AS PROVIDED BELOW. THESE ANTENNAS SHALL ALSO HAVE THE STRIPPED EXCLUSION AREA TO THE FULLEST EXTENT OF THE ANTENNA LOCATION WITH A

THE SIGNAGE SHALL BE CLEARLY LABELED AND VISIBLE FROM ANY DIRECTION OF APPROACH EVEN IF ACCESS IS ACHIEVED FROM THE BUILDING FACE (I.E. LADDERS, CHERRY PICKER, ETC.); THE SIGN SHALL BE WEATHERPROOF WITH CONTRASTING BACKGROUND COLOR AND SHALL BE RECOGNIZABLE FROM AT LEAST FIFTEEN (15) FEET FROM THE SIGN; THE SIGN SHALL CONTAIN THE YELLOW TRIANGLE AROUND THE ANTENNA SYMBOL (SEE ANSI C95.2-1999); AND LOCATION AND SIGNAGE DETAIL SHALL BE INCLUDED ON A DRAWING SHEET

8. PLANS SHALL SHOW WHETHER A NEW ELECTRICAL SERVICE IS INSTALLED FOR THE CELL SITE. IN GENERAL, BUILDINGS SHOULD ONLY HAVE ONE ELECTRICAL SERVICE. HOWEVER, WITH THE PRIOR APPROVAL OF THE SAN FRANCISCO FIRE DEPARTMENT AND THE ELECTRICAL INSPECTION DIVISION, BUILDINGS MAY HAVE ONE ADDITIONAL SERVICE TO SERVE ROOFTOP ANTENNA EQUIPMENT, PROVIDED A PERMANENT PLACARD IS PROVIDED AT THE LOCATION OF FACH SERVICE DISCONNECT. STATING THE LOCATION OF THE OTHER AND IDENTIFYING THE EQUIPMENT SERVED BY EACH

9. PROVIDE ROUTE OF ALL CABLES FROM THEIR ORIGIN TO THE EQUIPMENT (PLAN, ELEVATION AND SECTION VIEWS). CABLES/WIRING SHALL NOT BE ALLOWED IN EXIT ENCLOSURES OR IN FRONT OF DRY STANDPIPES (2007 CBC 1020.1.1).

N/A	10. EITHER: PROVIDE A MANUAL BATTERY DISCONNECT:  * INSTRUCTIONAL SIGNAGE SHALL BE PROVIDED ON THE PROCEDURE TO DISCONNECT OR DE-ENERGIZE RADIO FREQUENCY (RF) SIGNAL FOR THE ABOVE MANUAL DISCONNECT FOR THE BATTERIES.  * SIGNAGE SHALL BE PERMANENTLY MOUNTED NEXT TO THE BATTERY'S ELECTRICAL PANEL AN CLEARLY LABELED IN A PHENOLIC LABEL WITH A WHITE BACKGROUND AND BLACK LETTERING. T ITILE BLOCK SHALL BE A RED BACKGROUND AND 1" HIGH WHITE LETTERING. T ITILE BLOCK SHALL BE A RED BACKGROUND AND 1" HIGH WHITE LETTERING. T ITILE BLOCK SHALL BE A RED BACKGROUND AND 1" HIGH WHITE LETTERING. T ITILE BLOCK SHALL BE A RED BACKGROUND AND 1" HIGH WHITE LETTERING. T ITILE BLOCK SHALL BE A RED BACKGROUND AND 1" HIGH WHITE LETTERING.  * THE ACTUAL BREAKER(S) SHALL BE A PHENOLIC LABEL (RED BACKGROUND AND WHITE LETTERING) WITH LETTERING NOT LESS THAN 1/8" HIGH.  * THE SIGNAGE SHALL ALSO BE LIKE POSTED IN THE FCC ROOM WITHIN PROXIMITY OF THE FIRE ALARM PANEL AND BUILDING'S MAIN ELECTRICAL ROOM WITHIN PROXIMITY OF THE MAIN SHUTOFF.  * A COPY OF THE SIGNAGE SHALL BE INCLUDED ON A DRAWING SHEET.  * PROVIDE SFFD APPROVED KEY LOCK BOX FOR EQUIPMENT/ELECTRICAL ROOM FOR BATTERY/EQUIPMENT SHUTDOWN.  * THE PERMANENTLY MOUNTED LABEL ABOVE THE LOCK BOX SHALL READ "SFFD BATTERY DISCONNECT ACCESS KEY" AND SHALL BE A PHENOLIC LABEL WITH A RED BACKGROUND AND WHITE LETTERING.  * LOCATION AND LABEL OF THE KEY LOCK BOX SHALL BE INCLUDED ON A DRAWING SHEET.  OR:  * PROVIDE 24 HOUR/7 DAYS A WEEK TELEPHONE SERVICE CENTER SHUT—DOWN:  * PROVIDE INSTRUCTIONAL SIGNAGE FOR EMERGENCY SHUTDOWN OF THE CELL SITE INCLUDIN:  * THE SIGN SHALL STATE THAT THERE IS NO MANUAL SHUT DOWN FOR THE CELL SITE INCLUDIN:  * THE SIGN SHALL STATE THAT THERE IS NO MANUAL SHUT DOWN FOR THE CELL SITE AND CALL THE CONTACT NUMBER (THE NUMBER SHALL BE PRINTED ON THE SIGN) FOR IMMEDIATE  SHUT—DOWN OF THE SITE 24HR/7DAYS A WEEK.  * THE SIGN SHALL ALSO STATE WHETHER OR NOT THE BACK—UP BATTERY POWER TO THE ANTENNAS IS ALSO SHUT—DOWN.  * THE SIGN SEALL SHALL BE DEFERMANENTLY MOUNTED NEXT T
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	AND BLACK LETTERING. THE TITLE BLOCK SHALL BE A RED BACKGROUND AND 1" HIGH WHITE LETTERING.
	* A COPY OF THE SIGNAGE SHALL BE INCLUDED ON A DRAWING SHEET.
	11. IS A NEW HVAC SYSTEM BEING INSTALLED? YES
	* WHAT IS THE VOLUME OF REFRIGERANT USED BY THE COOLING UNIT(S)?
N/A	* WHAT IS THE TYPE OF REFRIGERANT PER 2007 CMC? * ASSURE COMPLIANCE WITH 2007 CFC SECTION 606. NO
	12. PLANS STATE SEQUENCE OF OPERATIONS FOR ANY NEW DETECTION, DAMPERS, OR FANS.
N/A	PLANS STATE SEQUENCE OF OPENATIONS FOR ANY NEW BELLETION, DAWFERS, OR FAILS.  13. PLANS SHALL CLEARLY SHOW LOCATIONS OF BATTERIES AND BATTERY CABINETS.
N/A	
	14. PLANS SHALL STATE WHETHER THE BUILDING IS FULLY SPRINKLERED OR NOT.
N/A	15. IN FULLY SPRINKLERED BUILDINGS, EQUIPMENT ROOMS SHALL BE PROVIDED WITH SPRINKLERS IN ACCORDANCE WITH NFPA 13.
N/A	16. PROVIDE A TABLE ON A DRAWING SHEET SHOWING THE MANUFACTURER, MODEL, TYPE, AMOUNT (CALLONS OR POUNDS) OF ELECTROLYTE, FLOODED LEAD ACID, NI-CD, VRLA OR LI-IOI PLEASE SHOW DETAILED COMPLIANCE WITH 2007 CFC SECTION 608 ON THE DRAWING SHEETS.
N/A	WHEN COMPLIANCE WITH SECTION 608 OF THE 2007 CALIFORNIA FIRE CODE IS REQUIRED, THE FOLLOWING ADDITIONAL INFORMATION SHALL BE PROVIDED:  * ROOFTOP BATTERY ROOMS EXCEEDING THE ABOVE REQUIREMENTS SHALL BE SEPARATED FROM THE BUILDING AND ANY OPENINGS AS SPECIFIED BY THE 2007 CBC AND CMC.  * PLANS STATE THAT A SEPARATE FIRE DEPARTMENT PERMIT WILL BE OBTAINED FROM SFFD HEADQUARTERS AT 698 2ND ST.
N,	/A /A /A

PREPARED BY: DANIEL CONNELL, PE

FIRM NAME: CONNELL DESIGN GROUP, LLC

PHONE NUMBER: 949-753-8807

ADDRESS: 4685 MACARTHUR COURT, SUITE 480, NEWPORT BEACH, CA 92660

STAMP

430 BUSH ST., 5TH FLOOR SAN FRANCISCO, CA 94108

PROJECT INFORMATION

**SFA130** USID 12923

FA #1088093 401-405 & 415 GEARY ST SAN FRANCISCO, CA 94102

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=CURRENT ISSUE DATE:=

06/22/2011

SSUED FOR:

### CONSTRUCTION

_'	REV.	=DATE:=	DESCRIPTION:	=BY:=
	2	06/22/11	CONSTRUCTION	EN
	1	04/04/11	PERMIT	DC
	0	03/02/11	90% CONSTRUCTION	JPC

CIVIL ENGINEER:

=DRAWN BY:



CONSULTING CIVIL ENGINEERS 26455 RANCHO PKWY SOUTH LAKE FOREST CA 92630 (949) 753-8807 OFFICE - (949) 753-8833 FAX CDG#: 08-8034

\_\_CHK.:\_\_\_\_APV.:=

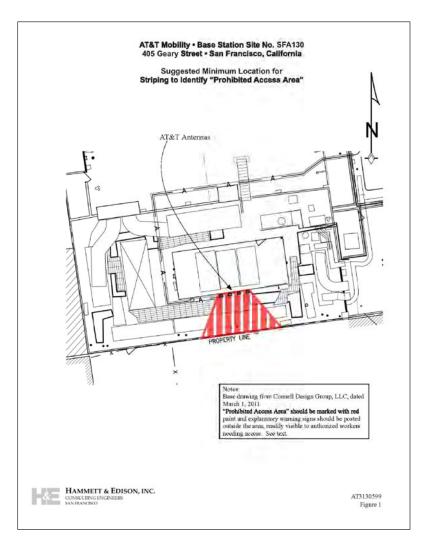
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SHEET TITLE:=

FIRE DEPARTMENT CHECKLIST

SHEET NUMBER:

T-1.1



#### AT&T Mobility • Base Station No. SFA130 405 Geary Street . San Francisco, California

#### Statement of Hammett & Edison, Inc., Consulting Engineers

The firm of Hammett & Edison, Inc., Consulting Engineers, has been retained on behalf of AT&T Mobility, a personal wireless telecommunications carrier, to evaluate proposed modifications to its existing base station (Site No. 8FA130) located at 405 Geary Street in San Francisco, California, for compliance with appropriate guidelines limiting human exposure to radio frequency ("RF") electromagnetic fields

#### Background

The San Francisco Department of Public Health has adopted a 10-point checklist for determining compliance of proposed WTS facilities or proposed modifications to such facilities with prevailing safety standards. The acceptable limits set by the FCC for exposures of unlimited duration are:

Wireless Service	Frequency Band	Occupational Limit	Public Limi
Microwave (Point-to-Point)	5,000-80,000 MHz	5.00 mW/cm <sup>2</sup>	1.00 mW/c
BRS (Broadband Radio)	2,600	5.00	1.00
AWS (Advanced Wireless)	2,100	5.00	1.00
PCS (Personal Communication)	1,950	5.00	1.00
Cellular	870	2.90	0.58
SMR (Specialized Mobile Radio	855	2.85	0.57
700 MHz	700	2.35	0.47
Imost restrictive frequency range	e] 30-300	1.00	0.20

The site was visited by Mr. David Kelly, a qualified field technician contracted by Hammett & Edison, Inc., during normal business hours on December 9, 2010, a non-holiday weekday, and reference has been made to information provided by AT&T, including zoning drawings by Connell Design Group, LLC, dated March I, 2011.

#### Checklist

#### 1 The locution of all existing antennas and facilities at site. Existing RF levels.

AT&T had installed two omnidirectional antennas low on the northeast corner of the American Conservatory Theater, located at 405 Geary Street. There were observed no other wireless base stations installed at the site. Existing RF levels for a person at ground near the site were less than 1% of the most restrictive public exposure limit.

2 The location of all approved (but not installed) antennas and facilities. Expected RF levels from

No other WTS facilities are reported to be approved for this site but not installed.



## AT&T Mobility • Base Station No. SFA130 405 Geary Street • San Francisco, California

3. The number and types of WTS within 100 feet of proposed site and estimates of additive EMR emissions at proposed stie.

There were no other WTS facilities observed within 100 feet of the site.

4. Location fund numbers of Applicant's antennas and back-up facilities per building and location (and number) of other WTS at site.

AT&T proposes to remove its existing antennas and to install seven Andrew Model DBXNH-6565A-R2M directional panel antennas on the building, with up to 8° downtilt. Four antennas oriented toward 170°T would be mounted on the southern face of the penthouse above the upper roof, at an effective height of about 931/2 feet above ground, 8 feet above the roof. The other three antennas, oriented toward 30°T, would be mounted on the northern face of the southeast section of the building. at an effective height of about 46 feet above ground, 17% feet above the lower roof.

5. Power rating (maximum and expected operating power) for all existing an proposed backup

The expected operating power of the AT&T transmitters is reflected in the resulting effective radiated power given in Item 6 below: the transmitters may operate at a power below their maximum rating.

- 6. Total number of watts per installation and total number of watts for all installations at site. The maximum effective radiated power proposed by AT&T in any direction is 8,740 watts, representing simultaneous operation at 1,820 watts for AWS, 4,090 watts for PCS, 2,050 watts for cellular, and 780 watts for 700 MHz service.
- Plot or roof plan showing method of attachment of ortennas, directionality of antennas, and height above roof level. Discuss nearby inhabited building:

The drawings show the proposed internas to be installed as described in Item 4 above. There were noted several taller buildings located at least 170 feet from the antennas...

8. Estimated umbient RF levels for proposed site and identify three-dimensional perimeter where exposure standards are exceeded.

For a person anywhere at ground, the maximum ambient RF exposure level due to the proposed AT&T operation is calculated to be 0.028 mW/cm2, which is 5.1% of the applicable public exposure limit. Ambient RF levels at the site are therefore estimated to be below 6% of the limit. The maximum ealculated level at the adjacent parking structure to the south" is 46% of the public exposure limit. The maximum calculated level at any other building nearby is 14% of the public exposure limit. The three-dimensional perimeter of RF levels equal to the public exposure limit is calculated to extend

. Lornted at least 10 feet away, based on the drawings

HAMMETT & EDISON, INC.

AT3130599 Page 4 of 4

SCALE: 1

### AT&T Mobility . Base Station No. SFA130

no to 64 feet onl from the antenna faces and to much lesser distances above, below, and to the sides, this includes areas on the roof of the building, but does not reach any publicly accessible areas.

#### 9 Describe proposed signage at site.

Due to their mounting locations, the AT&T antennas would not be accessible to the general public, and so no mitigation measures are necessary to comply with the FCC public exposure guidelines. To prevent occupational exposures in excess of the FCC guidelines, no access within 23 feet directly in front of the anternas themselves, such as might occur during maintenance work on the roof, should be allowed while the base staffort is in operation, unless other measures can be demonstrated to ensure that occupational protection requirements are met. Marking "Prohibited Access Areas" with red paint strices out to the idee of the roof in front of the antennas on the penthouse and posting explanatory warning signs at the roof access door and at the antennas, such that the signs would be readily visible from any angle of approach to persons who might need to work within that distance, would be sufficient to meet FCC-adopted guidelines.

The undersigned nathor of this statement is a qualified Professional Engineer, holding California Registration Nos. E-13026 and M-20676, which expire on June 30, 2011. This work has been carried out under his direction, and all statements are true and correct of his own knowledge except, where noted, when data has been supplied by others, which data he believes to be correct.

## AT&T Mobility • Base Station No. SFA130 405 Geary Street • San Francisco, California

#### Conclusion

Based on the information and analysis above, it is the undersigned's professional opinion that the proposed operation of the AT&T Mobility base station located at 405 Geary Street in San Francisco, California, will comply with the prevailing standards for limiting public exposure to radio frequency energy and, therefore, will not for this reason cause a significant impact on the environment. The highest calculated level in publicly accessible areas is much less than the prevailing standards allow for exposures of unlimited duration. This finding is consistent with measurements of actual exposure conditions taken at other operating base stations. Marking roof areas and posting explanatory signs is recommended to establish compliance with occupational exposure limitations.

March 22, 2011

DRAWN BY: =APV.: =CHK.:=

CONNELL DESIGN GROUP, LLC

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26455 RANCHO PKWY SOUTH LAKE FOREST CA 92630.

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CDG#: 08-8034

430 BUSH ST., 5TH FLOOR

SAN FRANCISCO, CA 94108

**SFA130** 

USID 12923 FA #1088093

CNU 3130

401-405 & 415 GEARY ST.

SAN FRANCISCO, CA 94102

06/22/2011

CONSTRUCTION

=REV.:=DATE:===DESCRIPTION:====BY

CONSTRUCTION

PERMIT

90% CONSTRUCTION

PROJECT INFORMATION:

CURRENT ISSUE DATE:

06/22/11

04/04/11

03/02/11

CIVIL ENGINEER:

ISSUED FOR:=

	JPC	DC	DC
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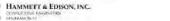
SHEET TITLE:=

RF EXPOSURE LETTER / STRIPING DETAILS

SHEET NUMBER:


T-1.2

ī	Warming stans should comply with OET-65 color, symbol, and content recommendations. Contact information
	should be provided (a.g., a telephone number) to arrange for access to restricted areas. The selection of language(s)
	is not an engineering matter; the San Francisco Department of Public Health recommends that all signs be written
	in Frontish Street, and Chinase



AT3130599 Page 3 of 4

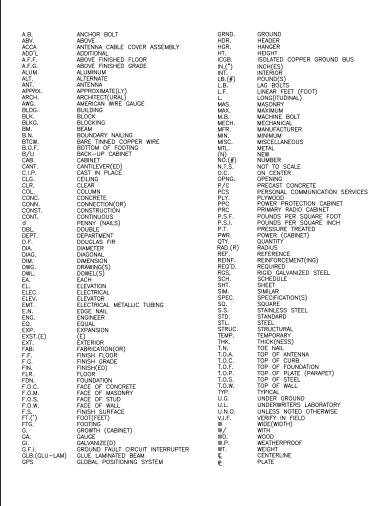HAMMETT & EDISON, INC.



#### **ABBREVIATIONS** GROUT OR PLASTER NEW ANTENNA

ح,2 (E) ANTENNA (E) BRICK  $\otimes$ (E) MASONRY CONCRETE GROUND BUS BAR MECHANICAL GRND. CONN EARTH GRAVEL CADWELD 7///////////// PLYWOOD  $\otimes$ GROUND ACCESS WELL SAND Ε ELECTRIC BOX WOOD CONT. Т TELEPHONE BOX  $\Diamond$ LIGHT POLE - - CENTERLINE 0 FND. MONUMENT - PROPERTY/LEASE LINE SPOT ELEVATION - MATCH LINE Λ - WORK POINT REVISION GROUND CONDUCTOR - T - TELEPHONE CONDUI (x)GRID REFERENCE - E - ELECTRICAL CONDUIT DETAIL REFERENCE - A - COAXIAL CABLE T&E - OVERHEAD SERVICE CONDUCTORS ELEVATION REFERENCE - X - CHAIN LINK FENCING

- 1. THE LATEST EDITION OF THE AMERICAN INSTITUTE OF ARCHITECTS DOCUMENT A201 "GENERAL CONDITIONS OF THE CONTRACT FOR CONSTRUCTION" ARE INCLUDED IN THESE SPECIFICATIONS AS IF COMPLETELY REPRODUCED HEREIN.
- 2. THIS FACILITY IS AN UNOCCUPIED PCS TELECOMMUNICATIONS SITE AND IS EXEMPT FROM DISABLED ACCESS REQUIREMENTS.
- 3. PRIOR TO THE SUBMISSION OF BIDS, THE CONTRACTORS PARTICIPATING SHALL VISIT THE JOB SITE AND FAMILIARIZE THEMSELVES WITH ALL CONDITIONS SHALL VISIT THE JOB SITE AND FAMILIARIZE THEMSELVES WITH ALL CONDITIONS AFFECTING THE (N) PROJECT, WITH THE CONSTRUCTION AND CONTRACT DOCUMENTS, FIELD CONDITIONS, AND CONFIRM THAT THE PROJECT CAN BE ACCOMPLISHED AS SHOWN, PRIOR TO PROCEEDING WITH SUBMISSION, OF BIDS & CONSTRUCTION, SHOULD ANY ERRORS, OMISSION, OR DISCREPANCIES BE FOUND, THE CONTRACTORS SHALL IMMEDIATELY NOTIFY PROJECT MANAGER, AND THE ARCHITECT IN WRITING. IN THE EVENT OF DISCREPANCIES, THE CONTRACTOR SHALL INCLUDE THE MORE COSTLY OR EXTENSIVE WORK IN THE BID, UNLESS SPECIFICALLY DIRECTED OTHERWISE. IF A DISCREPANCY EXISTS AND THE PROJECT MANAGER AND ARCHITECT ARE NOT NOTIFIED, THE GENERAL CONTRACTOR SHALL BE HELD RESPONSIBLE FOR ALL COSTS INCURRED TO REPAIR OR CORRECT ALL PROBLEMS THAT RESULT.
- 4. DRAWINGS SHALL NOT BE SCALED. FIGURED DIMENSIONS HAVE 4. DHAWINGS SHALL NOT BE SCALED. FIGURED DIMENSIONS HAVE PRECEDENCE OVER DRAWING SCALE AND DETAIL DRAWINGS HAVE PRECEDENCE OVER SMALL SCALE DRAWINGS. CONTRACTOR SHALL CHECK ACCURACY OF ALL DIMENSIONS IN THE FIELD. UNLESS SPECIFICALLY NOTED, DO NOT FABRICATE ANY MATERIALS, OR BEGIN ANY CONSTRUCTION UNTIL THE ACCURACY OF DRAWING DIMENSIONS HAS BEEN VERIFIED AGAINST ACTUAL FIELD DIMENSIONS.
- 5. CONTRACTOR SHALL NOTIFY THE PROJECT MANAGER AND THE ARCHITECT IF ANY DETAILS ARE CONSIDERED IMPRACTICAL, UNSUITABLE, UNSAFE, NOT WATERPROOF, OR NOT WITHIN CUSTOMARY TRADE PRACTICE. IF WORK IS PERFORMED, IT WILL BE ASSUMED THAT THERE IS NO OBJECTION TO ANY DETAIL. DETAILS ARE INTENDED TO SHOW THE END RESULT OF THE DESIGN. MINOR MODIFICATIONS MAY BE REQUIRED TO SUIT JOB CONDITIONS, AND SHALL BE INCLUDED AS PART OF THE WORK.
- 6. (E) ELEVATIONS AND LOCATIONS TO BE JOINED SHALL BE VERIFIED BY THE CONTRACTOR BEFORE CONSTRUCTION. IF THEY DIFFER FROM THOSE SHOWN ON THE PLANS, THE CONTRACTOR SHALL NOTIFY THE PROJECT MANAGER, AND THE ARCHITECT SO THAT MODIFICATIONS CAN BE MADE BEFORE PROCEEDING WITH THE WORK.
- . ALL SYMBOLS AND ABBREVIATIONS USED ON THE DRAWINGS ARE CONSIDERED CONSTRUCTION STANDARDS. IF THE CONTRACTOR HAS QUESTIONS REGARDING THEIR EXACT MEANING, THE PROJECT MANAGER, AND THE ARCHITECT SHALL BE NOTIFIED FOR CLARIFICATION BEFORE THE CONTRACTOR PROCEEDS WITH THE WORK.
- 8. THE CONTRACTOR SHALL OBTAIN AND PAY FOR PERMITS, LICENSES AND INSPECTIONS NECESSARY FOR PERFORMANCE OF THE WORK AND INCLUDE THOSE IN THE COST OF THE WORK TO ATTWS.
- 9. THE CONTRACTOR SHALL SUPERVISE AND DIRECT ALL WORK, USING THE BEST SKILL AND ATTENTION. HE SHALL BE SOLELY RESPONSIBLE FOR ALL CONSTRUCTION MEANS, METHODS, TECHNIQUES, PROCEDURES AND SEQUENCES, AND FOR COORDINATING ALL PORTIONS OF THE WORK UNDER THE CONTRACT, INCLUDING CONTACT AND COORDINATION WITH THE IMPLEMENTATION ENGINEER AND WITH THE LANDLORD'S AUTHORIZED REPRESENTATIVE'S
- 10. WORKMANSHIP THROUGHOUT SHALL BE OF THE BEST QUALITY OF THE TRADE INVOLVED, AND SHALL MEET OR EXCEED THE FOLLOWING MINIMUM REFERENCE STANDARDS FOR QUALITY AND PROFESSIONAL CONSTRUCTION

NRCA - NATIONAL ROOFING CONTRACTORS ASSOCIATION O'HARE INTERNATIONAL CENTER 10255 W. HIGGENS ROAD, SUITE 600 ROSEMONT, IL

SMACNA - SHEET METAL AND AIR CONDITIONING CONTRACTORS NATIONAL ASSOCIATION 4201 LAFAYETTE CENTER DRIVE CHATTILY, VA 22021-1209

ITLP - INTERNATIONAL INSTITUTE FOR LATH AND PLASTER 820 TRANSFER ROAD ST. PAUL, MN 55114-1406

AMA — ADHESIVE MANUFACTURERS ASSOCIATION 401 NORTH MICHIGAN AVENUE, SUITE 2400 CHICAGO, IL 60611

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- 11. THE CONTRACTOR SHALL VERIFY, COORDINATE, AND PROVIDE ALL NECESSARY BLOCKING, BACKING, FRAMING, HANGERS OR OTHER SUPPORTS FOR ALL ITEMS REQUIRING THE SAME.
- 12. ALL WORK PERFORMED AND MATERIALS INSTALLED SHALL BE IN STRICT 12. ALL WORK PERFORMED AND MATERIALS INSTALLED SHALL BE IN STRICT ACCORDANCE WITH ALL APPLICABLE CODES, REGULATIONS AND ORDINANCES. CONTRACTORS SHALL GIVE ALL NOTICES AND COMPLY WITH ALL LAWS, ORDINANCES, RULES, REGULATIONS AND LAWFUL ORDERS OF ANY PUBLIC AUTHORITY REGARDING THE PERFORMANCE OF THE WORK. MECHANICAL AND ELECTRICAL SYSTEMS SHALL BE INSTALLED IN ACCORDANCE WITH ALL APPLICABLE MUNICIPAL AND UTILITY COMPANY SPECIFICATIONS, LOCAL AND STATE JURISDICTIONAL CODES, ORDINANCES AND APPLICABLE REGULATIONS. CONTRACTORS SHALL COMPLY WITH STATE DEPARTMENT OF INDUSTRIAL DEPOLIPMENTS. REGULATIONS AND DIVISION OF INDUSTRIAL SAFETY (OSHA) REQUIREMENTS.

- 13. CONTRACTORS SHALL PROTECT THE OWNERS' PROPERTY FROM DAMAGE WHICH MAY OCCUR DURING CONSTRUCTION. ANY DAMAGE TO NEW AND (E) CONSTRUCTION, STRUCTURE, LANDSCAPING, CURBS, STAIRS, OR EQUIPMENT, ETC., SHALL BE IMMEDIATELY REPAIRED OR REPLACED TO THE SATISFACTION THE PROPERTY OWNER, OR HIS REPRESENTATIVE, AND ATTWS' REPRESENTATIVE, AT THE EXPENSE OF THE CONTRACTOR.
- 14. THE CONTRACTOR SHALL BE RESPONSIBLE FOR, AND SHALL REPLACE OR REMEDY, ANY FAULTY, IMPROPER, OR INFERIOR MATERIALS OR WORKMANSHIP, OR ANY DAMAGE WHICH SHALL APPEAR WITHIN ONE YEAR AFTER THE COMPLETION AND ACCEPTANCE OF THE WORK UNDER THIS CONTRACT BY
- 15. ALL SITE WORK SHALL BE CAREFULLY COORDINATED BY GENERAL CONTRACTOR WITH LOCAL UTILITY COMPANY, TELEPHONE COMPANY, AND ANY CONTRACTOR WITH LOCAL UTILITY COMPANY, TELEPHONE COMPANY, AND ANY OTHER UTILITY COMPANIES HAVING JURISDICTION OVER THIS LOCATION. IT SHALL BE THE RESPONSIBILITY OF THE GENERAL CONTRACTOR TO LOCATE ALL (E) UTILITIES, WHETHER SHOWN HEREIN OR NOT, AND TO PROTECT THEM FROM DAMAGE. THE CONTRACTORS SHALL BEAR ALL EXPENSES FOR REPAIR OR REPLACEMENT OF UTILITIES OR OTHER PROPERTY DAMAGED IN CONJUNCTION WITH THE EXECUTION OF WORK.
- 16. THE CONTRACTOR SHALL BE RESPONSIBLE FOR THE COMPLETE SECURITY OF THE PROJECT SITE WHILE THE JOB IS IN PROGRESS AND UNTIL THE JOB IS COMPLETED AND ACCEPTED BY ATTWS.
- THE CONTRACTOR SHALL PROVIDE TEMPORARY WATER, POWER AND TOILET FACILITIES AS REQUIRED BY THE PROPERTY OWNER AND THE CITY OR
- 18. THE LATEST EDITION OF ALL PERMITTED AND APPROVED PLANS PERTAINING TO THIS PROJECT SHALL BE KEPT IN A PLAN BOX AND SHALL NOT BE USED BY WORKERS. ALL CONSTRUCTION SETS SHALL REFLECT THE SAME INFORMATION. THE CONTRACTOR SHALL ALSO MAINTAIN IN GOOD CONDITION, ONE COMPLETE SET OF PLANS WITH ALL REVISIONS, ADDENDA AND CHANCE ORDERS, ON THE PREMISES AT ALL TIMES. THESE ARE TO BE UNDER THE CARE OF THE JOB SUPERINTENDENT.
- 19. THE CONTRACTOR SHALL REMOVE ALL RUBBISH AND WASTE MATERIALS ON A DAILY BASIS, AND SHALL EXERCISE STRICT CONTROL OVER JOB CLEANING THROUGHOUT CONSTRUCTION, INCLUDING FINAL CLEANUP UPON COMPLETION OF WORK. ALL AREAS ARE TO BE LEFT IN A BROOM CLEAN CONDITION AT THE END OF EACH DAY. ALL MATERIALS COLLECTED DURING CLEANING OPERATIONS SHALL BE DISPOSED OF OFF-SITE BY THE GENERAL CONTRACTOR.
- 20. THE GENERAL CONTRACTOR MUST PERFORM WORK DURING PROPERTY OWNER'S PREFERRED HOURS TO AVOID DISRUPTION OF NORMAL ACTIVITY.
- 22. SEAL ALL PENETRATIONS THROUGH FIRE-RATED AREAS WITH U.L. LISTED OR FIRE MARSHALL APPROVED MATERIALS IF AND WHERE APPLICABLE TO THIS
- 23. PROVIDE A PORTABLE FIRE EXTINGUISHER WITH A RATING OF NOT LESS THAN 2-A OR 2-A, 10-BC WITHIN 75 FEET TRAVEL DISTANCE TO ALL PORTIONS OF THE PROJECT CONSTRUCTION AREA.
- 24. ELECTRICAL POWER SYSTEM SHALL BE GROUNDED PER NEC ARTICLES 250 AND 810.
- 25. ALL NEW OPENINGS IN THE EXTERIOR ENVELOPE OF CONDITIONED SPACES SUCH AS AT WALL AND ROOP PENETRATIONS SHALL BE CAULKED OR SEALED TO LIMIT INFILITRATION OF AIR AND MOISTURES.
- 26. U.N.O., CONTRACTOR SHALL PROVIDE CLOSE-OUT PACKAGE TO ATTWS HICH WILL INCLUDE:

(CONTRACTOR SHALL REFER TO THEIR CURRENT CONTRACT FOR A COMPLETE

- . BUILDING PERMITS/ELECTRICAL PERMITS
  . FINAL INSPECTION CARD
- STAMPED BUILDING PERMIT PLANS
  GROUNDING TEST
  SWEEP TEST
  CONCRETE TEST

- . SPECIAL INSPECTION REPORTS

- G. SPECIAL INSPECTION REPORTS
  H. WARRANTIES, MANUAL, EQUIPMENT SPECIFICATIONS
  L. SUBCONTRACTOR CONTACT LIST
  J. RED LINED ASBUILTS
  K. CONSTRUCTION PROCESS PHOTOS
  L. SITE COMPLETION PHOTOS
  M. A WRITTEN REPORT ON ANTENNA SERIAL NUMBER FOR EACH SECTOR
  M. A WRITTEN REPORT ON ANTENNA SERIAL NUMBER FOR EACH SECTOR
  M. AMERICATUREDE'S DESCRIPMENTS PERPORT FOR EACH ANTENNA N. MANUFACTURER'S PERFORMANCE REPORT FOR EACH ANTENNA

CONTRACTOR SHALL REFER TO THEIR CURRENT CONTRACT FOR A COMPLETE LIST OF DELIVERABLES.

- 1. PLANS ARE INTENDED TO BE A DIAGRAMMATIC OUTLINE ONLY, UNLESS NOTED OTHERWISE. THE WORK SHALL INCLUDE FURNISHING MATERIALS, EQUIPMENT, APPURTENANCES AND LABOR NECESSARY TO COMPLETE ALL INSTALLATIONS AS INDICATED ON THE DRAWINGS.
- 2. THE CONTRACTOR SHALL OBTAIN, IN WRITING, AUTHORIZATION TO PROCEED BEFORE STARTING WORK ON ANY ITEM NOT CLEARLY DEFINED OR IDENTIFIED BY THE CONTRACT DOCUMENTS.
- 3. CONTRACTOR SHALL CONTACT USA (U/G SERVICE ALERT,) AT (800) 227—2600, FOR UTILITY LOCATIONS, 48 HRS BEFORE PROCEEDING WITH ANY EXCAVATION, SITE WORK OR CONSTRUCTION.
- THE CONTRACTOR SHALL INSTALL ALL EQUIPMENT AND MATERIALS IN ACCORDANCE WITH MANUFACTURER'S RECOMMENDATIONS LINESS SPECIFICALLY INDICATED OTHERWISE, OR WHERE LOCAL CODES OR REGULATIONS TAKE
- 5. ALL CONSTRUCTION SHALL BE IN ACCORDANCE WITH THE CBC'S REQUIREMENTS REGARDING EARTHQUAKE RESISTANCE, FOR, BUT NOT LIMITED TO, PIPING, LIGHT FIXTURES, CEILING GRID, INTERIOR PARTITIONS, AND MECHANICAL EQUIPMENT. ALL WORK MUST COMPLY WITH LOCAL EARTHQUAKE CODES AND BECLIA WITHOUS
- 6. REPRESENTATIONS OF TRUE NORTH, OTHER THAN THOSE FOUND ON THE PLOT OF SURVEY DRAWING, SHALL NOT BE USED TO IDENTIFY OR ESTABLISH THE BEARING OF TRUE NORTH AT THE SITE. THE CONTRACTOR SHALL RELY SOLELY ON THE PLOT OF SURVEY DRAWING AND ANY SURVEYOR'S MARKINGS AT THE SITE FOR THE ESTABLISHMENT OF TRUE NORTH, AND SHALL NOTIFY
  THE ARCHITECT/ENGINEER PRIOR TO PROCEEDING WITH THE WORK IF ANY
  DISCREPANCY IS FOUND BETWEEN THE VARIOUS ELEMENTS OF THE WORKING
  DRAWINGS AND THE TRUE NORTH ORIENTATION AS DEPICTED ON THE CIVIL SURVEY. THE CONTRACTOR SHALL ASSUME SOLE LIABILITY FOR ANY FAILURE TO NOTIFY THE ARCHITECT/ENGINEER.
- 7. THE BUILDING DEPARTMENT ISSUING THE PERMITS SHALL BE NOTIFIED AT LEAST TWO WORKING DAYS PRIOR TO THE COMMENCEMENT OF WORK, OR AS OTHERWISE STIPULATED BY THE CODE ENFORCEMENT OFFICIAL HAVING
- 8. THE ARCHITECT/ENGINEER, CONNELL DESIGN GROUP, LLC., AND REPRESENTATIVES OF THE OWNER, MUST BE NOTIFIED AT LEAST TWO FULL DAYS PRIOR TO COMMENCEMENT OF CONSTRUCTION.
- 9. DO NOT EXCAVATE OR DISTURB BEYOND THE PROPERTY LINES OR LEASE LINES, UNLESS OTHERWISE NOTED.
- 10. ALL (E) UTILITIES, FACILITIES, CONDITIONS, AND THEIR DIMENSIONS SHOWN ON PLANS HAVE BEEN PLOTTED FROM AVAILABLE RECORDS. THE ARCHITECT/ENGINEER AND THE OWNER ASSUME NO RESPONSIBILITY WHATSOEVER AS TO THE SUFFICIENCY OR ACCURACY OF THE INFORMATION SHOWN ON THE PLANS, OR THE MANNER OF THEIR REMOVAL OR ADJUSTMENT. CONTRACTORS SHALL BE RESPONSIBLE FOR DETERMINING EXACT LOCATION OF ALL (E) UTILITIES AND FACILITIES PRIOR TO START OF CONSTRUCTION. CONTRACTORS SHALL ALSO OBTAIN FROM EACH UTILITY COMPANY DETAILED INFORMATION RELATIVE TO WORKING SCHEDULES AND METHODS OF REMOVING OR ADJUSTING (E) UTILITIES.
- 11. CONTRACTOR SHALL VERIFY ALL (E) UTILITIES, BOTH HORIZONTALLY AND VERTICALLY, PRIOR TO START OF CONSTRUCTION. ANY DISCREPANCIES OF DOUBTS AS TO THE INTERPRETATION OF PLANS SHOULD BE IMMEDIATELY REPORTED TO THE INTERPRETATION OF PERIOD SHOULD BE IMMEDIATED.

  AND NO FURTHER WORK SHALL BE PERFORMED UNTIL THE DISCREPANCY IS CHECKED AND CORRECTED BY THE ARCHITECT/ENGINEER. FAILURE TO SECURE SUCH INSTRUCTION MEANS CONTRACTOR WILL HAVE WORKED AT HIS/HER OWN
- 12. ALL NEW AND (E) UTILITY STRUCTURES ON SITE AND IN AREAS TO BE DISTURBED BY CONSTRUCTION SHALL BE ADJUSTED TO FINISH ELEVATIONS PRIOR TO FINAL INSPECTION OF WORK.
- 13. ANY DRAIN AND/OR FIELD TILE ENCOUNTERED DURING CONSTRUCTION SHALL BE RETURNED TO ITS ORIGINAL CONDITION PRIOR TO COMPLETION OF WORK. SIZE, LOCATION AND TYPE OF ANY U/G UTILITIES OR IMPROVEMENTS SHALL BE ACCURATELY NOTED AND PLACED ON "AS-BUILT" DRAWINGS BY GENERAL CONTRACTOR, AND ISSUED TO ARCHITECT/ENGINEER AT COMPLETION OF DRAWINGS BY CONTRACTOR, AND ISSUED TO ARCHITECT/ENGINEER AT COMPLETION
- 14. ALL TEMPORARY EXCAVATIONS FOR THE INSTALLATION OF FOUNDATIONS UTILITIES, ETC., SHALL BE PROPERLY LAID BACK OR BRACED IN ACCORDANCE WITH CORRECT OCCUPATIONAL SAFETY AND HEALTH ADMINISTRATION (OSHA)
- 15. INCLUDE MISC. ITEMS PER ATTWS SPECIFICATIONS.



430 BUSH ST., 5TH FLOOR SAN FRANCISCO, CA 94108

PROJECT INFORMATION

**SFA130** USID 12923 FA #1088093

CNU 3130 401-405 & 415 GEARY ST SAN FRANCISCO, CA 94102

=CURRENT ISSUE DATE:=

06/22/2011

ISSUED FOR:

CONSTRUCTION

PEV - DATE - DESCRIPTION -

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	2	06/22/11	CONSTRUCTION	EN
	1	04/04/11	PERMIT	DC
	0	03/02/11	90% CONSTRUCTION	JPC

CIVIL ENGINEER:

DRAWN BY:



CONSULTING CIVIL ENGINEERS 26455 RANCHO PKWY SOUTH LAKE FOREST CA 92630 (949) 753-8807 OFFICE - (949) 753-8833 FAX CDG#: 08-8034

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SHEET TITLE:=

GENERAL CONSTRUCTION NOTES, GENERAL NOTES, & ABBREVIATIONS LEGEND

SHEET NUMBER:

LEGEND 4 GENERAL NOTES 2 GENERAL CONSTRUCTION NOTES

#### CONCRETE NOTES:

- 1. ALL FOOTINGS SHALL REST ON FIRM NATURAL SOIL OR APPROVED COMPACTED FILL.
- 2. AGGREGATE FOR CONCRETE SHALL CONFORM TO ASTM C-33 STANDARDS
- 3. FLOOR SLABS SHALL CONFORM TO ASTM C-38 STANDARDS AND SHALL BE AT LEAST. 3 1/2 INCHES THICK- SEE FOUNDATION PLANS FOR REINFORCEMENT, BASE, UNDERPAYMENT, VAPOR BARRIER OR OTHER SPECIFIC REQUIREMENTS.
- 4. FLOOR SLABS SHALL BE LEVEL OR TRUE SLOPES AS SHOWN ON DRAWINGS. TOLERANCE: 1/8 INCH IN 10 FEET.
- 5. ALL FOOTINGS HAVE BEEN DESIGNED BASED UPON AN ASSUMED SOIL BEARING PRESSURE OF 1,500 PSF UNLESS NOTED OTHERWISE.
- 6. PROVIDE LIGHT BROOM FINISH ON ALL EXPOSED CONCRETE UNLESS NOTED OTHERWISE.
- 7. PRIOR TO COMMENCING ANY FOUNDATION WORK, COORDINATE WORK WITH ANY EXISTING UTILITIES. FOUNDATIONS SHALL BE LOWERED WHERE REQUIRED TO AVOID UTILITIES.
- 8. ALL EDGES OF PERMANENTLY EXPOSED CONCRETE SURFACES SHALL BE CHAMFERED 3/4" UNLESS NOTED OTHERWISE
- 9. FORMWORK SHALL REMAIN IN PLACE UNTIL CONCRETE HAS OBTAINED AT LEAST 90 COMPRESSIVE STRENGTH. THE CONTRACTOR SHALL PROVIDE ALL SHORING AND RESHORING.
- 10. PROVIDE CONCRETE SLABS OVER A 6 MIL POLYETHYLENE VAPOR BARRIER AND 4" OF POROUS FILL UNLESS
- 11. ALL POROUS FILL MATERIAL SHALL BE A CLEAN GRANULAR MATERIAL WITH 100 PER ASTM SIEVE. POROUS FILL SHALL BE COMPACTED TO 90%.
- 12. WALKWAYS AND OTHER EXTERIOR SLABS ARE NOT INDICATED ON THE STRUCTURAL DRAWINGS. SEE THE SITE PLAN AND ARCHITECTURAL DRAWINGS FOR LOCATIONS, DIMENSIONS, ELEVATIONS, JOINTING DETAILS AND FINISH DETAILS. PROVIDE 4" WALKS REINFORCED WITH 6x6 - WI .4xWI .4 WWF UNLESS OTHERWISE NOTED.
- 13. ALL CONCRETE MATERIALS AND WORKMANSHIP SHALL CONFORM TO CHAPTER 19 OF THE CBC AND TO ALL REQUIREMENTS OF ACI 301-96, "SPECIFICATIONS FOR STRUCTURAL CONCRETE FOR BUILDINGS," EXCEPT AS
- MIX DESIGN REQUIREMENTS: (UNLESS NOTED OTHERWISE)
   A. CEMENT SHALL BE TYPE V.
   B. COMPRESSIVE STRENGTH = 2.500 PSI
- C. CONCRETE SLUMP SHALL NOT EXCEED 5".

  D. WATER CEMENT RATIO = 0.45

#### STORM WATER POLLUTION PREVENTION NOTES:

STORMWATER POLLUTION PREVENTION DEVICES AND PRACTICES SHALL BE INSTALLED AND/OR INSTITUTED AS NECESSARY TO ENSURE COMPLIANCE TO THE LOCAL WATER QUALITY STANDARDS CONTAINED IN THE APPLICABLE MUNICIPAL CODES AND ANY EROSION CONTROL PLANS ASSOCIATED WITH THIS PROJECT. ALL SUCH DEVICES AND PRACTICES SHALL BE MAINTAINED, INSPECTED AND/OR MONITORED TO ENSURE ADEQUACY AND PROPER FUNCTION THROUGHOUT THE DURATION OF THE CONSTRUCTION PROJECT.

COMPLIANCE TO THE WATER QUALITY STANDARDS AND ANY EROSION CONTROL PLAN ASSOCIATED WITH THIS PROJECT INCLUDES, BUT IS NOT LIMITED TO THE FOLLOWING REQUIREMENTS:

- 1. SEDIMENTS AND OTHER POLLUTANTS SHALL BE RETAINED ON SITE UNTIL PROPERLY DISPOSED OF, AND MAY NOT BE TRANSPORTED FROM THE SITE VIA SHEET FLOW, SWALES, AREA DRAINS, NATURAL DRAINAGE COURSES NOT BE IMPROPORTIED FROM THE SITE OF STILET FROM STILET FROM STILET FROM BEING TRANSPORTED FROM THE SITE BY THE FORCES OF WIND AND WATER FLOW.
- 3. Fuels, Oils, Solvents, and other toxic materials shall be stored in accordance with their listing and are not to contaminate the soil and sufface waters. All must be cleaned up immediately and disposed of in a proper manner. Spills may not be washed into the drainage system, nor be allowed to settle or inflitrate into soil.
- 4. EXCESS OR WASTE CONCRETE MAY NOT BE WASHED INTO THE PUBLIC WAY OR ANY OTHER DRAINAGE SYSTEM. PROVISIONS SHALL BE MADE TO RETAIN CONCRETE WASTES ON SITE UNTIL THEY CAN BE DISPOSED OF AS SOLID WASTES.
- 5. TRASH AND CONSTRUCTION SOLID WASTES SHALL BE DEPOSITED INTO A COVERED RECEPTACLE TO PREVENT
- 6. SEDIMENTS AND OTHER MATERIALS MAY NOT BE TRACKED FROM THE SITE BY VEHICULAR TRAFFIC. THE CONSTRUCTION ENTRANCE ROADWAYS MUST BE STABILIZED SO AS TO INHIBIT SEDIMENTS FROM BEING DEPOSITED INTO THE PUBLIC WAY. ACCIDENTAL DEPOSITS SHALL BE SWEPT UP IMMEDIATELY AND MAY NOT BE WASHED DOWN BY RAIN OR OTHER MEANS.
- 7. ANY SLOPES WITH DISTRIBUTED SOILS OR REMOVED VEGETATION SHALL BE STABILIZED TO INHIBIT EROSION BY WIND AND WATER.
- 8. STORMWATER POLLUTION PREVENTION DEVICES AND/OR PRACTICES SHALL BE MODIFIED AS NEEDED AS THE PROJECT PROGRESSES TO ENSURE EFFECTIVENESS.

#### FLASHING AND SHEET METAL

- 1. ALL FLASHING, COUNTER FLASHING AND COPING WHEN OF METAL SHALL BE OF NOT LESS THAN NO. 26 U.S.

  1. THE CONTRACTOR SHALL PREPARE SURFACES, FURNISH ALL PAINT, MATERIAL, LABOR AND EQUIPMENT REQUIRED FOR THE PAINTING OF ALL SURFACES AS REQUIRED.
- 2. FLASH AND COUNTER FLASH AT ALL ROOF TO WALL CONDITIONS. G.J. FLASH AND CAULK WOOD BEAMS AND OUTLOOKERS PROJECTING THROUGH EXTERIOR WALLS OR ROOF SURFACES.
- 3. FLASH ALL EXTERIOR OPENINGS WITH APPROVED WATERPROOFING, WHICH CONFORMS TO STANDARD OF LOCAL
- 4. ALL METAL MUST BE GALVANIZED AFTER FABRICATION.
- 5. ALL SHEET METAL TO BE "A" MINIMUM 20 GAUGE.

#### SUSPENDED CEILING SYSTEM

- 1. HANGERS SHALL BE ATTACHED TO THE BOTTOM EDGE OF THE WOOD TRUSSES AT PANEL POINTS OR TO THE VERTICAL FACE OF THE WOOD GLU-LAMS NEAR THE BOTTOM EDGE. BOTTOM EDGE ATTACHMENT DEVICES SHALL BE AN APPROVED TYPE. DO NOT INSTALL HANGERS FROM 2"X4" SUB-PURLINS.
- 2. ALL LIGHT FIXTURES AND AIR DISTRIBUTION PRODUCTS SHALL BE POSITIVELY ATTACHED TO THE SUSPENDED CELLING SYSTEM. THE ATTACHMENT DEVICE SHALL HAVE A CAPACITY OF 100 PERCENT OF THE LIGHT FIXTURE WEIGHT ACTING IN ANY DIRECTION.
- 3. NO. 12 GAUGE HANGERS SHALL BE ATTACHED TO THE GRID MEMBERS WITHIN 3" OF EACH CORNER OF EACH TEST AND INSPECTIONS:
- 4. LIGHTING FIXTURE WEIGHING MORE THAN 20 POUNDS BUT LESS THAN 56 POUNDS SHALL HAVE IN ADDITION TO THE REQUIREMENTS OUTLINED ABOVE, TWO NO. 12 CAUGE HANGERS CONNECTED FROM THE FIXTURE HOUSING TO THE CEULING SYSTEM HANGERS OR TO THE STRUCTURE ABOVE. THESES WIRES MAY BE SLACK. PROVIDE A TOTAL OF SIX WIRES PER LIGHT FIXTURE.
- 5. LIGHTING FIXTURES WEIGHING 56 POUNDS OR MORE SHALL BE SUPPORTED DIRECTLY FROM THE STRUCTURE ABOVE BY APPROVED HANGERS.

#### THERMAL & MOISTURE PROTECTION INSULATION

- 1. COMPLY WITH ALL APPLICABLE REQUIREMENTS OF THE STATE ENERGY REGULATIONS.
- 2. PROVIDE R-13 MINIMUM KRAFT-FACED BATT. INSULATION AT WALLS UNLESS NOTED OTHERWISE, AND R-19 MINIMUM AT CEILINGS TO COMPLETELY ENCLOSE EQUIPMENT ROOM. PLACE VAPOR BARRIERS ON WARM SIDE OF
- INSULATE WALLS BETWEEN EQUIPMENT ROOM AND ADJACENT ROOMS AND INSULATION WAREHOUSE. INSULATE BETWEEN JAMBS AND FRAMING, BEHIND HEADER JOISTS AND IN SOFFITS OVER EXTERIOR SPACE.
- 4. PENETRATIONS OF ROOF MEMBRANES SHALL BE PATCHED/FLASHED AND MADE WATERTIGHT USING LIKE MATERIALS IN ACCORDANCE WITH NRCA ROOFING STANDARDS AND DETAILS. CONTRACTOR SHALL OBTAIN DETAILING CLARFICATION FOR SITE-SPECIFIC CONDITIONS FORM ARCHITECT/ENGINEER, IF NECESSARY, BEFORE PROCEEDING, PLANS ARE NOT TO BE SCALED AND ARE INTENDED TO BE A DIAGRAMMATIC OUTLINE ONLY, UNLESS NOTED OTHERWISE.

#### DOORS

- 1. PROVIDE SEAMLESS FLUSH TYPE DOORS, 18 GAUGE, WELDED CONSTRUCTION SHOP PRIMED, PREPARED FOR HARDWARE WITH TOP AND BOTTOM CLOSURES. WELD EXPOSED JOINTS CONTINUOUSLY, GRIND, DRESS AND MAKE SMOOTH, FLUSH AND INVISIBLE. PREPARE FRAME TO RECEIVE MORTISED AND CONCEALED FINISH HARDWARE DOOR FRAME.
- 2. WHERE REQUIRED TO BE RATED, PROVIDE FIRE-RATED DOORS WITH UL LABEL ATTACHED IN AN INCONSPICUOUS LOCATION. WHERE DOORS ARE EXPOSED TO OUTSIDE WEATHER CONDITIONS. PROVIDE DOORS FABRICATED WITH G60 GALVANIZING.
- 2. INTERIOR: 20 GAUGE THICK MATERIAL, COMMERCIAL SERIES "C", TO SUIT GRADE AND MODEL OF DOOR, LABELED FRAME WHERE REQUIRED.
- 3. IN GENERAL INSTALL DOORS AND FRAMES IN ACCORDANCE WITH SDI 100 AND 105, RESPECTIVELY.
- 4. DOORS SHALL BE WEATHER-STRIPPED AGAINST AIR INFILTRATION IN COMPLIANCE WITH TITLE 24 OF THE STATE ADMINISTRATION CODE.
- 5. KEYING: ALL LOCKS ARE TO BE KEYED AS PER OWNERS INSTRUCTIONS

#### **PAINTING**

- PAINTS TO BE APPLIED IN ALL WORKMANLIKE MANNER. UPON COMPLETION, REMOVE ALL MATERIALS AND DEBRIS CAUSED BY THIS CONTRACTOR, ALL HARDWARE, FLOORS, GLASS, FRAMES FIXTURES AND THE LIKE SHALL BE THOROUGHLY CLEANED OF PAINT.
- 3. REGULATORY REQUIREMENTS: ALL MATERIALS MUST COMPLY WITH AIR POLLUTION CONTROL REGULATIONS, SUCH AS L.A. COUNTY APCD RULE 1113 AND BAY AREA PCD REG. 3.
- 4. ALL STEEL COLUMNS AND MISC. METALS SHALL BE PRIMED AND PAINTED.
- 5. FIRE PREVENTION: TAKE EVERY PRECAUTION AT THE END OF THE DAY TO REMOVE OILY RAGS AND COMBUSTIBLE MATERIALS FROM THE SITE OR STORE IN METAL CONTAINER WITH TIGHT COVERS.
- 6. FINAL TEXTURE & COLOR PER OWNERS INSTRUCTIONS.
- 7. SHOP PAINTING: CONFORM TO AISC SPECIFICATION SEC M2 AND AISC CODE SEC. 6.5. DO NOT PRIME SUPFACES TO BE FIREPROOFED. IN CONTACT WITH CONCRETE, OR FIELD WELDED. STEEL WORK TO BE CONCREALE DW INTERIOR BUILDING FINISH OR TO BE IN CONTACT WITH CONCRETE DOES NOT REQUIRE PAINTING. ALL OTHER STEELWORKS SHALL BE GIVEN ONE COAT OF SHOP PAINT.

INSPECTIONS; ALL CONSTRUCTION IS SUBJECT TO INSPECTION BY THE BUILDING OFFICIAL IN ACCORDANCE WITH CBC SEC. 108. THE CONTRACTOR SHALL COORDINATE ALL REQUIRED INSPECTIONS WITH THE BUILDING OFFICIAL.

STRUCTURAL OBSERVATION: STRUCTURAL OBSERVATION SHALL BE PROVIDED IN SEISMIC ZONE 3 OR 4 WHEN REQUIRED BY THE BUILDING OFFICIAL IN ACCORDANCE WITH CBC SEC. 1720 IF REQUIRED BY THE BUILDING OFFICIAL. THE OWNER SHALL EMPLOY THE ENGINEER RESPONSIBLE FOR THE STRUCTURAL DESIGN TO PERFORM THE STRUCTURAL OBSERVATION AS DEFINED IN CBC SEC 220. THE CONTRACTOR SHALL COORDINATE WITH THM ARCHITECT/ENGINEER TO SCHEDULE FOR STRUCTURAL OBSERVATION

#### SPECIAL INSPECTION REQUIREMENTS:

- 1. THIS SECTION APPLIES TO THE STRUCTURAL PORTIONS OF THE PROJECT REQUIRING SPECIAL INSPECTION. REFER TO CBC 1701.3 AND 1701.5 FOR SPECIAL INSPECTOR'S DUTIES.
- 2. ALL TESTS AND INSPECTIONS SHALL BE PERFORMED BY AN INDEPENDENT TESTING AND INSPECTION AGENCY EMPLOYED BY THE OWNER OR ARCHITECT AND NOT THE CONTRACTOR PER CBC SECTION 106.3.5.
- 3. THE CONTRACTOR SHALL BE RESPONSIBLE FOR PROVIDING A SCHEDULE TO THE TEST AND INSPECTION FIRM TO FACILITATE THE PROPER COORDINATION OF WORK.
- 4. PORTIONS OF WORK REQUIRING SPECIAL INSPECTION:

A. CONTINUOUS INSPECTION IS REQUIRED FOR ALL STRUCTURAL CONCRETE (EXCEPT FOUNDATION CONCRETE

B. PRIOR TO REQUESTING A FOUNDATION INSPECTION, THE SOILS ENGINEER SHALL ADVISE THE BUILDING OFFICIAL IN WRITING THAT: 1) THE BUILDING PAD WAS PREPARED IN ACCORDANCE WITH THE SOILS REPORT 2) THE UTILITY TRENCHES HAVE BEEN PROPERLY BACKFILLED AND COMPACTED 3) THE FOUNDATION EXCAVATIONS COMPLY WITH THE INTENT OF THE SOILS REPORT

 $\begin{array}{l} \underline{\text{RENFORCING STEEL}} \\ \text{A. ALL RENFORCING STEEL SHALL BE SECURED IN POSITION AND INSPECTED BY THE BUILDING OFFICIAL PRIOR \\ \end{array}$ 

A. ALL STRUCTURAL WELDING EXCEPT WELDING IN APPROVED SHOPS PER CBC 1701.7.
B. REINFORCING STEEL WELDING PER CBC 1701.5.3.

- BOLTING:
  A JOHESIVE ANCHORS IN CONCRETE OR MASONRY.
  B. HIGH-STRENGTH BOLTING THE INSPECTION OF HIGH STRENGTH A325 & A490 BOLTS SHALL BE IN ACCORDANCE WITH APPROVED MATIONALLY RECOGNIZED STANDARDS AND THE REQUIREMENTS OF SECTION 1701.6



430 BUSH ST., 5TH FLOOR SAN FRANCISCO, CA 94108

PROJECT INFORMATION

### **SFA130**

USID 12923 FA #1088093 CNU 3130 401-405 & 415 GEARY ST SAN FRANCISCO, CA 94102

CURRENT ISSUE DATE:

06/22/2011

ISSUED FOR:=

### CONSTRUCTION

	Ľ	REV.:	=DATE:===	DESCRIPTION:	=BY
		2	06/22/11	CONSTRUCTION	ΕN
		1	04/04/11	PERMIT	DC
		0	03/02/11	90% CONSTRUCTION	JPO

CIVIL ENGINEER:

IDO



26455 RANCHO PKWY SOUTH LAKE FOREST CA 92630. (949) 753-8807 OFFICE - (949) 753-8833 FAX CDG#: 08-8034 DRAWN BY:= =APV.: =: CHK

] <sub>DC</sub>

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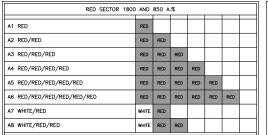
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**GENERAL NOTES &** SPECIFICATIONS

SHEET NUMBER:

T-3

SCALE **GENERAL NOTES & SPECIFICATIONS** N.T.S.



GREEN SECTOR 1		000	0.76	_	_		
C1 GREEN	GREEN						_
C2 GREEN/GREEN	GREEN	GREEN					
C3 GREEN/GREEN	GREEN	GREEN	GREEN				_
C4 GREEN/GREEN/GREEN	GREEN	GREEN	GREEN	GREEN			_
C5 GREEN/GREEN/GREEN/GREEN	GREEN	GREEN	GREEN	GREEN	GREEN		
C6 GREEN/GREEN/GREEN/GR./GR.	GREEN	GREEN	GREEN	GREEN	GREEN	GREEN	_
C7 WHITE/GREEN	WHITE	GREEN					
C8 WHITE/GREEN/GREEN	WHITE	GREEN	GREEN				Τ

BLUE SECTOR 1800 AND 850 B.%						
B1 BLUE	BLUE					
B2 BLUE/BLUE	BLUE	BLUE				
B3 BLUE/BLUE/BLUE	BLUE	BLUE	BLUE			
B4 BLUE/BLUE/BLUE/BLUE	BLUE	BLUE	BLUE	BLUE		
B5 BLUE/BLUE/BLUE/BLUE	BLUE	BLUE	BLUE	BLUE	BLUE	
B6 BLUE/BLUE/BLUE/BLUE/BLUE	BLUE	BLUE	BLUE	BLUE	BLUE	BLUE
B7 WHITE/BLUE	WHITE	BLUE				
B8 WHITE/BLUE/BLUE	WHITE	BLUE	BLUE			

ORANGE SECTO	1000 744	1	0.70			
D1 ORANGE	ORANGE					
D2 ORANGE/ORANGE	ORANGE	ORANGE				
D3 ORANGE/ORANGE	ORANGE	ORANGE	ORANGE			
D4 ORANGE/ORANGE/ORANGE	ORANGE	ORANGE	ORANGE	ORANGE		
D5 OR./OR./OR./OR.	ORANGE	ORANGE	ORANGE	ORANGE	ORANGE	
D6 OR./OR./OR./OR./OR.	ORANGE	ORANGE	ORANGE	ORANGE	ORANGE	ORANGE
D7 WHITE/ORANGE	WHITE	ORANGE				
D8 WHITE/ORANGE/ORANGE	WHITE	ORANGE	ORANGE			

## (A) MAIN FEEDER MARKING GUIDE

JUMPER MARKING GUIDE

BLUE SECTOR 18	00 AND	850 E	3.%			
MAIN JUMPER						
B2 1900 JUMPER (SAME AS MAIN)	BLUE	BLUE				
B2 850 JUMPER (ADD ONE YELLOW BAND)	BLUE	BLUE	YELLOW			
-						
B4 1900 JUMPER (CONNECTED TO TMA'S)	BLUE	BLUE	BLUE	BLUE	SLATE	
B4 850 JUMPER (ADD ONE YELLOW BAND)	BLUE	BLUE	BLUE	BLUE	YELLOW	SLATE

NOTE: CABLE TAGGING SHOWN PER BASE LINE STATION SITE DESIGN GUIDELINES LOS ANGELES MARKET VERSION 5.0 11/04/05

#### JUMPER MARKING GUIDE

JUMPER MARKING GUIDE

EACH MAIN FEEDER MAY REQUIRE UP TO TWO JUMPERS IF A
DIPLEXER IS USED. THEREFORE, IF IS NECESSARY TO CLEARLY MARK
BOTH ENDS OF EACH JUMPER. THE JUMPER WILL CARRY THE SAME
COLORED BAND AS THE MAIN FEEDER. 1 ADDITION, COLORED BANDS
WILL BE ADDED TO COMMUNICATE THE FREQUENCY BAND AND ALSO
THE PRESENCE OF AN INSTALLED TMA'S.

FREQUENCY BAND NO DIPLEXER INSTALLED, 850 AND 1900 BANDS: REPEAT MAIN FEEDER MARKING, NO ADDITIONAL COLORS.
1900 BAND: REPEAT MAIN FEEDER MARKING, NO

850 BAND: REPEAT MAIN FEEDER MARKING PLUS ADD ONE YELLOW BAND.

#### INSTALLED TMA'S

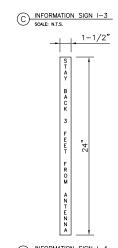
NO TMA'S INSTALLED: NO ADDITIONAL BANDS. TMA'S INSTALLED: ADD ONE SLATE BAND.

## INFORMATION AT&T OPERATES TELECOMMUNICATION ANTENNAS AT THIS LOCATION. REMAIN AT LEASE 3 FEET AWAY FROM ANY ANTENN AND OBEY ALL POSTED SIGNS. CONTACT THE OWNER'S OF THE ANTENNA(S) BEFORE WORKING CLOSER THAN 3 FEET FROM THE ANTENNA(S) CONTACT AT&T AT \_\_\_\_\_\_ PRIOR TO PERFORMING ANY MAINTENANCE OR REPAIRS NEAR AT&T ANTENNAS THE SITE # CONTACT THE MANAGER OFFICE IF THE DOOR/HATCH/GATE IS FOUND UNLOCKED. INFORMACION EN ESTA PROPIEDAD SE UBICAN ANTENAS DE TELECOMUNICACIONI OPERADAS POR AT&T. FAVOR MANTENER UNA DISTANCIA DE NO MENOS DE 3 PIES Y OBEDECER TODOS LOS AVISOS. COMUNIQUESE CON EL PROPIETARIO O LOS PROPIETARIOS DE LAS ANTENAS ANTES DE TRABAJAR O CAMINAR DE MENOS DE 3 PIES DE LA ANTENA. COMUNIQUESE CON AT&T \_\_\_\_\_ ANTES DE REAUZAR CUALQUIER MANTENIMIENTO O REPARACION DE LAS ANTENAS DE AT&T. A INFORMATION SIGN I-1 SCALE: 1/2" = 1"

INFORMATION ACTIVE ANTENNAS ARE MOUNTED DON THE OUTSIDE FACE OF THIS BUILDING ON THIS STRUCTURE STAY BACK A MINIMUM OF 3 FEET FROM THESE ANTENNAS CONTACT AT&T AT

INSTRUCTIONS PRIOR TO PERFORMING
ANY MAINTENANCE OR REPAIRS
CLOSER THAN 3 FEET FROM THE
ANTENNANC.

B INFORMATION SIGN I-2
SCALE: 3/4" = 1"



at&t

INFORMATION SIGN I-4
SCALE: 3/16" = 1"

CONTRACTOR SHALL INSTALL ALL INFORMATION SIGNAGE IN ACCORDANCE WITH AT&T MOBILITY DOCUMENT #03-0074, RF EXPOSURE POLICY AND RF SAFETY COMPLIANCE PROGRAM, LATEST EDITION.

\*SIGN I-1: ENTRANCE DOOR, SEE DETAIL 1A, THIS SHEET

SIGN 1 IS TO BE MADE ON THE 50 MIL ALUMINUM SHEETING (SIZE 8 INCHES BY 12 INCHES) WITH FOUR (4) 1/4 INCH MOUNTING HOLES, ONE EACH CORNER OF THE SIGN FOR MOUNTING WITH HARDWARE WITH THEWARPS. THE MAIN BACKGROUND COLOR IS TO BE WHITE FRONT AND BACK WITH BLACK LETTERING.

THE INFORMATION BAND SHALL BE 1.2 INCH SOLID GREEN BAND WITH 0.5 INCH HIGH BLACK LETTERING. THE BODY TEXT SHALL BE IN BLACK LETTERING WITH 0.2 INCH HIGH LETTERS. THE REF LINE SHALL BE IN 178 INCH LETTERS.

THE PLACEMENT OF TEXT SHALL BE DONE IN A MANNER THAT WILL PERMIT EASY READING FROM DISTANCE OF APPROXIMATELY 6 FEET IN FRONT OF THE \*SIGN.

ALL PAINT WILL BE BAKED WITH ENAMEL WITH UV PROTECTIVE COATING OVER THE FACE OF THE SIGN.

#### \* SIGN I-2: POLE, SEE DETAIL 1B, THIS SHEET

SIGN 2 MUST BE A NON-METALIC LABEL WITH AN ADHESIVE BACKING, THE LABEL SHALL BE MADE USING VINYL OR SIMILAR WEATHERPROOF MATERIAL. THE LABEL SHALL BE APPROXIMATELY 5 X 7 INCHES WITH A WHITE BACKGROUND AND BLACK LETTERING. THE GREEN BAND SHALL BE 1,375 INCH IN HEIGHT AND THE LETTERING SHALL BE BLACK WITH 0,75 INCH HIGH LETTERING SHALL BE BLACK WITH 1/8 INCH HIGH LETTERS. UV PROTECTION SHALL BE PLACED OVER THE FRONT OF THE LABEL.

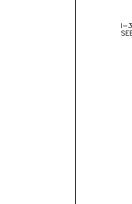
\* SIGN I-3: BACK OF ANTENNAS, SEE DETAIL 1C & 3, THIS SHEET

\* SIGN I-4: SIDE OF ANTENNAS, SEE DETAIL 1D & 3, THIS SHEET

SIGN 4 IS MADE FROM TRANSPARENT MATERIAL 1-1/2 INCHES WIDE AND 24 INCHES SIGN 4-15 MADE FROM INCOMPARENT MATERIAL IT-1/2 INCHES WIDE AND 24 INCOLES LONG. THE LETTERING IS TO BE BLACK WITH 1/2 INCH LETTERING IN A VERTICAL COLUMN. THE SPACING BETWEEN WORDS MUST BE SUCH THAT IT IS EASILY READ AND FILLS THE LENGTH OF THE SIGN.

### CABLE TAGGING GUIDE

## INFORMATION SIGNAGE



I-3 RF RADIATION SIGNAGE -SEE DETAIL 1, THIS SHEET e accedena esti Factora Computation Inches a community (FICE) a contra



Obey all posted signs and site guidelin for working in radio frequency

CAUTION

For your safety, obey all posted signs a site guidelines for working in radio frequency environments.

### NOTE:

- CONTRACTOR SHALL INSTALL ALL INFORMATION SIGNAGE IN ACCORDANCE WITH AT&T MOBILITY DOCUMENT # 03-0074, RF EXPOSURE POLICY AND RF SAFETY COMPLIANCE PROGRAM, LATEST EDITION.
- CONTRACTOR SHALL CONTACT AT&T R-RFSC FOR INFORMATION ON MPE LEVELS AND INSTRUCTIONS ON LEVEL AND LOCATION OF SIGNAGE.



Beyond this point: Radio frequency fields at this site exceed the FCC rules for human

DRAWN BY: =APV.: -CHK.: DC DC LICENSER:

CONNELL DESIGN GROUP, LLC

CONSULTING CIVIL ENGINEERS 26455 RANCHO PKWY SOUTH LAKE FOREST CA 92630.

(949) 753-8807 OFFICE - (949) 753-8833 FAX

CDG#: 08-8034

430 BUSH ST., 5TH FLOOR

SAN FRANCISCO, CA 94108

**SFA130** 

USID 12923 FA #1088093

CNU 3130

401-405 & 415 GEARY ST

SAN FRANCISCO, CA 94102

06/22/2011

CONSTRUCTION

=REV.:=DATE:===DESCRIPTION:====BY

CONSTRUCTION

90% CONSTRUCTION

PROJECT INFORMATION

CURRENT ISSUE DATE:

06/22/11

04/04/1 03/02/11

CIVIL ENGINEER:

ISSUED FOR:=

SHEET TITLE:=

SIGNAGE & CABLE TAGGING GUIDE

SHEET NUMBER:

THIS EMERGENCY CONTACT INFORMATION SHALL BE POSTED AT THE SITE: AT&T MOBILITY 24/7 EMERGENCY CONTACT NUMBER -800-832-6662

ANTENNA SIGNAGE DETAIL

SCALE: N.T.S.

24/7 EMERGENCY CONTACT INFORMATION

NOTICE SIGNAGE

SCALE: N.T.S.

T-4

#### GENERAL NOTES:

- 1. DRAWINGS ARE NOT TO BE SCALED, WRITTEN DIMENSIONS TAKE PRECEDENCE, AND THIS SET OF PLANS IS INTENDED TO BE USED FOR DIMERAMATIC PURPOSES ONLY, JUNESS NOTED OTHERWISE. THE CENTERAL CONTRACTOR'S SCOPE OF WORK SHALL INCLUDE FURNISHING ALL MATERIALS, EQUIPMENT, LABOR, AND ANTHING ELSE DEEMED NECESSARY TO COMPLETE INSTALLATIONS AS DESCRIBED HEREIN.
- 2. PRORE TO THE SUBMISSION OF BIDS, THE CONTRACTORS INVOLVED SHALL VISIT THE JOB SITE AND FAMILIARIZE THEMSELVES WITH ALL CONDITIONS AFFECTING THE (N) PROJECT, WITH THE CONSTRUCTION AND CONTRACT DOCUMENTS, FIELD CONDITIONS AND CONFIRM THAT THE PROJECT MAY BE ACCOMPLISHED AS SHOWN PRIOR TO PROCEEDING WITH CONSTRUCTION, ANY ERRORS, OMISSIONS, OR DISCREPANCIES ARE TO BE BROUGHT TO THE STEETING MEETING FOR THE ADMISTISC FADINATES.
- 3. THE GENERAL CONTRACTOR SHALL RECEIVE WRITTEN AUTHORIZATION TO PROCEED WITH CONSTRUCTION PRIOR TO STARTING WORK ON ANY ITEM NOT CLEARLY DEFINED BY THE CONSTRUCTION DRAWINGS DOCUMENTS.
- 4. THE CONTRACTOR SHALL SUPERVISE AND DIRECT THE PROJECT DESCRIBED HEREIN. THE CONTRACTOR SHALL BE SOLELY RESPONSIBLE FOR ALL CONSTRUCTION MEANS, METHODS, TECHNIQUES, SEQUENCES AND PROCEDURES AND FOR COORDINATING ALL PORTIONS OF THE WORK UNDER THE CONTRACT.
- 5. THE CONTRACTOR SHALL INSTALL ALL EQUIPMENT AND MATERIALS ACCORDING TO MANUFACTURER'S SPECIFICATIONS UNLESS NOTED OTHERWISE OR WHERE LOCAL CODES OR ORDINANCES TAKE PRECEDENCE
- 6. ALL WORK PERFORMED ON PROJECT AND MATERIALS INSTALLED SHALL BE IN STRICT ACCORDANCE WITH ALL APPLICABLE CODES, REGULATIONS, AND ORDINANCES, CONTRACTOR SHALL GIVE ALL NOTICES AND COMPLY WITH ALL LAWS, ORDINANCES, RULES, REGULATIONS AND LAWFUL ORDERS OF ANY PUBLIC AUTHORITY, MUNICIPAL AND UTILITY COMPANY SPECIFICATIONS, AND LOCAL AND STATE JURISDICTIONAL CODES BEARING ON THE PERFORMANCE OF THE
- GENERAL CONTRACTOR SHALL PROVIDE AT THE PROJECT SITE A FULL SET OF CONSTRUCTION DOCUMENTS UPDATED WITH THE LATEST REVISIONS AND ADDENDA OR CLARIFICATIONS FOR USE BY ALL PERSONNEL INVOLVED WITH THE PROJECT
- 8. THE STRUCTURAL COMPONENTS OF THIS PROJECT SITE/FACILITY ARE NOT TO BE ALTERED BY THIS CONSTRUCTION PROJECT UNLESS NOTED OTHERWISE.
- DETAILS INCLUDED HEREIN ARE INTENDED TO SHOW END RESULT OF DESIGN. MINOR MODIFICATIONS MAY BE REQUIRED TO SUIT JOB CONDITIONS OR SITUATIONS, AND SUCH MODIFICATIONS SHALL BE INCLUDED AS PART OF THE SCOPE OF WORK.
- 10.SEAL PENETRATIONS THROUGH FIRE—RATED AREAS WITH U.L. LISTED FIRE STOPPING AND FIRE MARSHAL APPROVED MATERIALS IF APPLICABLE TO THIS FACILITY AND OR PROJECT SITE.
- 11.PROVIDE A PORTABLE FIRE EXTINGUISHER WITH A RATING OF NOT LESS THAN 2-A OR 2-A10BC WITHIN 75 FEET TRAVEL DISTANCE TO ALL PORTIONS OF THE PROJECT AREA DURING CONSTRUCTION.
- 12.THE CONTRACTOR SHALL MAKE NECESSARY PROVISIONS TO PROTECT EXISTING IMPROVEMENTS, EASEMENTS, PAINING, CURBING, ETC. DURING CONSTRUCTION, UPON COMPLETION OF WORK, CONTRACTOR SHALL REPAIR ANY DAMAGE THAT MAY HAVE OCCURRED DUE TO CONSTRUCTION ON OR ABOUT THE PROPERTY.
- 13.CONTRACTOR SHALL SEE TO IT THAT GENERAL WORK AREA IS KEPT CLEAN AND HAZARO FREE DURING CONSTRUCTION, DISPOSE OF ALL DIRT, DEBRIS, AND RUBBISH, AND REMOVE EQUIPMENT NOT SPECIFIED AS REWAINING ON THE PROPERTY. PREMISES SHALL BE LEFT IN CLEAN CONDITION AND FREE FROM PAINT SPOTS, DUST, OR SAUDOSE OF ANY NATURE.
- 14.THE ARCHITECTS/ENGINEERS HAVE MADE EVERY FEFORT TO SET FORTH IN THE CONSTRUCTION AND CONTRACT DOCUMENTS THE COMPLETE SCOPE OF WORK. CONTRACTORS BIDDING THE JOB ARE NEVERTHELESS CAUTIONED THAT MINOR OMISSIONS OR ERRORS IN THE DRAWINGS AND OR SPECIFICATIONS SHALL NOT EXCUSE SAID CONTRACTOR FROM COMPLETING THE PROJECT AND IMPROVEMENTS IN ACCORDANCE WITH THE INTENT OF THESE DOCUMENTS. THE BIDDER SHALL BEAR THE RESPONSIBILITY OF NOTIFICING IN WRITING) THE ARCHITECT/ENGINEER OF ANY CONFLICTS, ERRORS, OR OMISSIONS PRIOR TO THE SUBMISSION OF CONTRACTOR'S PROPOZAL IN THE EVENT OF DISCREPANCIES THE CONTRACTOR SHALL PRICE THE MORE COSTLY OR EXTENSIVE WORK.
- 15.CONTRACTOR MUST PERFORM WORK DURING OWNER'S PREFERRED HOURS TO AVOID DISTURBING NORMAL BUSINESS.
- 16.IT SHALL BE THE RESPONSIBILITY OF THE CONTRACTOR TO LOCATE ALL EXISTING UTILITIES WHETHER SHOWN HEREON OR NOT AND TO PROTECT THEM FROM DAMAGE. THE CONTRACTOR SHALL BEAR ALL EXPENSE OF REPAIR OR REPLACEMENT IN CONJUNCTION WITH THE EXECUTION OF THIS WORK.
- 17.THE CONTRACTOR SHALL VERIFY THE NUMBER AND LOCATION OF ALL EQUIPMENT ANCHORS WITH THE EQUIPMENT MANUFACTURERS.
- 18.PROVIDE YELLOW PAINTED WARNING STRIPING PER AT&T WIRELESS ON ROOF AS SHOWN ON PLAN. PROVIDE WARNING SIGNS PER AT&T WIRELESS'S PERMISPLEMENTS
- 19.PROVIDE TRACESS BOX WITH LOCATION PER AT&T WIRELESS CONSTRUCTION
- 20.PROVIDE SPRING LOADED SAFETY CLIMBING BAR AT TOP OF LADDER UNDER ROOF HATCH.

#### TENANT IMPROVEMENT NOTES:

- PROVIDE DOORS AND FRAMES COMPLYING WITH STEEL DOOR INSTITUTE "RECOMMENDED SPECIFICATIONS FOR STANDARDS STEEL DOOR AND FRAMES" (SDI 100), AND AS HEREIN SPECIFIED.
- 2. WHERE FIRE—RATED DOOR ASSEMBLIES ARE INDICATED OR REQUIRED, PROVIDE FIRE—RATED DOOR AND FRAME ASSEMBLIES THAT COMPLY WITH NFPA 80 "STANDARD FOR FIRE DOORS AND WINDOWS", AND HAVE BEEN TESTED, LISTED AND LABELED IN ACCORDANCE WITH ASTM E 152 "STANDARD METHODS OF FIRE TESTS OF DOOR ASSEMBLIES" BY A NATIONALLY RECOGNIZED INDEPENDENT TESTING AND INSPECTION AGENCY ACCEPTABLE TO AUTHORITIES HAVING JURISDICTION.
- HOT-ROLLED STEEL SHEETS AND STRIP: COMMERCIAL QUALITY CARBON STEEL, PICKLED AND OILED, COMPLYING WITH ASTM A 569 AND ASTM A 568.
- 4. COLD-ROLLED STEEL SHEETS: COMMERCIAL QUALITY CARBON STEEL, COMPLYING WITH ASTM A 366 AND ASTM A 568.
- 5. SUPPORTS AND ANCHORS: FABRICATE OF NOT LESS THAN 16 GAGE SHEET STEEL.
- 6. INSERTS, BOLTS AND FASTENERS: MANUFACTURE'S STANDARD UNITS COMPLYING WITH ASTM A 153, CLASS C OR D AS APPLICABLE.
- 7. SHOP—APPPLIED PAINT: FOR STEEL SURFACES USE RUST—INHIBITIVE ENAMEL OR PAINT, EITHER AIR—DRYING OR BAKING, SUITABLE AS A BASE FOR SPECIFIED FINISH PAINTS.
- 8. FABRICATE HOLLOW METAL UNITS TO BE RIGID, NEAT IN APPEARANCE AND FREE FROM DEFECTS, WARP OR BUCKLE. WHEREVER PRACTICAL. FIT AND ASSEMBLE UNITS IN THE MANUFACTURER'S PLANT. WELD EXPOSED JOINTS CONTINUOUSLY, GRIND AND MAKE SMOOTH, FLUSH AND INVISIBLE. METALLIC FILLER TO CONCEAL MANUFACTURING DEFECTS IS NOT ACCEPTABLE.
- 9.COMPLY WITH SDI-100 REQUIREMENTS AS FOLLOWS: INTERIOR DOORS SHALL BE SDI-100, GRADE II , HEAVY DUTY, MODEL 1, MINIMUM 18 GAGE FACES.
- 10. EXPOSED FASTENERS: UNLESS OTHERWISE INDICATED, PROVIDE COUNTERSUNK FLAT PHILLIPS OR JACKSON HEADS FOR EXPOSED SCREWS AND BOLTS.
- 11.FINISH HARDWARE PREPARATION: PREPARE HOLLOW METAL UNITS TO RECEIVE MORTISE AND CONCEALED FINISH HARDWARE, INCLUDING CUTOUTS, REINFORCING, DRILLING AND TAPPING IN ACCORDANCE WITH FINAL FINISH HARDWARE SCHEDULE AND TEMPLATES PROVIDED BY HARDWARE SUPPLIER. COMPLY WITH APPLICABLE REQUIREMENTS OF ANSI A 115 "SPECIFICATIONS FOR DOOR AND FRAME
- 12. PROVIDE STEEL REINFORCING AT HINGES IN HOLLOW METAL UNITS TO BE 7 GAGE × 10 1/2" × WIDTH REQUIRED.
- 13. PROVIDE HOLLOW METAL DOORS OF THE TYPES INDICATED ON THE DRAWINGS AND COMPLYING WITH SDI-100 MINIMUM MATERIALS AND CONSTRUCTION REQUIREMENTS.
- 14. PROVIDE HOLLOW METAL FRAMES OF THE TYPES AND STYLES INDICATED ON THE DRAWINGS AND COMPLYING WITH SDI 100. PROVIDE 16 GAGE FRAMES AT INTERIOR LOCATIONS.
- NOTE: DOOR SHALL BE OPERABLE FOR EXITING FROM THE INSIDE WITHOUT THE USE OF A KEY OR ANY OTHER SPECIAL

#### TELEPHONE SERVICE PROVIDER NOTES:

#### CONDILIT

- 1) PROVIDE ONE 2" MINIMUM DIAMETER DUCT OF APPROVED
- WITHIN OR ON BUILDINGS USE RIGID GALVANIZED STEEL (WHEN REQUIRED), OR ELECTRO-METALLICA TUBING (EMT)
- IN UNDERGROUND PVC SCHEDULE 40 OR EQUIVALENT FOR STRAIGHT SECTIONS, USE PVC SCHEDULE 80 FOR ALL BENDS PROVIDE PULL ROPES IN ALL DUCTS (MIN 3/8" POLY PULL ROPE) AND A MEASURING TAPE MUST BE IN PLACE TO DETERMINE "AS-BUILT" CONDUIT LENGTH; BOTH MUST BE ONE
- CONDUIT BENDS MUST HAVE A RADIUS 10 TIMES CONDUIT SIZE
- 2) WITHIN OR ON BUILDINGS:
- \*ELECTRICAL LB's AND CONDULETS ARE NOT ACCEPTABLE AS PULL BOXES
- \*NO 90 DEGREE TRANSITIONS AT OR IN PULL BOXES (UNLESS A 10" BENDING RADIUS CAN BE MAINTAINED)
- \*IN-LINE PULL BOX MINIMUM DIMENSIONS = 24"L x 6"W x 6"D 30"L x 6"W x 6"D PREFERRED
- \*PULL BOXES MUST BE EASILY ACCESSIBLE (TELEPHONE COMPANY WILL NOT REMOVE CEILING TILES)
- VERTICAL SECTIONS OF CONDUIT WILL REQUIRE A PULL BOX EVERY 100 FEET AND APPROVED RESTRAINTS
- · MAXIMUM OF 300 FEET HORIZONTAL BETWEEN PULL BOXES
- MAXIMUM OF 2-90 DEGREE BENDS BETWEEN PULL BOXES
   MINIMUM CONDUIT BEND RADIUS OF 10 CABLE DIAMETERS (12")
- FIRE STOPPING REQUIRED WHEN OPENINGS ARE MADE IN ANY FIRE RATED BARRIER
- + ALL EXTERNAL CONDUIT TERMINATIONS SHALL BE WEATHER TIGHT
- 3) IN UNDERGROUND CONSTRUCTION
- · CONDUIT LENGTH MAXIMUM OF 300 FEET BETWEEN PULL BOXES
- CONDUIT BENDS MUST HAVE A RADIUS 10 TIMES CONDUIT SIZE
- \*MAXIMUM OF 2-90 DEGREE BENDS BETWEEN PULL BOXES

#### TRENCHING

- MINIMUM COVERAGE OF DUCT ON PRIVATE PROPERTY = 18" UNDER PAVED SURFACE OR AS SPECIFIED BY PERMITTING OWNER/AGENT
- MINIMUM COVERAGE OF DUCT OF PRIVATE PROPERTY = 24"
   UNDER DIRT SURFACE OR AS SPECIFIED BY PERMITTING
   OWNER/AGENT
- 3. MINIMUM COVERAGE OF DUCT IN PUBLIC R/W = 30" BELOW GUTTER GRADE OR AS SPECIFIED BY PERMITTING AGENT
- 4. MINIMUM 12" CONDUIT SEPARATION IN JOINT TRENCH BETWEEN
- 5. PULL BOXES MINIMUM 17"W x 30"L
- 6. SPLICE BOXES WILL BE SIZED BY SERVING TELEPHONE COMPANY; DETAILS WILL BE PROVIDED BY TELEPHONE COMPANY OR INTERCONNECT ENGINEER

#### BONDING AND GROUNDING:

#6 AWG SOLID COPPER INSULATED GROUND WIRE (24" COILED IN TELCO SERVICE BOX) WITH BONDING CLAMPS IN PLACE. THE TELEPHONE GROUND MUST BE BONDED TO THE POWER GROUND. THE TELEPHONE SERVICE CABINET MUST BE BONDED TO THE TELEPHONE GROUND WIRE. ANY QUESTIONS RECARDING TELEPHONE GROUNDS SHOULD BE REFERRED TO THE INTERCONNECT ENGINEER.

#### SEALANTS & CAULKING:

- PROVIDE JOINT SEALERS, JOINT FILLERS AND OTHER RELATED MATERIALS THAT ARE COMPATIBLE WITH ONE ANOTHER AND WITH JOINT SUBSTRATES UNDER CONDITIONS OF SERVICE AND APPLICATIONS. PROVIDE COLORS TO MATCH ADJACENT SURFACES. PROVIDE BLACK OR OTHER NEUTRAL COLOR WHEN NO OTHER COLOR IS AVAILABLE.
- 2. ONE—COMPONENT POLYSULFIDE BASED, ONE PART ELASTOMERIC SEALANT, COMPLYING WITH FS TT—S—00230,CLASS A TYPE II (NON—SAG), FOR JOINTS AT PENETRATIONS THROUGH EXTERIOR WALLS. PROVIDE COMPOUND BEARING THE THIOCOL CHEMICAL CORPORATION SEAL OF APPROVAL. PROVIDE ONE OF THE FOLLOWING OR AN APPROVED EQUAL: FLEXISEAL 900 SERIES BY DAP, INC. HORNFLEX ONE COMPONENT BY W.R. GRACE & CO.
- 3. ONE—COMPONENT ACRYLIC SEALANT: ACRYLIC TERPOLYMER, SOLVENT BASED ONE—PART THERMOPLASTIC SEALANT COMPOUND, SOLIDS NOT LESS THAN 95% ACRYLIC, COMPLYING WITH FS TT—S—00230, CLASS B TYPE II, FOR PERIMIETER OF METAL AND DOOR FRAMES, THRESHOLDS AT EXTERIOR DOORS, AND PIPE SLEEVES THROUGH EXTERIOR WALLS AND FLOOR SLABS. PROVIDE ONE OF THE FOLLOWING OF AN APPROVED EQUAL: DAP ACRYLIC BY DAP, INC. GACO AS—3 BY GATES ENGINEERING/SMC
- 4. OLEO—RESINS CAULKING COMPOUND: OIL BASED RESINOUS CAULKING, COMPLYING WITH FS TT—C—598, NON—BLEEDING, PAINTABLE, FOR ONE OF THE FOLLOWING OR AN APPROVED EQUAL: VULCATEX BY W.R. GRACE & CO.

#### FINISHES:

#### GYPSUM DRYWALL-09260

- MANUFACTURER: FOR ALL GYPSUM DRYWALL SYSTEMS
  THROUGHOUT THE PROJECT. PROVIDE DRYWALL MATERIALS,
  INCLUDING ACCESSORIES AND FASTENERS PRODUCED BY ONE
  MANUFACTURER. PROVIDE GYPSUM DRYWALL SYSTEMS
  MANUFACTURED BY ONE OF THE FOLLOWING OR AN APPROVED
  EQUAL:
  A. GEORGIA-PACIFIC CORPORATION B. NATIONAL
  GYPSUM COMPANY
  C. U.S. GYPSUM COMPANY
- 2. TOLERANCES FOR DRYWALL WORK: DO NOT EXCEED A VARIATION OF 3/16" IN 8'-0" AND 1/8" IN 4'-0" FROM PLUMB, LEVEL AND FLAT (ALL DIRECTIONS), AND DO NOT EXCEED 1/16" OFFSET OF PLANES AT JOINTS BETWEEN PANELS. SHIM PANELS AS NECESSARY TO COMPLY WITH TOLERANCES.
- 3. STUDS AND RUNNERS : SCREW-TYPE COMPLYING WITH ASTM C 645. PROVIDE STUDS OF THE SIZE INDICATED WITH RUNNERS OF COMPATIBLE SIZE FOR FRICTION TO STUDS.
- 4. FOR PROTECTION OF EXPOSED WALLBOARD EDGES AROUND OPENINGS, PROVIDE SQUARE NOSE METAL CASING BEAD WITH EITHER KNURLED AND PERFORATED OR EXPANDED FLANGES FOR NAILING OR STAPLING, AND BEADED FOR CONCEALMENT OF FLANGES IN JOINT COMPOUND.
- 5. JOINT TAPES: ADHESIVE WITH OR WITHOUT FILLERS COMPLYING
  WITH ASTM C 475. PROVIDE JOINT FILLERS IN DRY POWDER FORM
  OR PREMIXED READY FOR APPLICATION.
- APPLY JOINT COMPOUND IN 3 COATS (NOT INCLUDING PREFILL OF OPENING IN BASE), AND SAND BETWEEN LAST 2 COATS AND AFTER LAST COAT.
- 7. FASTENERS: PROVIDE THE TYPE AND SIZE RECOMMENDED BY THE DRYWALL MANUFACTURER FOR THE APPLICATION SHOWN.

#### PAINTING

- PAINT COLORS SHALL BE SELECTED BY CONSTRUCTION MANAGER.
- 2. PROVIDE THE BEST QUALITY GRADE OF COATINGS AS REGULARLY MANUFACTURED BY APPROVED PAINT MATERIAL MANUFACTURERS.

  MATERIALS NOT DISPLAYING THE MANUFACTURER'S. IDENTIFICATION AS A STANDARD BEST-GRADE PRODUCT WILL NOT BE ACCEPTABLE
- 3. PROVIDE UNDERCOAT PAINT PRODUCED BY THE SAME MANUFACTURER AS THE FINISH COATS. USE ONLY THINNERS APPROVED BY THE PAINT MANUFACTURER AND USE ONLY WITHIN RECOMMENDED LIMITS.
- 4. COMPLETELY COVER TO PROVIDE AN OPAQUE, SMOOTH SURFACE OF UNIFORM FINISH COLOR, APPEARANCE AND COVERAGE. CLOUDINESS, SPOTTING, HOLIDAYS LAPS, BRUSH MARKS, RUNS, SAGS, ROPINESS OR OTHER SURFACE IMPERFECTIONS WILL NOT BE ACCEPTABLE.
- 5. ZINC COATED METAL: PRIMER COAT: LATEX PRIMER. FINISH COATS: SEMI-GLOSS, ALKYD ENAMEL.
- 6. FERROUS METALS (WHERE APPLICABLE): SHOP PRIMED: TOUCH UP COAT: RED OXIDE METAL PRIMER. FINISH COATS: SEMI-GLOSS, ALKYD ENAMEL.
- 7. MASONRY OR CONCRETE: PRIMER COAT: CEMENTITIOUS BLOCK FILLER. FINISH COATS: SEMI-GLOSS, ALKYD ENAMEL.
- 8. GYPSUM DRYWALL: PRIMER COAT: LATEX PRIMER. FINISH COATS: SEMI-GLOSS, ALKYD ENAMEL.
- PAINTS USED TO COVER THE ANTENNAS SHALL HAVE NO METALLIC INGREDIENTS.

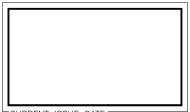


430 BUSH ST., 5TH FLOOR SAN FRANCISCO, CA 94108

PROJECT INFORMATION:

## SFA130 USID 12923

FA #1088093 CNU 3130 401-405 & 415 GEARY ST. SAN FRANCISCO, CA 94102



CURRENT ISSUE DATE:=

06/22/2011

ISSUED FOR:

### CONSTRUCTION

	F	REV.:	:=DATE:===	DESCRIPTION:	=BY:
		2	06/22/11	CONSTRUCTION	EN
		1	04/04/11	PERMIT	DC
		0	03/02/11	90% CONSTRUCTION	JPC
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CIVIL ENGINEER:



CONSULTING CIVIL ENGINEERS 26455 RANCHO PKWY SOUTH, LAKE FOREST CA 92630 (949) 753-8807 OFFICE - (949) 753-8833 FAX CDG#: 08-8034

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SHEET TITLE:

TENANT IMPROVEMENT NOTES

=SHEET NUMBER:=

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#### RESILIENT FLOORING-09650

- PROVIDE RESILIENT FLOORING SIMILAR TO "CUSTOM CORTINA" AS MANUFACTURED BY AZROCK. NO ASBESTOS CONTAINING MATERIALS TO BE USED.
- VINYL COMPOSITION TILE: SHALL COMPLY WITH FS SS-TT-312 TYPE IV, 12"x1/8" GAGE. COLOR SHALL BE SELECTED BY CONSTRUCTION MANAGER. PROVIDE BURKE 4" HIGH TOP SET RUBBER COVE BASE. COLOR: BLACK.
- 3. ADHESIVES (CEMENTS): WATERPROOF, STABILIZED TYPE AS RECOMMENDED BY FLOORING MANUFACTURER. ASPHALT EMULSIONS AND NON-WATERPROOF TYPES ARE NOT ACCEPTABLE.
- 4. RESILIENT BASE: PROVIDE TOP-SET COVE TYPE VINYL BASE COMPLYING WITH FF SS-W-40, TYPE II, WITH MATCHING END STOPS AND PRE FORMED CORNER UNITS, 4" HIGH BY 1/8" GAGE. COLOR SHALL BE AS SELECTED BY CONSTRUCTION MANAGER.
- 5. INSTALL VINYL REDUCER STRIP AT DOOR OPENINGS WHERE VCT MEETS OTHER MATERIAL.
- 6. APPLY RESILIENT BASE TO WALLS AND PERMANENT FIXTURES IN ROOMS OR AREAS WHERE BASE IS REQUIRED. INSTALL BASE IN AS LONG LENGTHS AS PRACTICAL, WITH PRE FORMED END STOPS AND MITERED OR COPED INSIDE CORNERS. TIGHTLY BOND BASE TO BACKING THROUGHOUT THE LENOTH OF EACH PIECE, WITH CONTINUOUS CONTACT AT HORIZONTAL AND VERTICAL SURFACES.

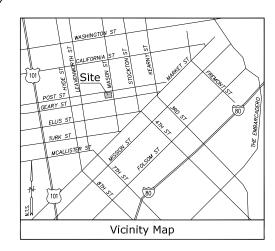
7. FINISHING: AFTER COMPLETION OF PROJECT AND JUST PRIOR TO THE FINAL INSPECTION OF WORK, THOROUGHLY CLEAN TILE FLOORS AND ACCESSORIES. APPLY WAX AND BUFF, WITH THE TYPE OF WAX, NUMBER OF COATS AND BUFFING PROCEDURES IN COMPLIANCE WITH MANUFACTURER'S INSTRUCTIONS. INSTALL PROTECTIVE COVERING BEFORE ANY OTHER WORK BEGINS.

(N) OR (E) WALL PER PLAN

TOP-SET COVE VINYL BASE

RESILIENT FLOORING
"CUSTOM CORTINA" OR SIMILAR

(N) OR (E) FLOOR PER PLAN



#### Title Report

THIS SURVEY WAS COMPLETED WITHOUT THE BENEFIT OF A TITLE REPORT. PREPARED BY: ORDER NO.: DATED:

#### Legal Description

LOT 1 AND LOT 1A OF BLOCK 316, IN THE CITY OF SAN FRANCISCO, COUNTY OF SAN FRANCISCO, STATE OF CALIFORNIA, IN THE OFFICE OF THE COUNTY RECORDER OF SAID COUNTY.

#### Assessor's Parcel Nos.

0316-001 AND 0316-001

#### Easements

NOT AVAILABLE

### Access Easement/Lease Area

#### Geographic Coordinates at Proposed Center of Sectors

1983 DATUM: LATITUDE 37' 47' 12.67"N LONGITUDE 122' 24' 36.80"W ELEVATION = 76.6 FEET ABOVE MEAN SEA LEVEL

CERTIFICATION:
THE LATITUDE AND LONGITUDE SHOWN ABOVE ARE ACCURATE TO WITHIN +/- 15 FEET
HORIZONTALLY AND THAT THE ELEVATIONS SHOWN ABOVE ARE ACCURATE TO WITHIN +/3 FEET VERTICALLY. THE HORIZONTAL DATUM (GEOGRAPHIC COORDINATES) IS IN TERMS
OF THE NORTH AMERICAN DATUM OF 1983 (NAD 83) AND IS EXPRESSED IN DEGREES (),
MINUTES (') AND SECONDS ("), TO THE NEAREST HUNDREDITH OF A SECOND. THE
VERTICAL DATUM (ELEVATIONS) IS IN TERMS OF THE NORTH AMERICAN VERTICAL DATUM
OF 1988 (NAVD 88) AND IS DETERMINED TO THE NEAREST TENTH OF A FOOT.

#### Basis of Bearings

THE STATE PLANE COORDINATE SYSTEM OF 1983 (NAD 83), CALIFORNIA ZONE 3.

#### Bench Mark

THE CALIFORNIA SPATIAL REFERENCE C.O.R.S "TIBB", ELEVATION = 38.73 FEET (NAVD 88).

#### Date of Survey

OCTOBER 6, 2010

	Legend							
FS	FINISH SURFACE	⊲FDC	FIRE DEPARTMENT					
NG	NATURAL GROUND		CONNECTION					
	POWER POLE	*	LIGHT					
-	RETAINING/BLOCK WALL	TYP	TYPICAL					
TW	TOP OF WALL	DI •	DRAIN INLET					
7.5	CONCRETE PAVEMENT	•	GEODETIC COORDINATES					
0	VENT	TP	TOP OF PARAPET					
EBR	ELECTRIC BREAKER		CHAIN LINK FENCE					
TC	TOP OF CURB	$\boxtimes$	AC UNIT					
	PROPERTY LINE	R	ROOF					



# Streamline Engineering

## 3268 Penryn Road, Suite 200, Loomis, CA 95

3268 Penryn Road, Suite 200, Loomis, CA 9565 Contact: Larry Houghtby Phone: 916-275-4180

#### PROPRIETARY INFORMATION

THE INFORMATION CONTAINED IN THIS SET OF CONSTRUCTION DOCUMENTS IS PROPRIETARY BY NATURE. ANY USE OR DISCLOSURE OTHER THAN THAT WHICH RELATES TO AT&MOBILITY IS STRICTLY PROHIBITED.

#### CONSULTANT

#### **CAL VADA**

### SURVEYING, INC.

JOB NO. 10738

411 Jenks Ctr., Sulte 205, Corona, CA 92880

Phone: 951-280-9960 Fax: 951-280-9746

Toll Free: 800-CALVADA www.cahada.com

PREPARED FOR



430 Bush St., 5th Flo San Francisco, CA 94

APPROVALS

F. DATE

DATE

DATE

ERICSSON CM

SAC AND ZONING

AT&T CM DATE

OWNER APPROVAL DATE

PROJECT NAME

AMERICAN CONSERVATORY

THEATRE

PROJECT NUMBER
SFA130

401-405 & 415 GEARY ST. SAN FRANCISCO, CA 94102 SAN FRANCISCO COUNTY

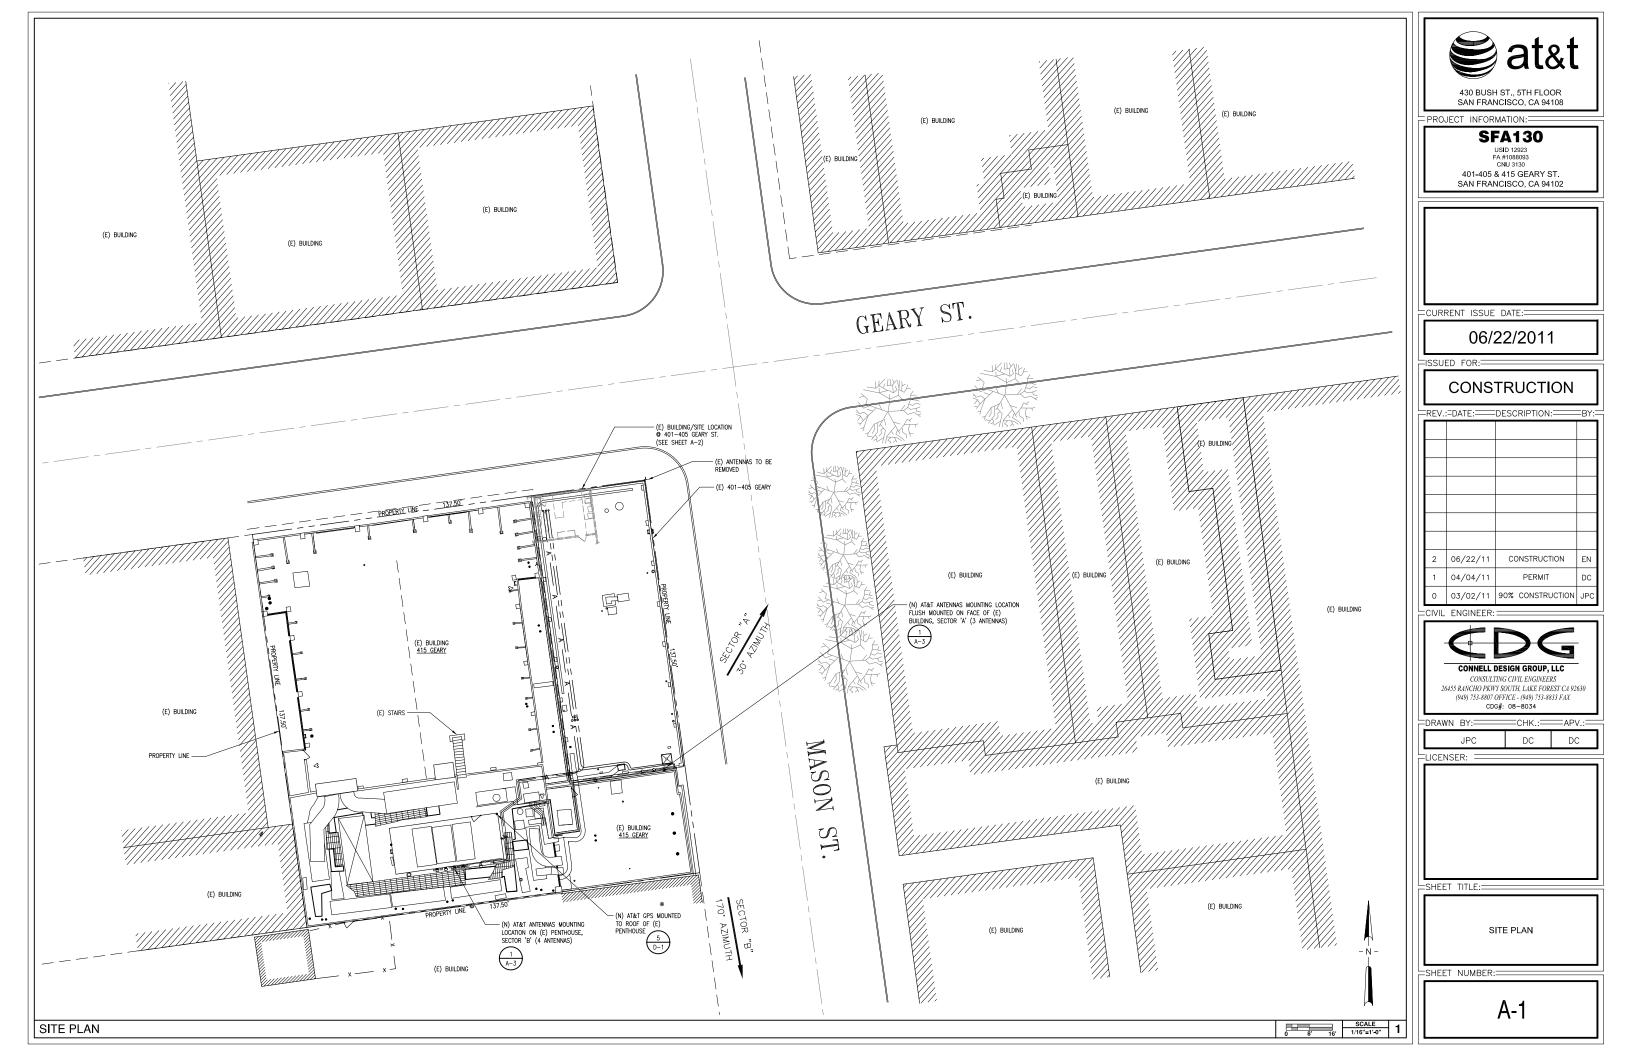
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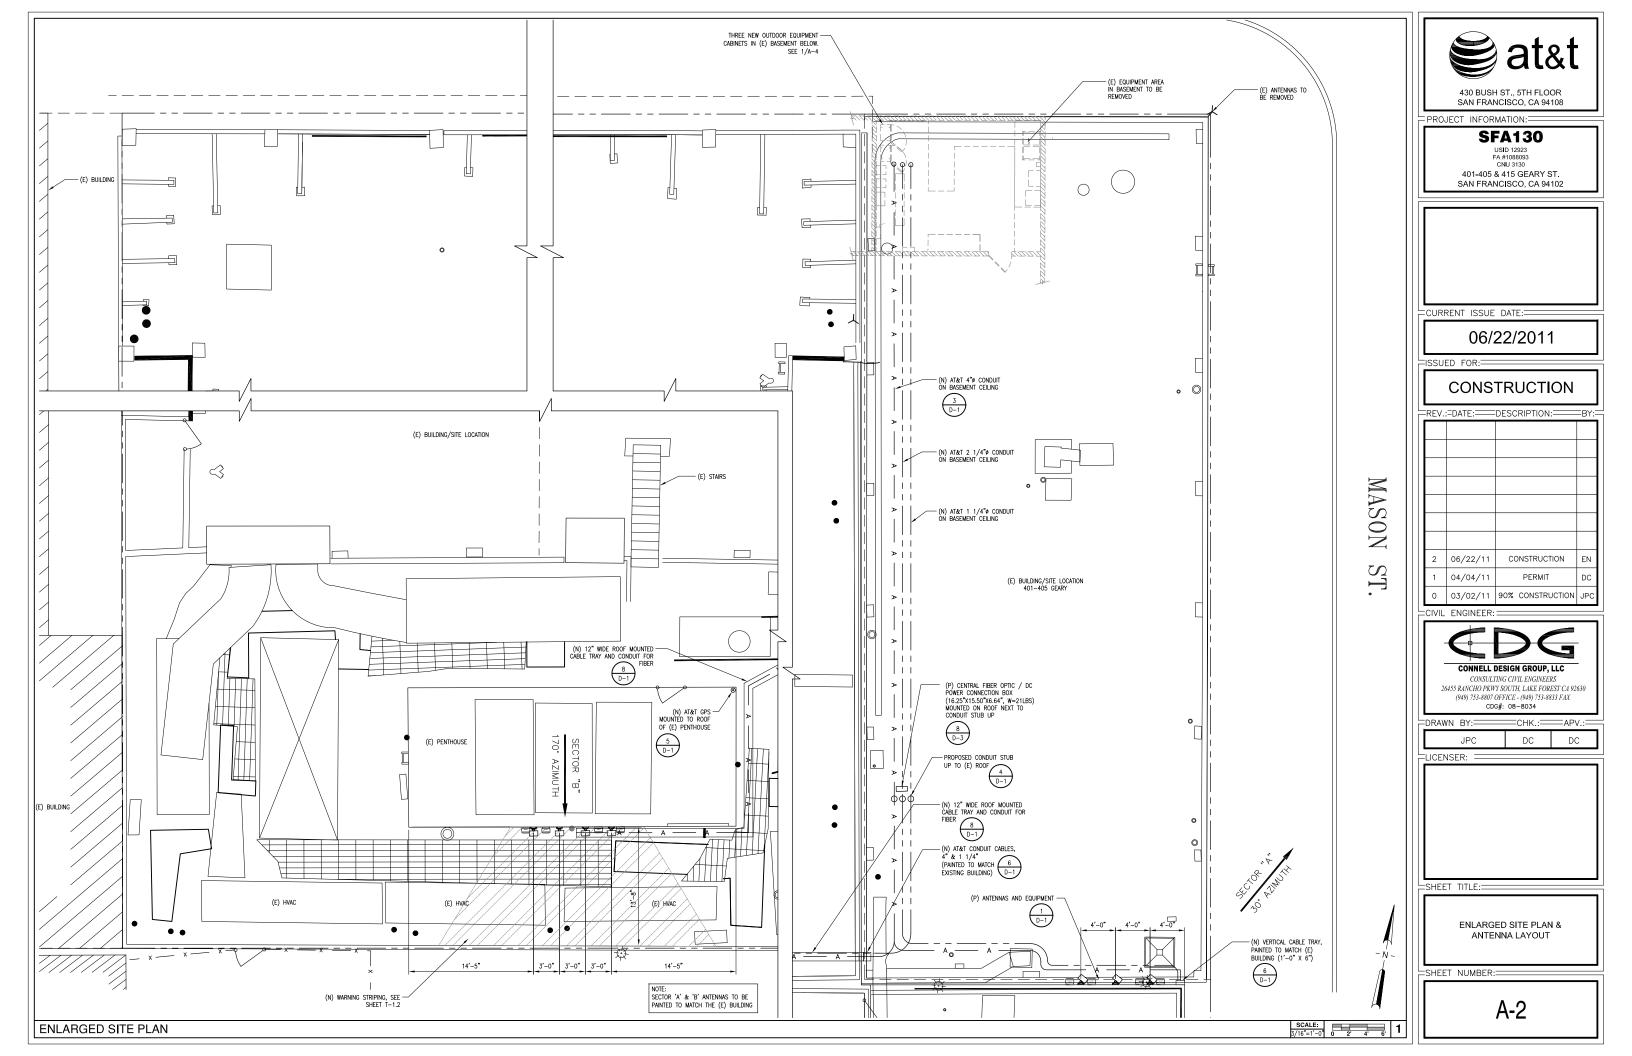
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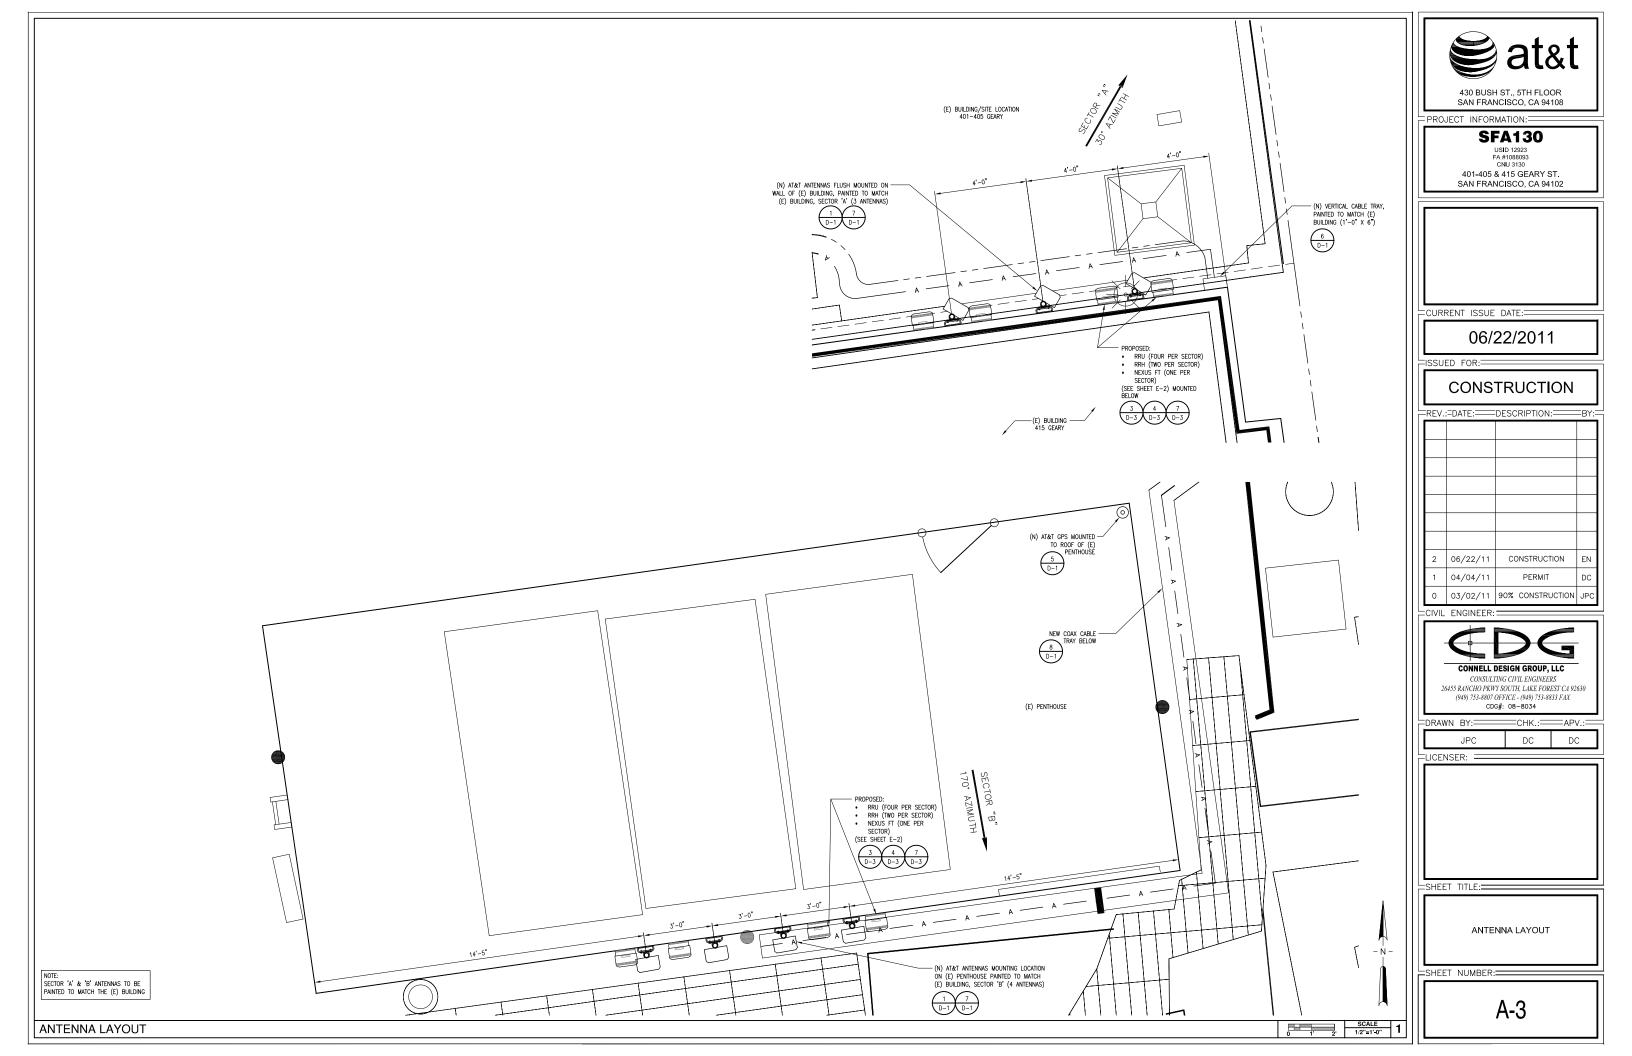
TOPOGRAPHIC SURVEY

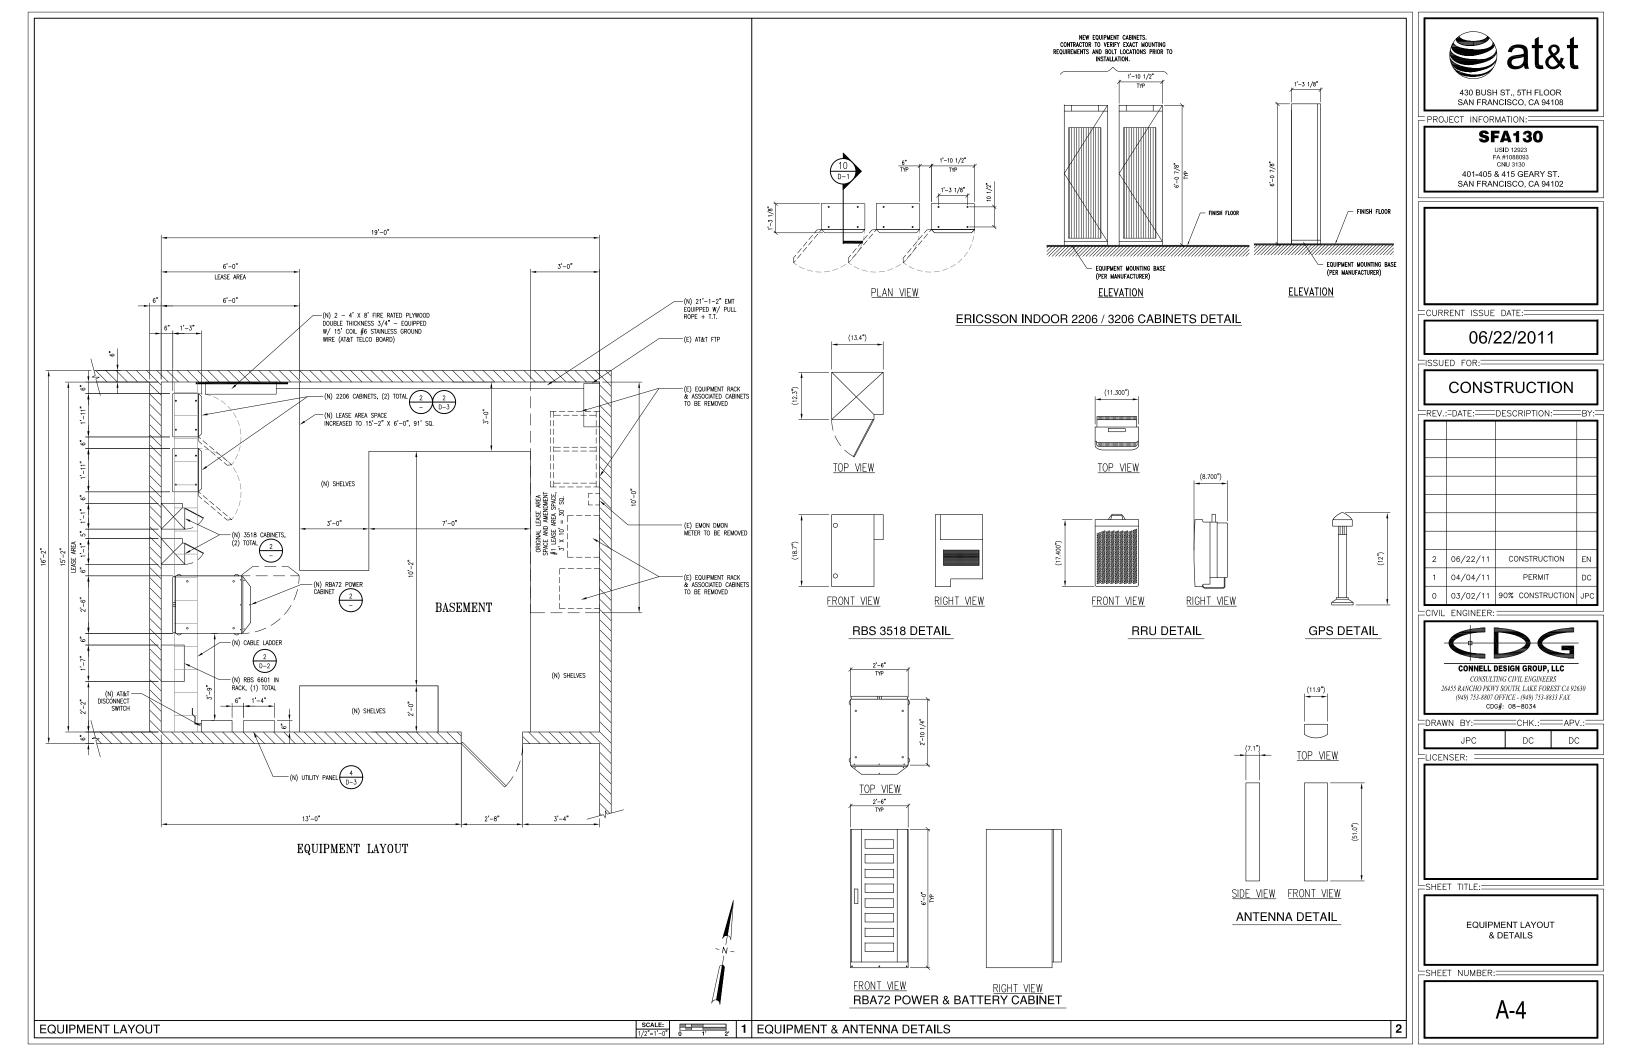
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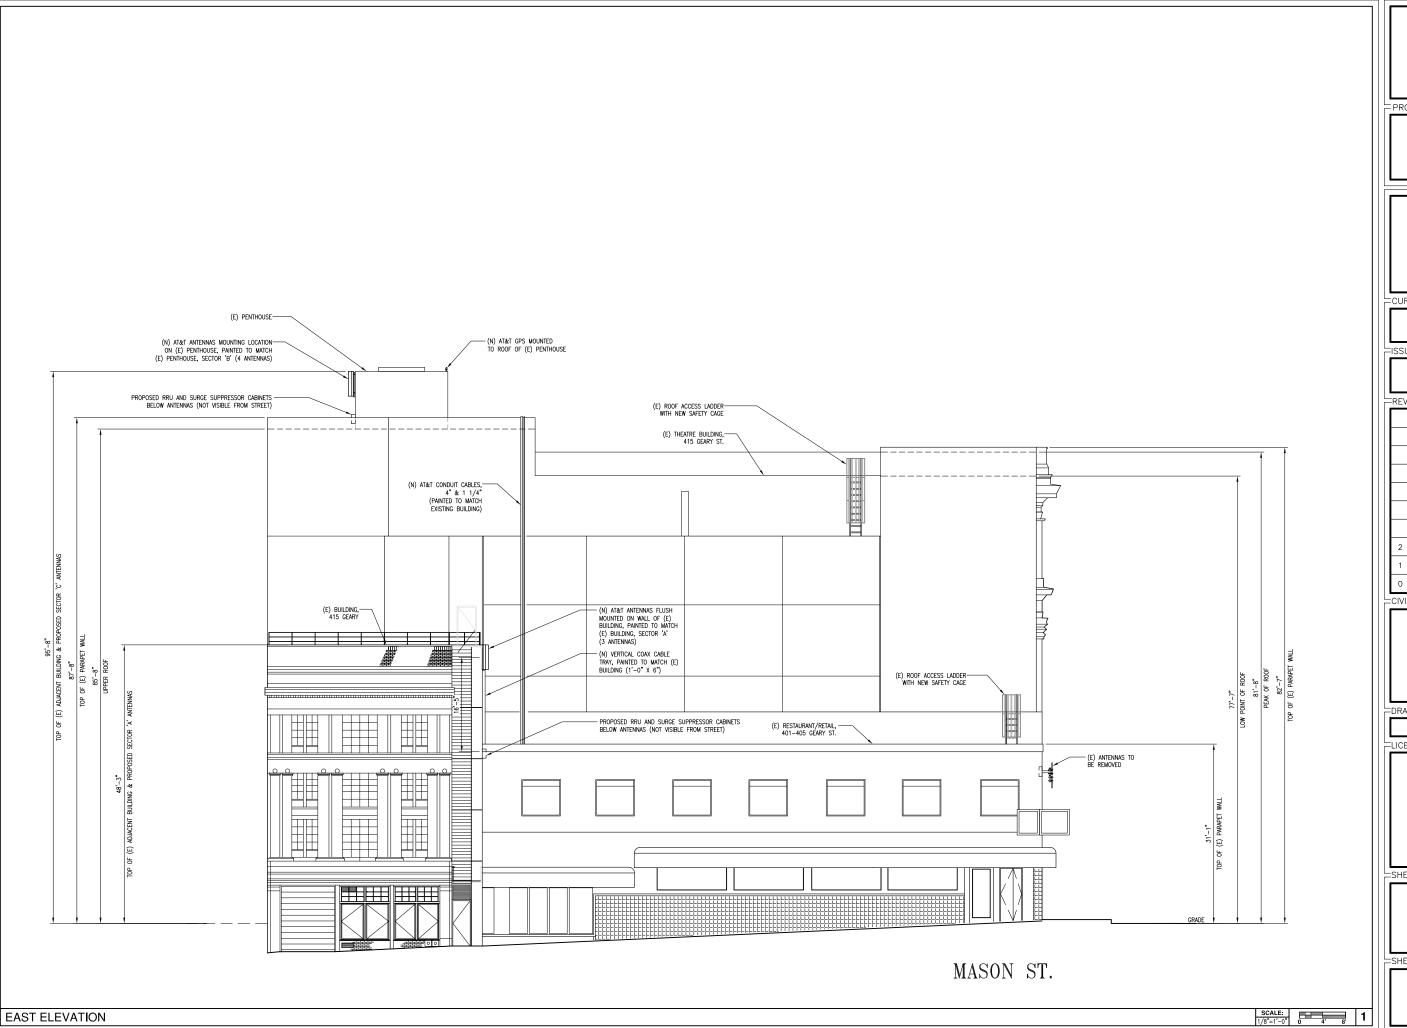
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430 BUSH ST., 5TH FLOOR SAN FRANCISCO, CA 94108

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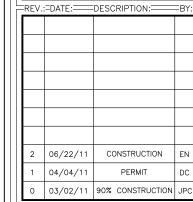
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JPC DC DC


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430 BUSH ST., 5TH FLOOR SAN FRANCISCO, CA 94108
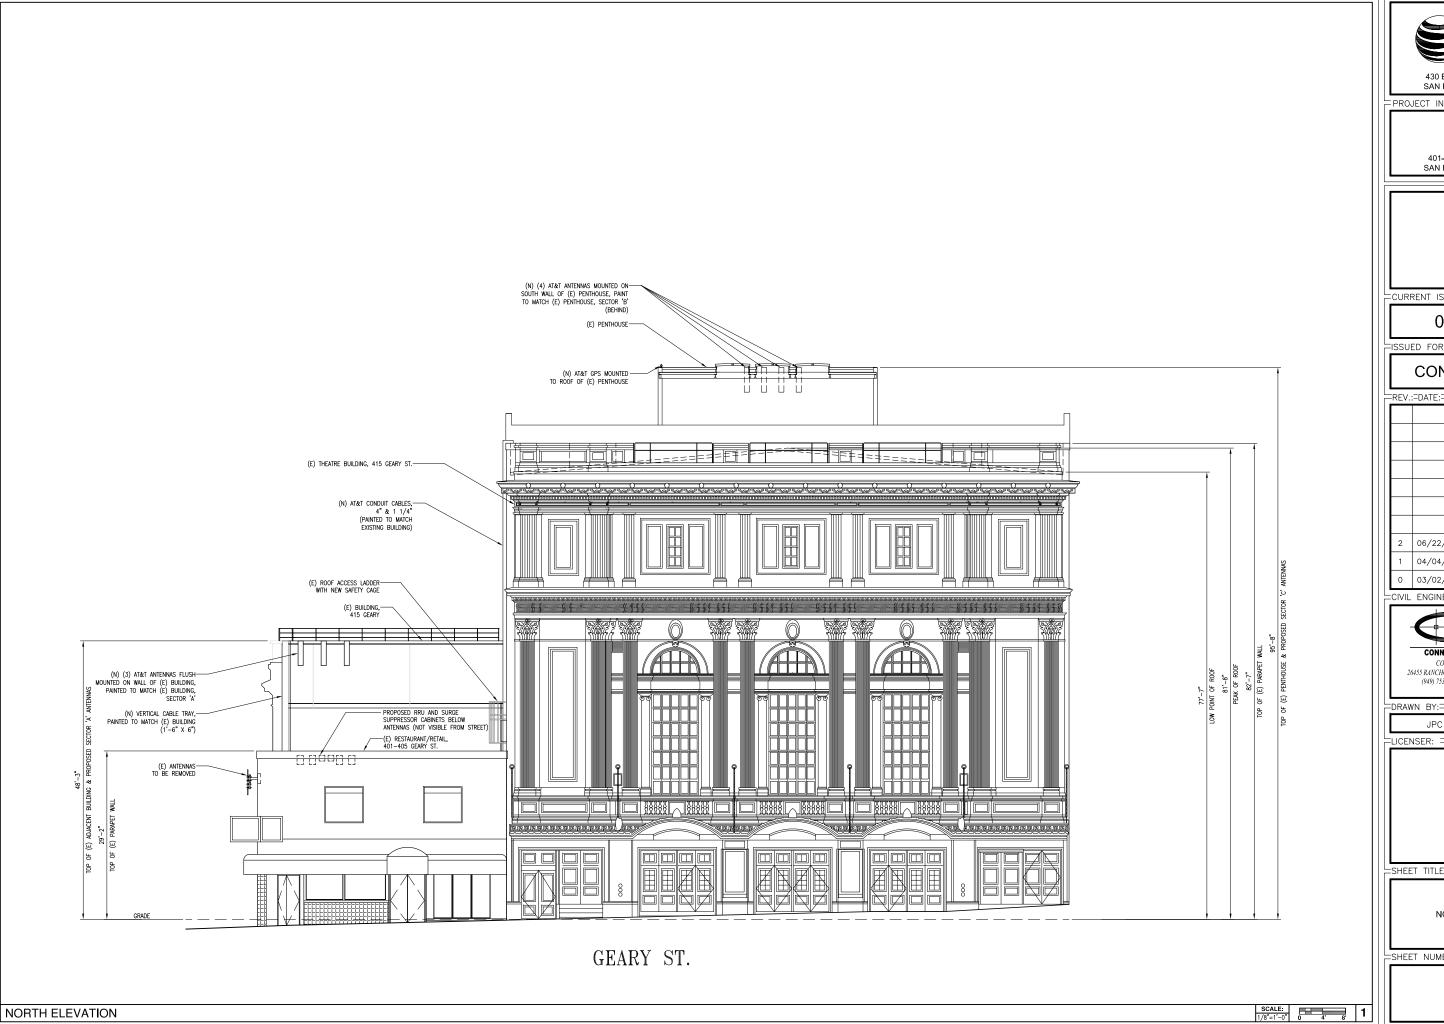
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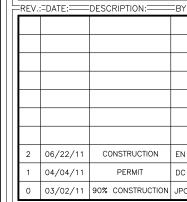
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=APV.: -CHK.:= DC DC LICENSER:

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NORTH ELEVATION

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A-6