

DATE: November 11, 2011

TO: Members of the Architectural Review Committee

FROM: Tim Frye, Preservation Coordinator, (415) 575-6822

RE: Case No. 2005.0233C, 49 Julian Avenue

At the request of the President of the Planning Commission, the Historic Preservation Commission (HPC) reviewed the proposed project at 49 Julian Avenue at its October 19, 2011 hearing. Since that hearing, the Project Sponsor has revised the proposal based the comments from the HPC. The Department is seeking review and comment on the revised proposal in anticipation of the Planning Commission hearing on November 17, 2011.

Specifically, in response to comments by the HPC, the Project Sponsor made the following changes to the building envelope:

- Minimized rooftop projections by relocating the rooftop open space to the 2nd floor rear terrace to reduce shadow on the adjacent Armory Building Drill Court windows. The modification removed a nine-foot high stair enclosure to roof, reduced the 14'-6" high elevator penthouse to 5-feet, and sloped the roof line of the required exit stair.
- 2. Setback the east wall of Units 402 and 502 (4th and 5th Floors) two feet from the east property line and 19 feet long in addition to the existing four-foot separation to allow more light and create a wider separation between the Armory and the proposed project.

Attachments: Plans and Renderings, revised November 2, 2010

1650 Mission St. Suite 400 San Francisco, CA 94103-2479

Reception:


415.558.6378

Fax: **415.558.6409** 

Planning Information: 415.558.6377




49 Julian April 6, 2011

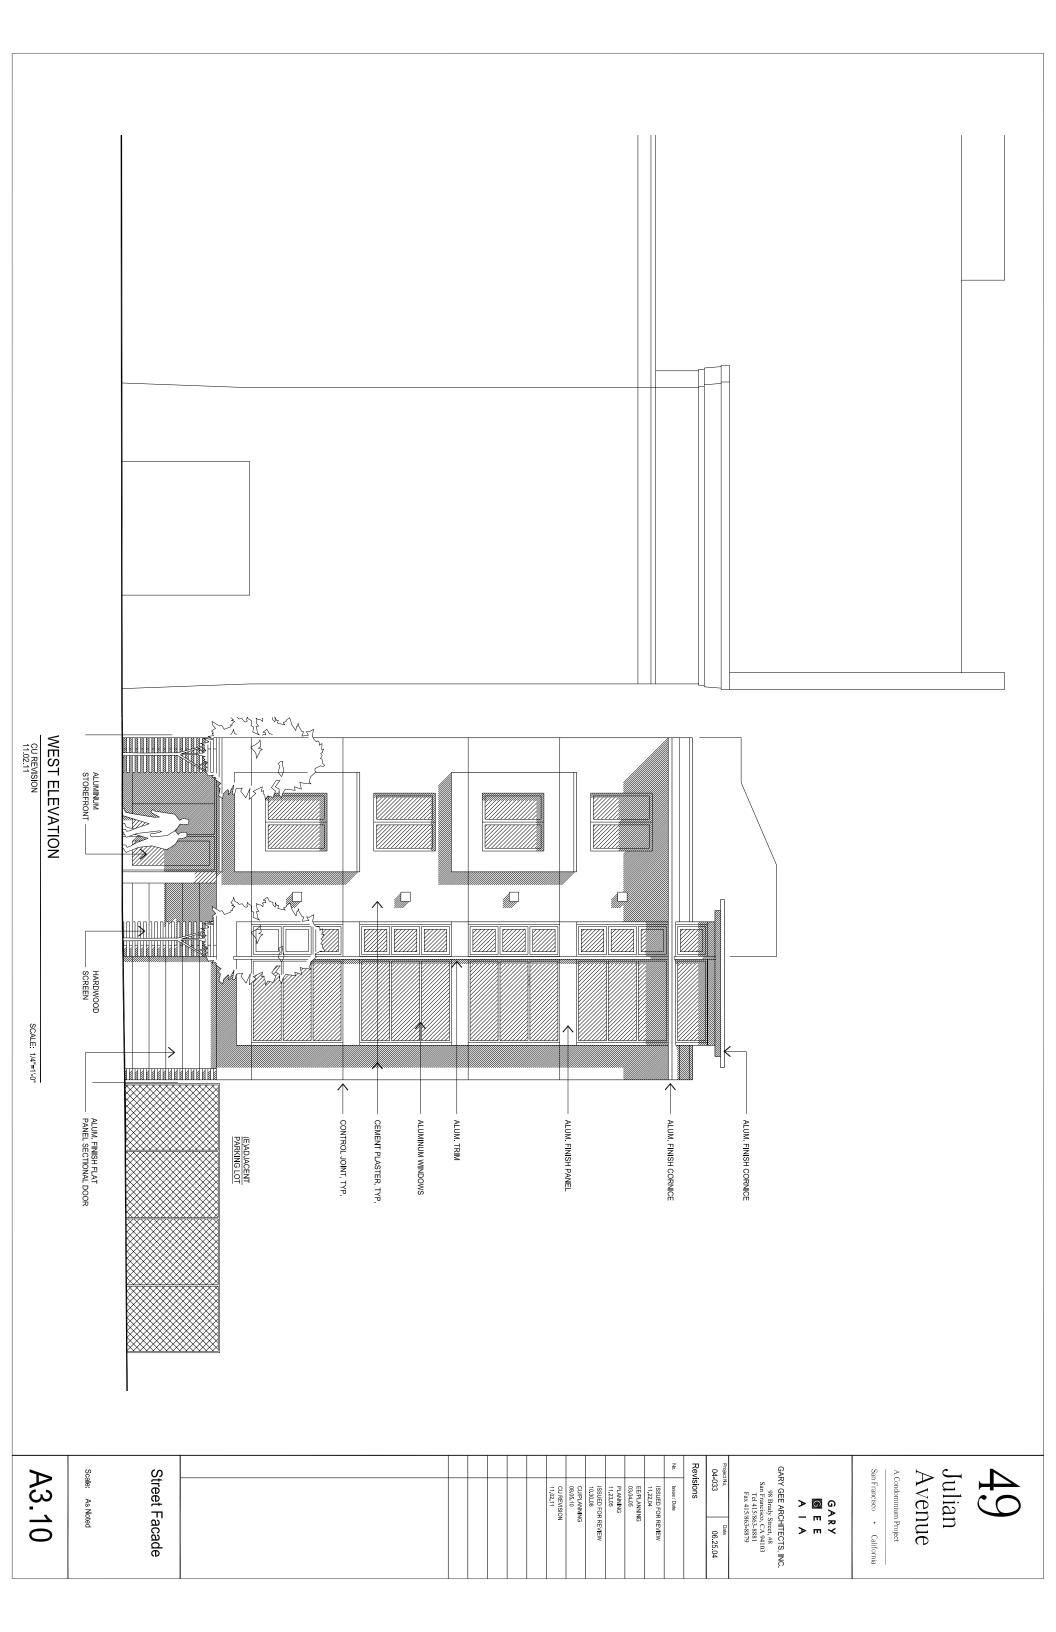





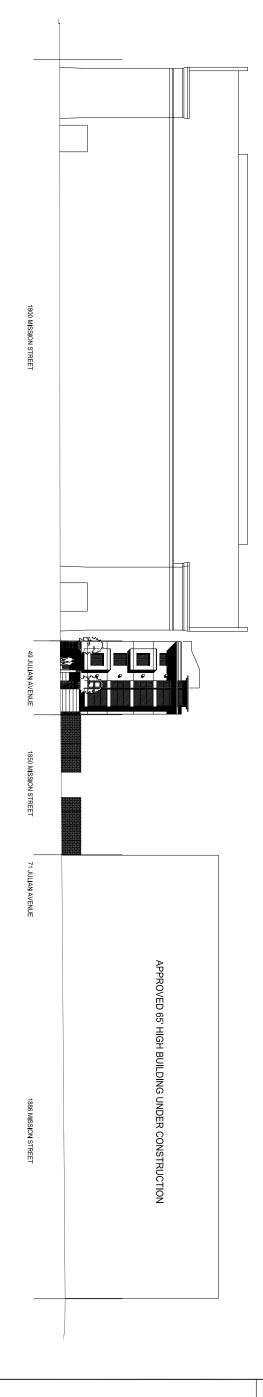

STREET ELEVATIONS - JULIAN AVENUE
OUREVISION
11.02.11

SCALE: 1/16"=1'-0"

A3.12

Scale: As Noted

Street Facade

49 Julian Avenue

G A R Y - E E

A Condominium Project


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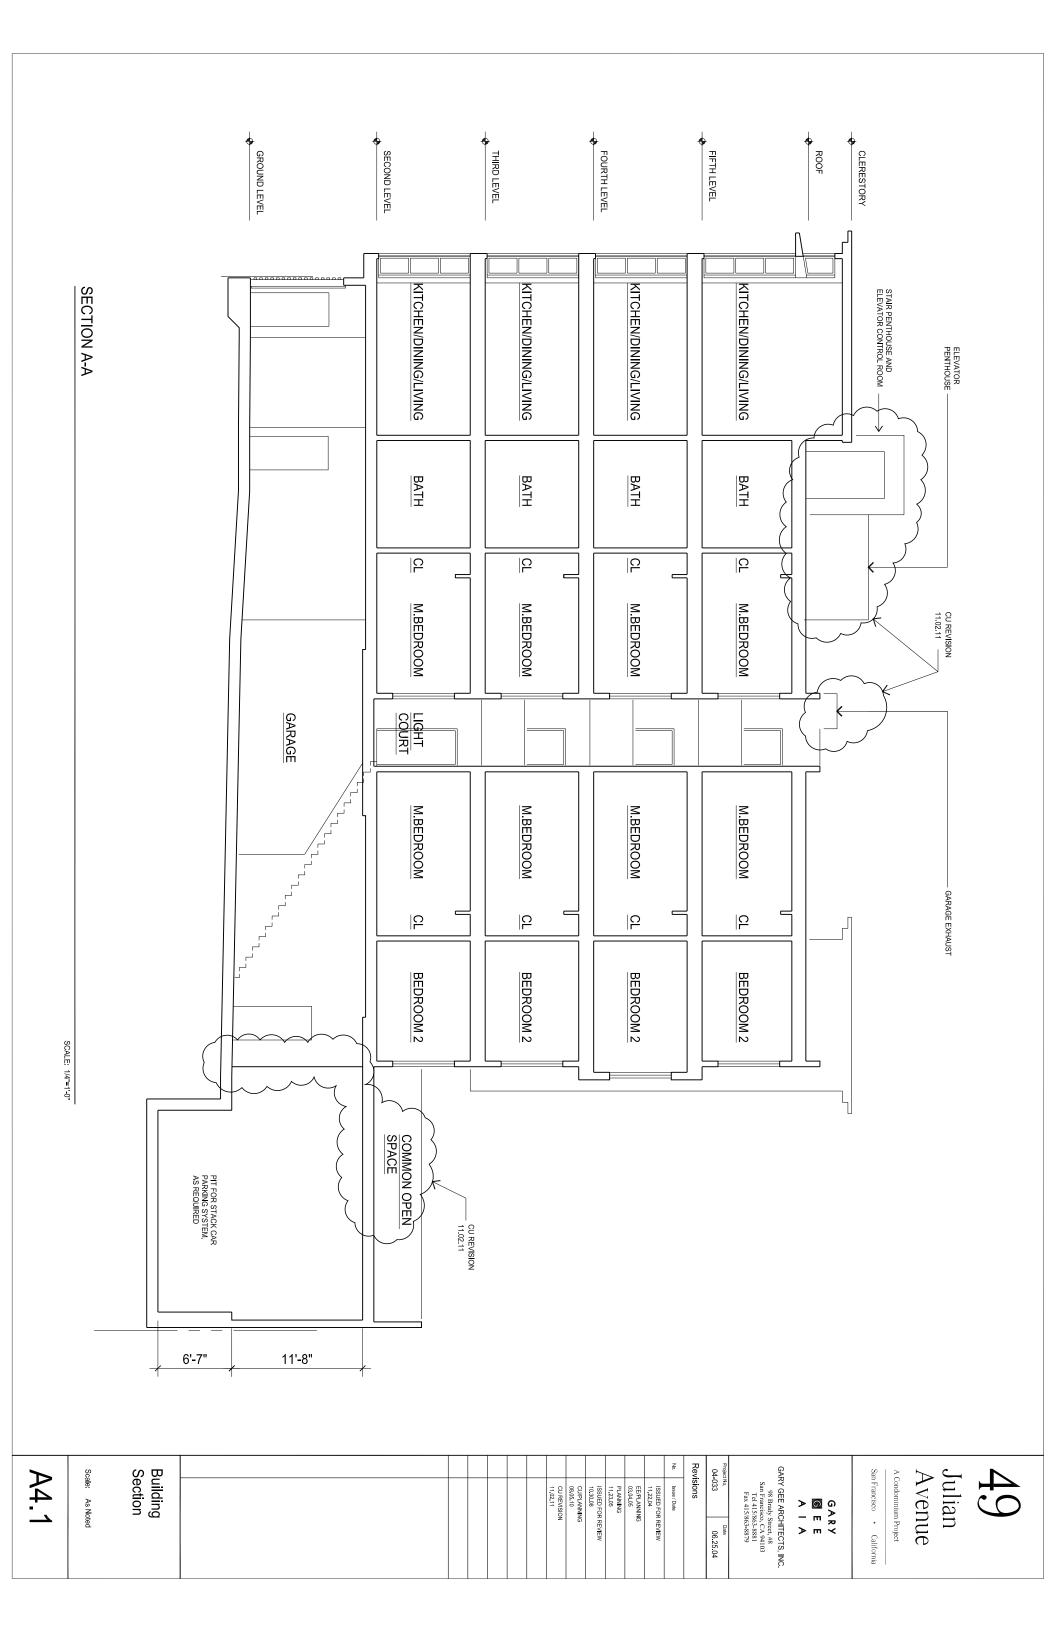
GARY GEE ARCHITECTS, INC. 98 Brady Street, #8 San Francisco, CA 94103 Tel 415/863-8881 Fax 415/863-8879 Project No. 04-033 Date 06.25.04


Revisions

Issue / Date

ISSUED FOR REVIEW
11.22.04
EEPLANING
03.04.05
PLANNING
11.23.05
ISSUED FOR REVIEW
10.30.08
00.05.10
CUPLANING
00.05.11
11.02.11




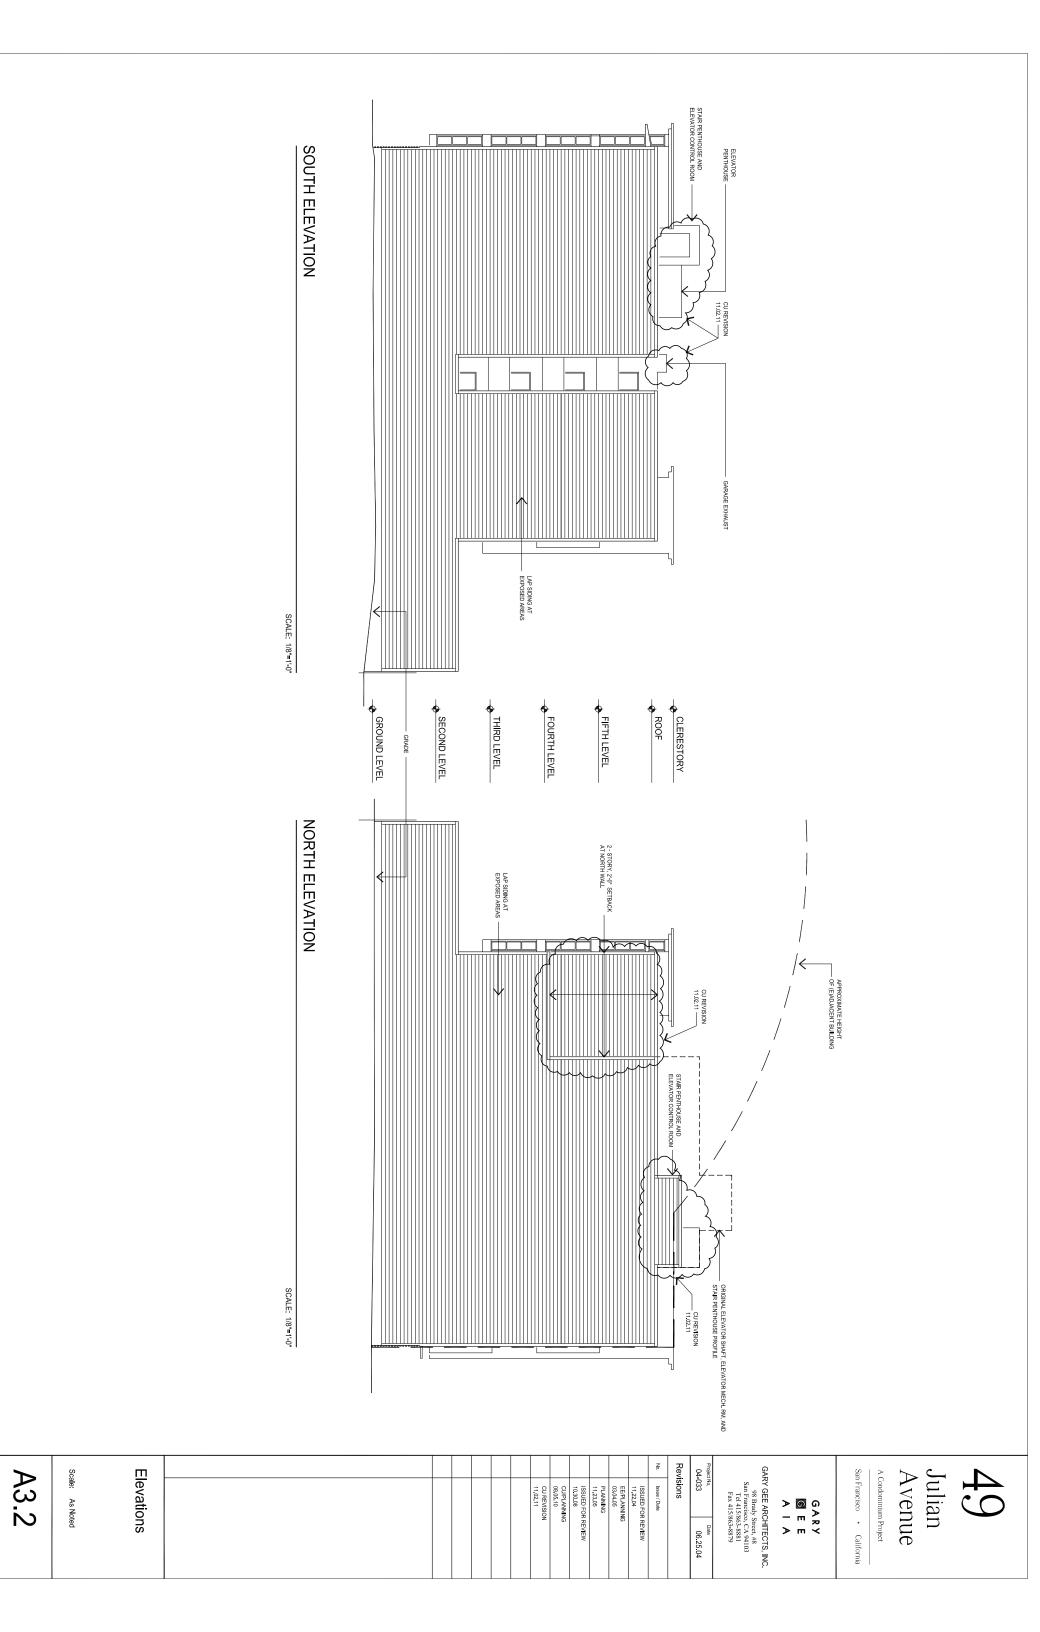


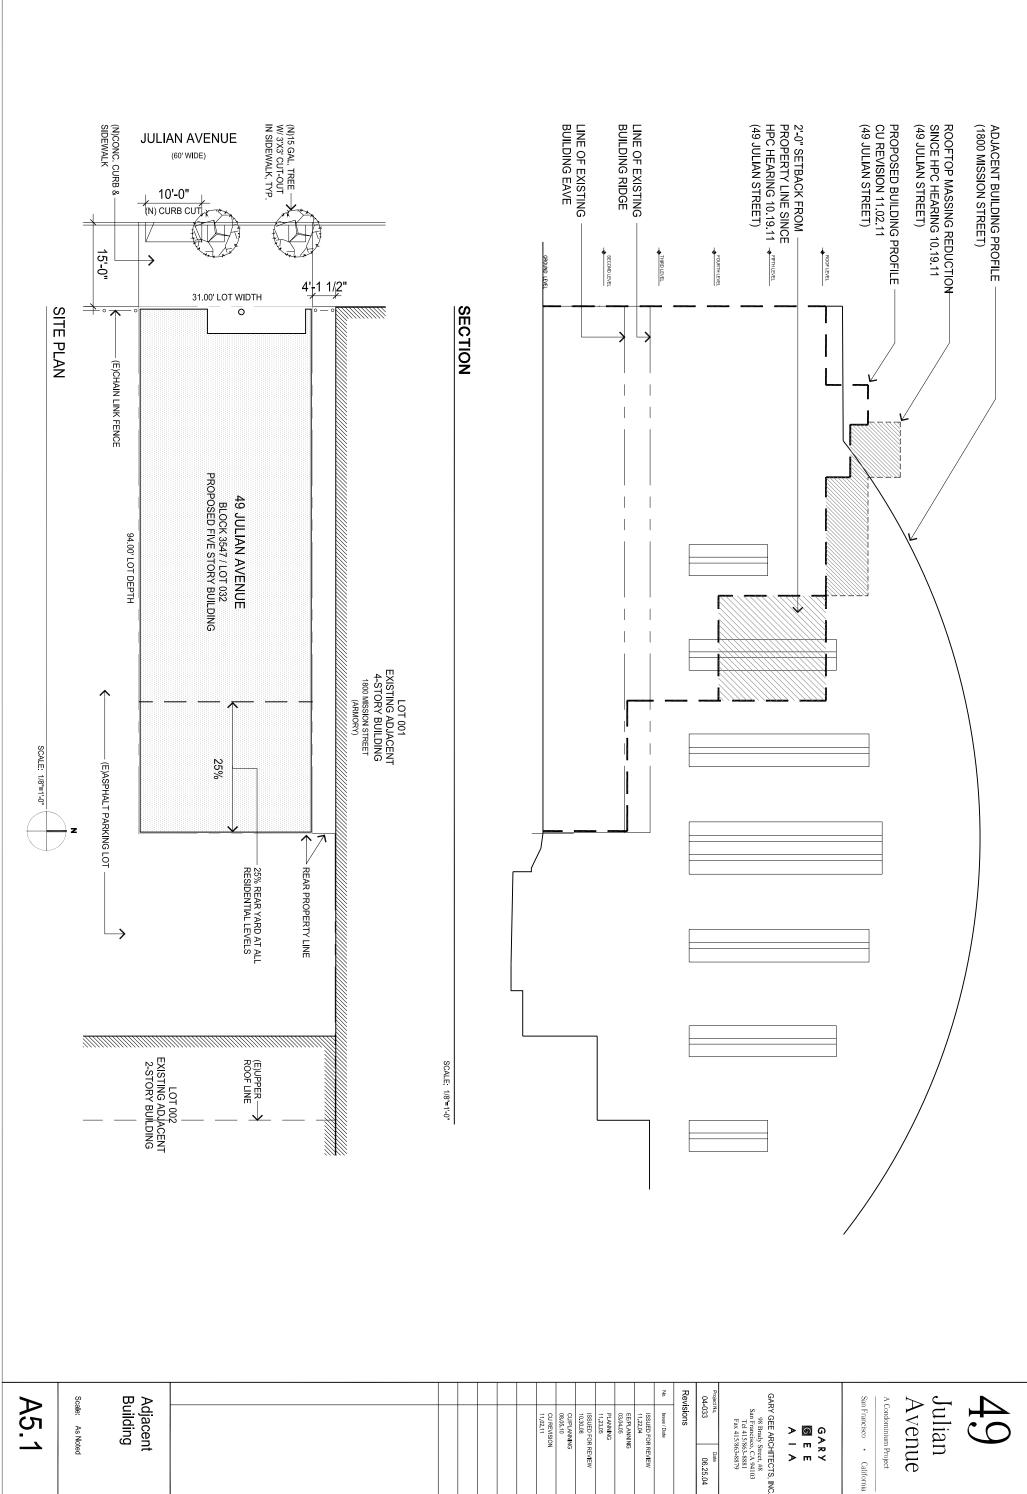



A Condominium Project

GARY GEE ARCHITECTS, INC.
98 Brady Street, #8
San Francisco, CA 94103
Tel 415/863-881
Fax 415/863-8879 Date 06.25.04

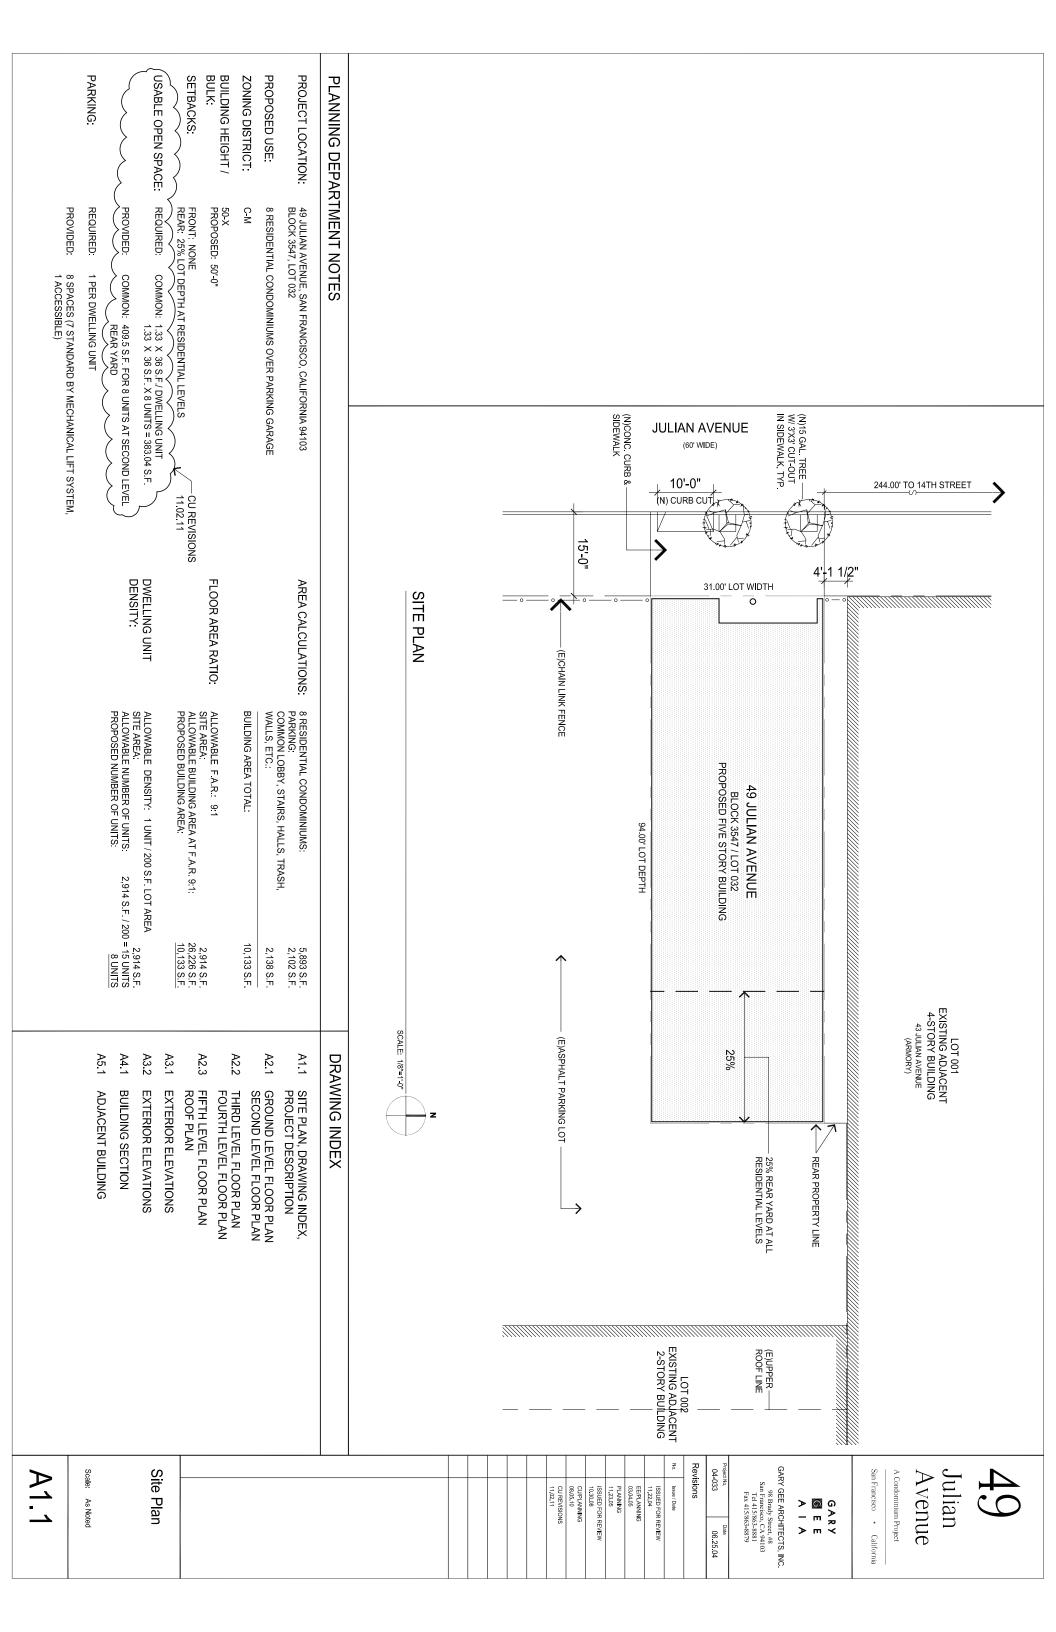

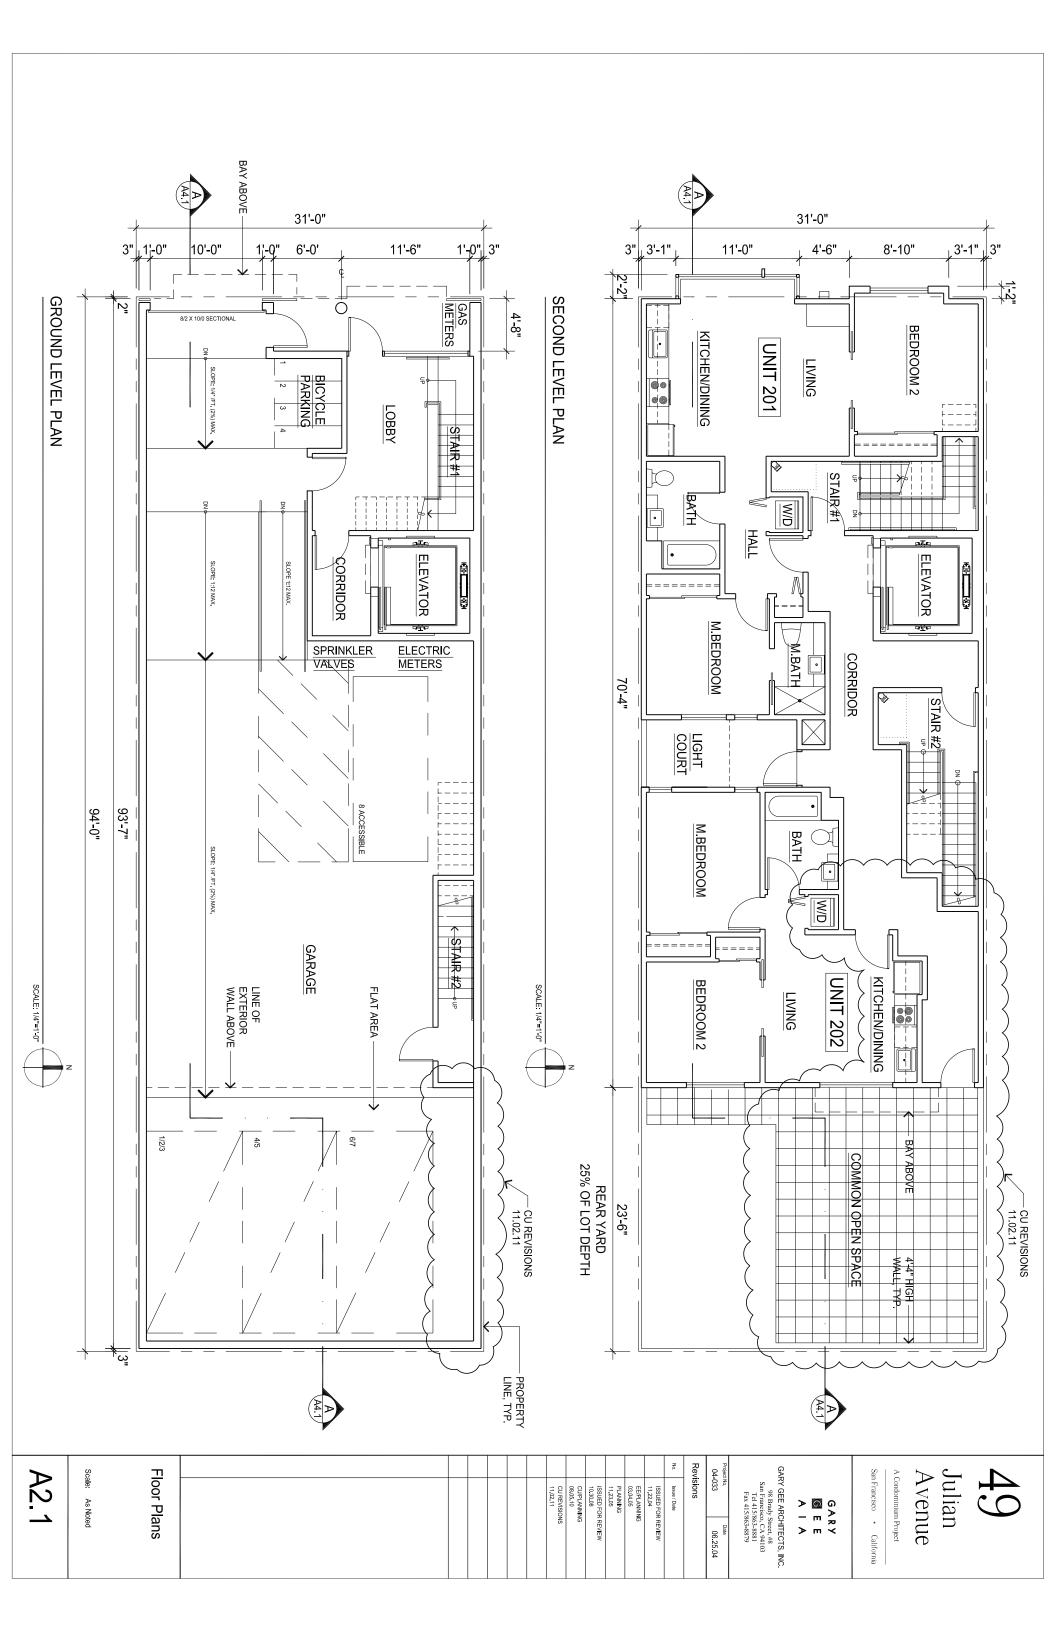

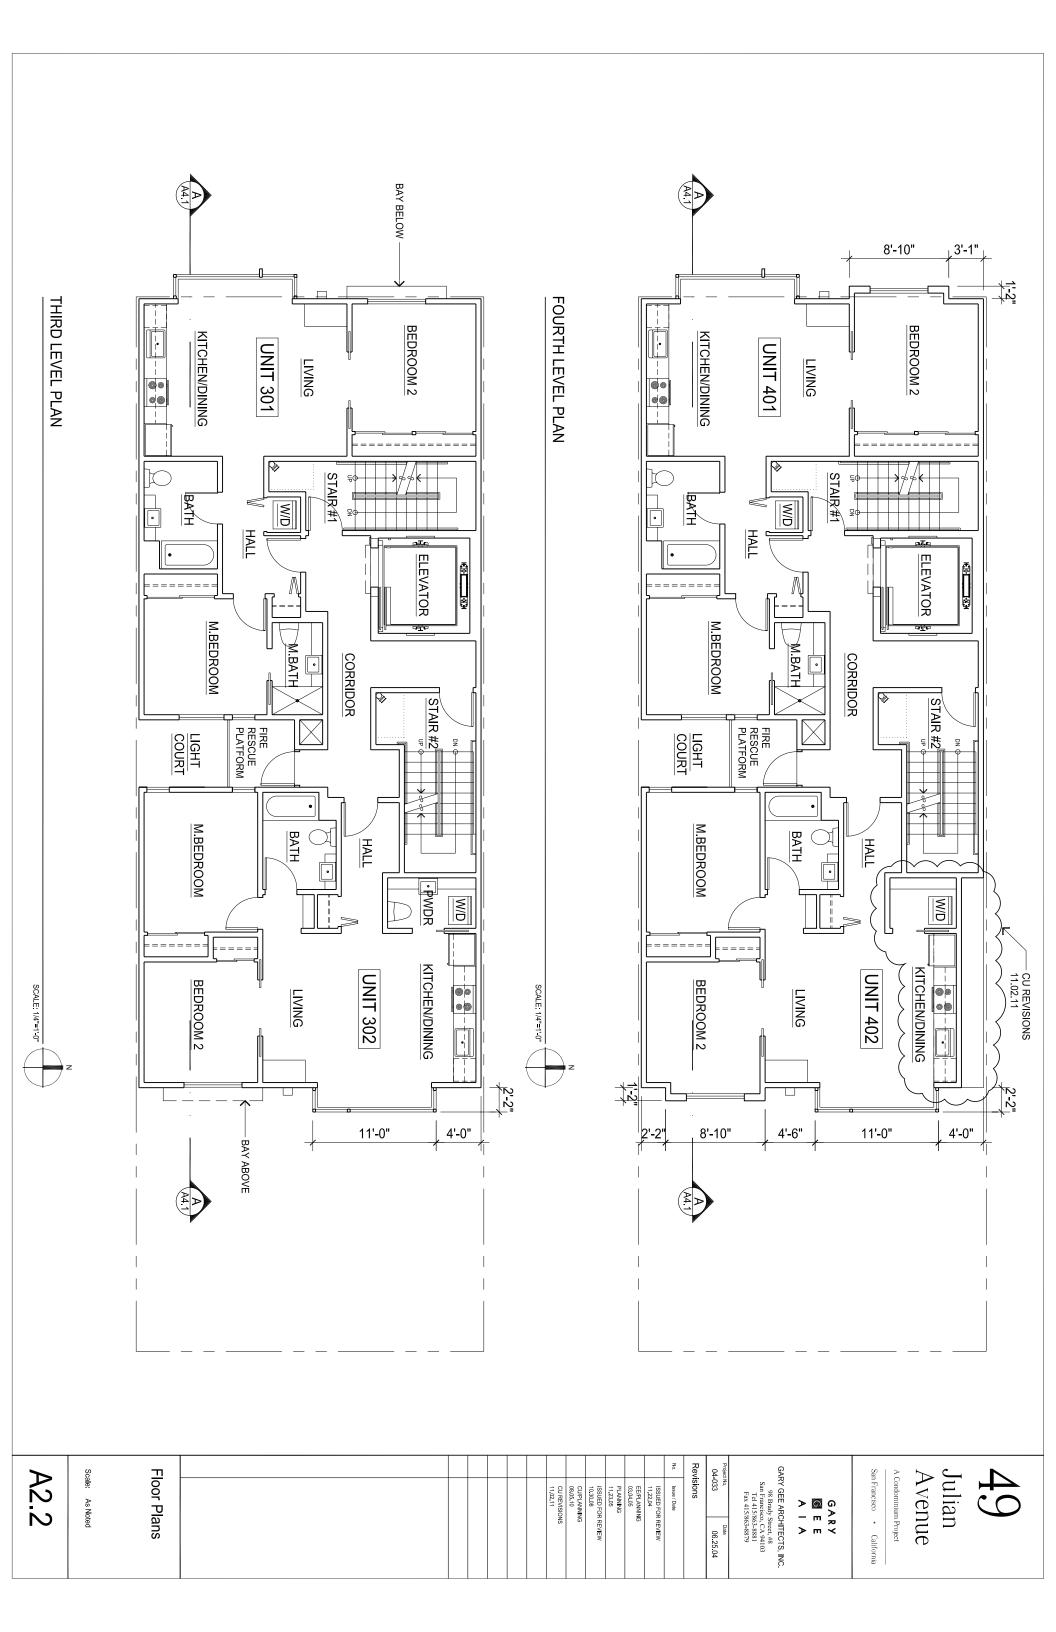

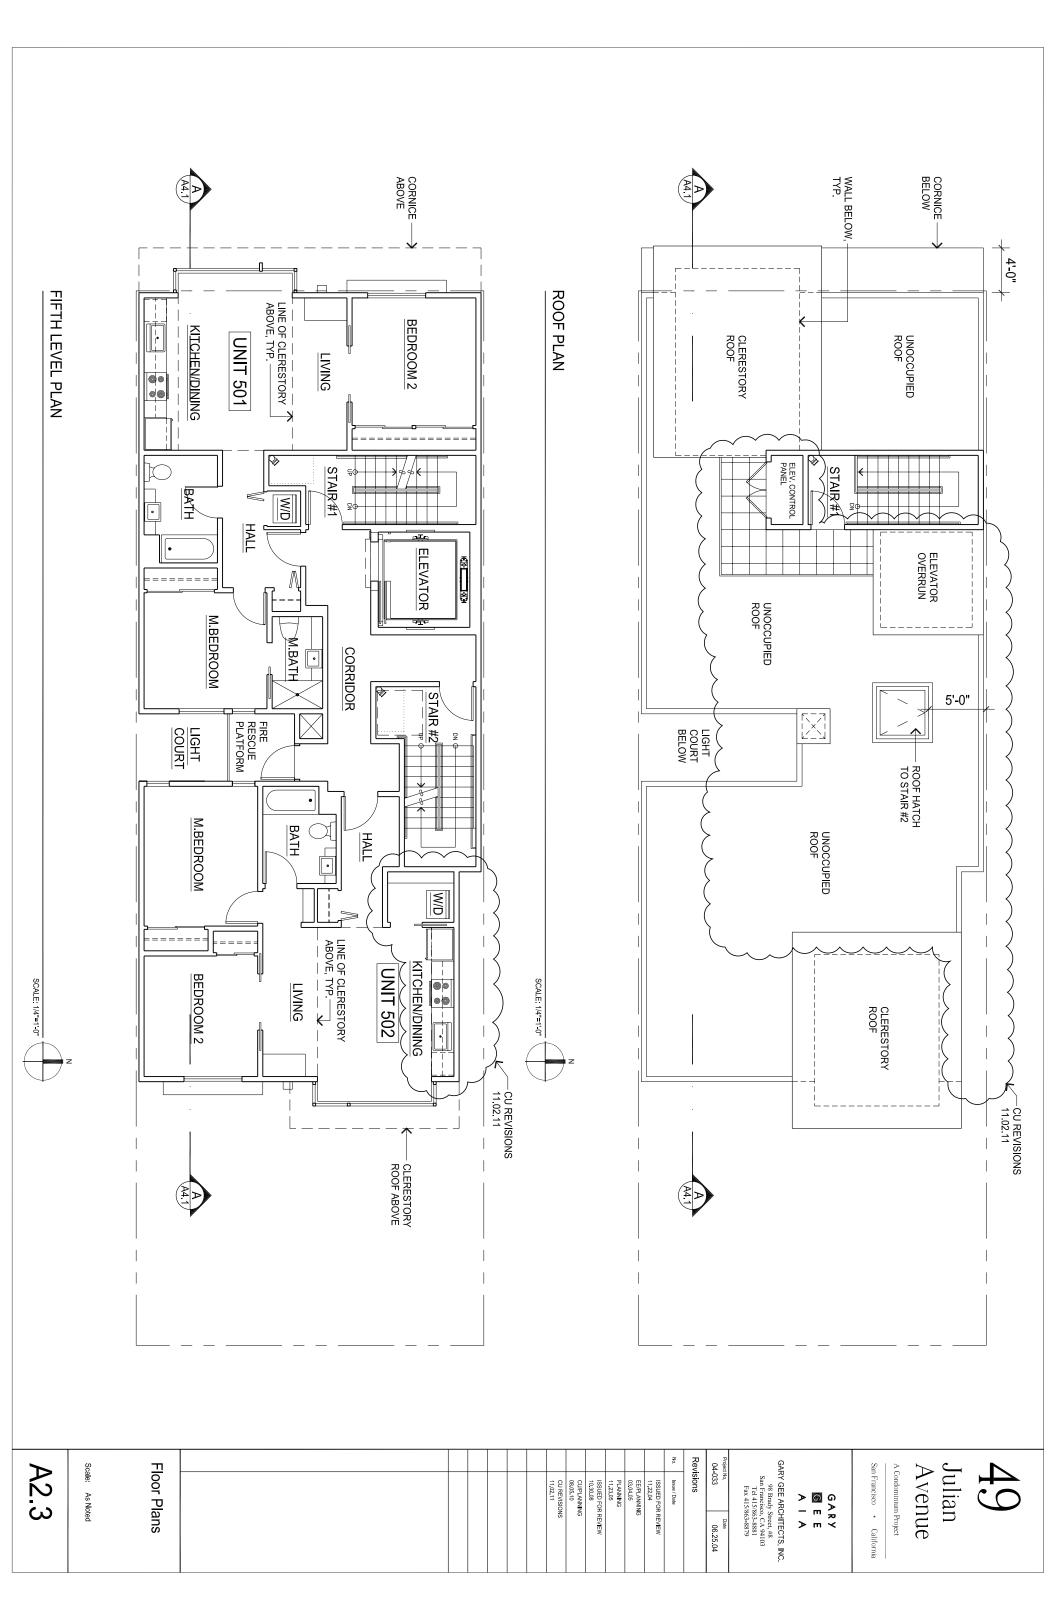

November 4, 2011

Mr. Ben Fu, Planner Planning Department 1650 Mission Street, Suite 400 San Francisco, CA 94103

## RE: 49 Julian Street CONDITIONAL USE DESIGN FLOOR PLAN CHANGES San Francisco, CA

Dear Mr. Fu:

Please find attached revised conditional use architectural drawings dated November 2, 2011:

## Sheet Title

- A1.1 Site Plan, Planning Notes
- A2.1 Ground & Second Level Plans
- A2.2 Third & Fourth Level Plans
- A2.3 Fifth Level and Roof Plans
- A3.1 West and East Building Elevations
- A3.2 North (Julian Street) and South Elevations
- A3.10 North (Julian Street) Composite Elevation with adjacent 1800 Mission Armory Building
- A3.11 Three (3) Julian Street elevation showing the design changes since March 4, 2005
- A3.12 Julian Street blockface elevation with Armory Building, 49 Julian building and 194 Unit Proposed 15<sup>th</sup> & Mission Street project.
- A4.1 Building Section
- A5.1 Armory Building South Elevation with 49 Julian overlay building profile Architectural Computer Rendering of the Julian Street Facade

In response to the design meeting with the Planning Staff on November 2, 2011 and the Historic Preservation Commission October 19, 2011 letter supporting this project with suggested recommendations, the project sponsor has requested the following plan changes:

- 1. Minimize rooftop projections by relocating the rooftop open space to the Second Floor rear terrace to reduce shadow patterns or any visual vistas to the curve roofline on the adjacent Armory Building (See Sheet A2.3 and A3.2).
  - This lowered the 14'-6" high elevator penthouse to 5'-0" in height (adjacent to roof stair penthouse).
  - Removed one (1) nine foot (9') high stair enclosure to the roof.
  - Removed all 3'-6" high open space perimeter wall on the roof.
  - Sculpture the roof line of the required one (1) stair to the roof.
  - Minimized shadows to the adjacent Armory Building.
  - Limit visual impairment of the vista to the curved Armory Building roofline.

- 2. Setback the east wall of Units 402 and 502 two feet (2') from the east property line to allow more light and create a wider space between buildings (See Sheet A2.2, A2.3, A3.1 and A3.2).
  - This setback is an 18'-9"x 19'-0" two (2) story high wall area two feet (2') further away from the southwestern second column window on the Armory Building.
  - This portion of the wall is now 6'-1 1/2" away from the adjacent southwestern second column window on the Armory building and allows more light between these buildings.
  - Reduced the 49 Julian Street building massing at the rear against the Armory Building.

These building design changes reduces the rooftop height and bulk projections, and creates more space between the buildings at the southwestern second column window on the Armory Building. The smaller first row southwestern window on the Armory Building was located against the required second means of egress stair for the proposed building, and there was no flexibility to modify the design of this stair.

Please contact me if you have any questions or need any additional information.

Very truly yours,

Gary Gee, AIA

cc: Tom McInerney John Ward Tony Kim Architecture/Planning/Interiors

98 Brady Street, #8 San Francisco, CA 94103-1239

Tel: 415/863-8881 Fax: 415/863-8879

November 8, 2011

Mr. Ben Fu, Planner Planning Department 1650 Mission Street, Suite 400 San Francisco, CA 94103

RE: 49 Julian Street CONDITIONAL USE APPLICATION San Francisco, CA

Dear Mr. Fu:

During the Historic Preservation Commission (HPC) hearing on Wednesday, October 19, 2011, the architect who was retained by Peter Acworth presented a Goggle Sketchup shadow diagram of our proposed building against the backdrop of the 1800 Mission Armory Building. We wish to point out the following:

## 1. The massing shown in this Goggle Sketchup model is inaccurate.

- The rooftop shows a continuous one (1) story structure in the middle of the roof approximately nine feet (9') in height. This rooftop bulk image is incorrect. Our drawings show a roof top deck open to the sky in this location.
- The south elevation of the model does not show the visible lightwell. Our drawings show this lightwell to break up the massing along the south property line wall on the proposed building.

The inaccuracies of this Goggle Sketchup model thus show more height and bulk, along with excessive shadow that does not reflect the real image or shadow patterns from our building onto the 1800 Mission Street Armory Building.

Please inform the Planning Commission of this condition because if this shadow model is used in a presentation, it will inaccuracy mislead the real shadow patterns of the proposed building.

Very truly yours,

Gary Gee, AIA

cc: Tim Frye, Planning Department Tom McInerney, John Ward, Tony Kim