MEMO

Disclaimer for Review of Plans

The San Francisco Planning Code requires that the plans of certain proposed projects be provided to members of the public prior to the City's approval action on the project. Accordingly, any images of plans featured on this website are provided for the primary purpose of facilitating public input prior to the City's action. The City and County of San Francisco does not own the copyright to these images. Please be aware that the unauthorized reproduction, distribution, or alteration of these images may result in a violation of Federal Copyright Law (17 U.S.C.A. Sections 101 et seq.) and that any party who seeks to reproduce or alter these images does so at his or her own risk.

Additionally, plans provided on this website are limited to site plans, elevations and/or section details (floor plans and structural details may not be included). These are DRAFT PLANS being provided for public review PRIOR to the City's approval action on the project. Final plans may differ from those that are currently available for review.

1650 Mission St. Suite 400 San Francisco, CA 94103-2479

Reception: 415.558.6378

Fax: 415.558.6409

Planning Information: 415.558.6377 **NOTICE OF PUBLIC HEARING**

Hearing Date: Wednesday, June 26, 2013

Time: **9:30 AM**

Location: City Hall, 1 Dr. Carlton B. Goodlett Place, Room 408

Case Type: Variance(Rear Yard)
Hearing Body: Zoning Administrator

PORPERTY INFORMATION		APPLICATION INFORMATION	
Project Address:	3844 Jackson Street	Case No.:	2013.0393V
Cross Street(s):	Cherry Street/Arguello Blvd.	Building Permit:	201304023601
Block / Lot No.:	0967/006	Applicant/Agent:	Scott Baughman
Zoning District(s):	RH-1 / 40-X	Telephone:	(415) 824-0478
Area Plan:	N/A	E-Mail:	scott@charliebarnettassoc.com

PROJECT DESCRIPTION

The proposal is to construct a deck approximately 5 feet above grade at the rear of the four-story, single-family house. The proposed 357 square-foot deck would extend approximately 13 feet into the rear yard at the second floor level and be approximately 5 feet above grade.

Section 134 of the Planning Code requires a minimum rear yard depth of approximately 20 feet for the subject property, measured from the rear property line. The subject property currently provides a 17 foot rear yard. The proposed deck would extend 13 feet into the required rear yard, providing a rear yard of approximately 4 feet depth for the subject property.

ADDITIONAL INFORMATION

FOR MORE INFORMATION, PLEASE CONTACT PLANNING DEPARTMENT STAFF:

Planner: Kanishka Burns Telephone: 415-575-9112 Mail: kanishka.burns@sfgov.org

ARCHITECTURAL PLANS: The site plan and elevations of the proposed project are available on the Planning Department's website at: http://sf-planning.org/ftp/files/notice/2013.0393V.pdf

中文詢問請電:558.6378

Para información en Español llamar al: 558.6378

GENERAL INFORMATION ABOUT PROCEDURES

VARIANCE HEARING INFORMATION

Under Planning Code Section 306.3, you, as a property owner or resident within 300 feet of this proposed project or interested party on record with the Planning Department, are being notified of this Variance Hearing. You are not obligated to take any action. For more information regarding the proposed work, or to express concerns about the project, please contact the Applicant/Agent or Planner listed on this notice as soon as possible. Additionally, you may wish to discuss the project with your neighbors and neighborhood association or improvement club, as they may already be aware of the project.

Persons who are unable to attend the public hearing may submit written comments regarding this application to the Zoning Administrator, Planning Department, 1650 Mission Street, Suite 400, San Francisco, CA 94103, by 5:00pm the day prior to the hearing. These comments will be made a part of the official public record, and will be brought to the attention of the person or persons conducting the public meeting or hearing

BUILDING PERMIT APPLICATION INFORMATION

Under Planning Code Section 311/312, the Building Permit Application for this proposal is also subject to a 30-day notification to occupants and owners within 150-feet of the subject property. On June 5, 2013, the Department issued the required Section 311 notification for this project (expires July 4, 2013).

BOARD OF APPEALS

An appeal of the approval (or denial) of a **variance application** by the Zoning Administrator may be made to the **Board of Appeals within 10 days** after the **Variance Decision Letter** is issued by the Zoning Administrator.

An appeal of the approval (or denial) of a **building permit application** by the Planning Department may be made to the **Board of Appeals within 15 days** after the **building permit** is issued (or denied) by the Director of the Department of Building Inspection.

Appeals must be submitted in person at the **Board's office at 1650 Mission Street, 3rd Floor, Room 304**. For further information about appeals to the Board of Appeals, including current fees, **contact the Board of Appeals** at **(415) 575-6880**.

ABOUT THIS NOTICE

The Planning Department is currently reviewing its processes and procedures for public notification as part of the Universal Planning Notification (UPN) Project. The format of this Public Hearing notice was developed through the UPN Project and is currently being utilized in a limited trial-run for notification of Variance Hearings.

If you have any comments or questions related to the UPN Project or the format of this notice, please visit our website at http://upn.sfplanning.org for more information.

中文詢問請電:558.6378

Para información en Español llamar al: 558.6378

PROPOSED SITE PLAN 1/8" = 1'-0"

JACKSON STREET RESIDENCE: REMODEL

3844 JACKSON STREET SAN FRANCISCO, CA 94118

OWNER

CONTRACTOR

STRUCTURAL

APPLICABLE CODES / REGULATIONS

2010 SAN FRANCISCO ELECTRICAL CODE AMENDMENTS

2010 SAN FRANCISCO MECHANICAL CODE AMENDMENTS

2010 CALIFORNIA GREEN BUILDING STANDARDS CODE (CALGREEN)

ITEMS UNDER DEFERRED OR SEPARATE PERMIT

ALL OTHER APPLICABLE STATE & LOCAL CODES, RULES, AND REGULATIONS

1. MECHANICAL, ELECTRICAL PERMIT TO BE SUBMITTED BY CONTRACTOR

2010 SAN FRANCISCO PLUMBING CODE AMENDMENTS

2007 SAN FRANCISCO HOUSING CODE AMENDMENTS

REQUIREMENTS. SEE CHAPTER 13C)

2010 CALIFORNIA BUILDING CODE (CBC)

2010 CALIFORNIA PLUMBING CODE (CPC)

2010 EXISTING BUILDING CODE (CBC)

2010 CALIFORNIA FIRE CODE (CFC)

2010 CALIFORNIA ENERGY CODE

ABBREVIATIONS

ABOVE

ADJ. ADJUSTABLE

ALUM. ALUMINUM

B.O. BOTTOM OF

B.U.R. BUILT-UP ROOFING

ASPH. ASPHALT

BD BOARD

BLDG. BUILDING

BLW. BELOW

BLKG. BLOCKING

BTW. BETWEEN

C.I.P. CAST IN PIPE

C.O. CLEAN OUT

CAB. CABINET

CLG. CEILING

CLO. CLOSET

COL. COLUMN

CONC. CONCRETE

CSMT. CASEMENT

CTR. CENTER

CW

DISP.

DN.

DW

EXP.

CONT. CONTINUOUS

CSK. COUNTERSINK

COLD WATER

DIAMETER

DOOR

DETAIL

EXISTING

DWG. DRAWING

ELEV. ELEVATION

EXT. EXTERIOR

EQUAL

F.F. FINISH FLOOR

EXPOSED

F.G. FINISHED GRADE

F.O.F. FACE OF FINISH

F.O.S. FACE OF STUD

FDN. FOUNDATION

FRPR. FIREPROOFING

GAUGE

GLASS

H.W. HOT WATER

HOR. HORIZONTAL

INT. INTERIOR

HEIGHT

HEATER

HDR. HEADER

HTR.

I.D.

HOSEBIB

FLR. FLOOR

FTG. FOOTING

F.O.C. FACE OF CONCRETE

FLOOR DRAIN

FILTERED WATER

GARBAGE DISPOSAL

GALVANIZED IRON

G.W.B. GYPSUM WALLBOARD

HOLLOW CORE

INSIDE DIAMETER

INSULATION

DWR. DRAWER

DIMENSION

DISHWASHER

GARBAGE DISPOSAL

DOUGLAS FIR

DOUBLE HUNG

CLR. CLEAR

BRONZE

CAST IRON

CENTER LINE

CMU CONCRETE MASONRY UNIT

A.F.F. ABOVE FINISHED FLOOR AB ANCHOR BOLT

AIR CONDITIONING

2010 CALIFORNIA HISTORIC BUILDING CODE

2010 CALIFORNIA MECHANICAL CODE (CMC) 2010 CALIFORNIA ELECTRICAL CODE (CEC)

SAN FRANCISCO LOCAL CODE & REGULATIONS

MICHAEL AND KIRSTEN GREEN 3844 JACKSON STREET SAN FRANCISCO, CA 94118

CHARLIE BARNETT & ASSOCIATES

SEMCO ENGINEERING

(415) 553-8810

360 LANGTON STREET SAN FRANCISCO, CA 94103

PROJECT MANAGER: SHAUN E. MOYNAHAN

JOIST HANGER

JUNCTION BOX

KILD DRIED

LEFT HAND

LAVATORY

MAXIMUM

MEDIUM

MINIMUM

MOUNTED

NOT TO SCALE

ON CENTER

OPFNING

PLATE

PANFI

RISER

. RADIUS

ROOM

REQUIRED

RESILIENT

REDWOOD

SOLID CORE

SOLID PIPE

SHOWER

SIMILAR

SPEAKER

STEEL

STAIN

TREAD

REINF. REINFORCED

PAINTED

RIGHT HAND

PAIR

PLYWD. PLYWOOD

NOT IN CONTRACT

PRESSURE TREATED

PLASTIC LAMINATE

RE-USE EXISTING

ROUGH OPENING

RAIN WATER LEADER

SEE ARCH. DRAWINGS

SEE CIVIL DRAWINGS

STAINLESS STEEL

STEEL TROWEL

TONGUE & GROOVE

TOP OF CONCRETE

TOP OF STEEL / SLAB

TOILET PAPER HOLDER

UNLESS OTHERWISE NOTED

TOP OF PLATE

TOP OF WALL

TUBE STEEL

THICKNESS

VENT PIPE

WOOD

WINDOW

VERIFY IN FIELD

WHERE OCCURS

WATER CLOSET

WATER HEATER

WATERPROOFING

VENT THROUGH ROOF

WEATHER STRIPPING

TYPICAL

SEE LANDSCAPE DRAWINGS

SEE STRUCTURAL DRAWINGS

METAL

MANUFACTURER

MISCELLANEOUS

JOIST

JOINT

LIGHT

∣JST.

JNT.

K.D.

MED.

MFR.

MISC.

MIN.

MTD.

N.T.S.

O.C.

P.T.

PNL.

PR.

PTD.

R.H.

R.W.L.

RAD. / R

REQ'D

RESIL.

RM.

S.A.D.

S.L.D.

S.C.

S.P.

S.S.

S.T.

SH.

SHR. SIM.

SPK.

STL.

STN.

T&G

T.O.C.

T.O.P.

T.O.S.

T.O.W.

T.P.H.

T.S.

TYP.

U.O.N.

V.T.R.

V.I.F.

W.O.

W.S.

WC WD.

WDW.

S.S.D.

OPG.

PLAM.

MTL.

MIR.

ARCHITECT

2010 SAN FRANCISCO BUILDING CODE AMENDMENTS (INCLUDES GREEN BUILDING

DRAWINGS.

3. ALL DIMENSIONS ARE TO FACE OF FINISHED WALL UNLESS OTHERWISE NOTED.

4. DO NOT SCALE DRAWINGS FOR DIMENSIONS. WRITTEN DIMENSIONS SHALL TAKE PRECEDENCE OVER SCALED DIMENSIONS

4. DO NOT SCALE DRAWINGS FOR DIMENSIONS.

1. IF THESE DRAWINGS ARE NOT 24" x 36" THEY HAVE BEEN REDUCED OR ENLARGED.

2. THE STANDARD A.I.A. GENERAL CONDITIONS ARE HEREBY MADE A PART OF THESE

5. DISCREPANCIES BETWEEN THESE DRAWINGS AND ACTUAL SITE CONDITIONS SHALL BE BROUGHT TO THE ATTENTION OF THE ARCHITECT PRIOR TO COMMENCEMENT OF ANY WORK. IF THE CONTRACTOR PROCEEDS WITH THE WORK WITHOUT VERIFYING EXISTING CONDITIONS AND DISCOVERS AFTER HIS WORK HAS STARTED THAT THERE ARE DISCREPANCIES BETWEEN THE DRAWINGS AND ACTUAL EXISTING CONDITIONS, HE SHALL PROCEED TO PERFORM WHATEVER WORK IS REQUIRED TO CORRECT THE DISCREPANCIES AND BRING ABOUT THE PROPER EXECUTION OF THE PROJECT TO THE SATISFACTION OF THE ARCHITECT AT NO EXTRA COST TO THE OWNER.

6. NO EXTRA COMPENSATION SHALL BE ALLOWED FOR EXTRA WORK RESULTING FROM LACK OF COORDINATION BETWEEN THE TRADES.

7. THE RECOMMENDATIONS OF THE ARBORIST MUST BE FOLLOWED FOR THE DURATION OF CONSTRUCTION. TREE PROTECTION FENCING MUST BE CONSTRUCTED PRIOR TO BUILDING PERMIT ISSUANCE AND MUST REMAIN FOR THE DURATION OF CONSTRUCTION.

CONTRACTOR DUTIES

1. THE CONTRACTOR SHALL:

GENERAL NOTES

(DO NOT SCALE DRAWINGS)

COORDINATION

A. FURNISH ALL MATERIALS, LABOR AND EQUIPMENT REQUIRED FOR THE FULL PERFORMANCE OF THE WORK HEREIN, UNLESS OTHERWISE NOTED (U.O.N.). ALL WORK SHALL BE PERFORMED IN A GOOD WORKMAN-LIKE MANNER AND CONFORM TO ALL PERTINENT REQULATIONS AND INSTRUCTIONS.

B. THE CONTRACTOR IS RESPONSIBLE FOR OBTAINING SEPARATE PERMITS FOR ELECTRICAL, MECHANICAL, PLUMBING, GRADING OR OTHER PERMITS AS MAY BE REQUIRED BY LOCAL AUTHORITIES. ISSUANCE OF A BUILDING PERMIT BASED ON THESE DRAWINGS DOES NOT CONSTITUTE GRANTING OF THESE SEPARATE PERMITS.
C. ARRANGE FOR ALL INSPECTIONS AS CALLED FOR IN SECTION 108.4 OF THE 2010 CBC.

2. CONTRACTOR SHALL INSTALL ALL MATERIALS AND EQUIPMENT IN ACCORDANCE WITH MANUFACTURER'S RECOMMENDATIONS AND ALL APPLICABLE CODES.

3. CONTRACTOR SHALL PROTECT EXISTING VEGETATION AND ADJACENT SITE IMPROVEMENTS FROM DAMAGE DURING THE COURSE OF THE WORK.

4. CONTRACTOR SHALL BRACE STRUCTURE AS REQUIRED DURING CONSTRUCTION.

5. CONTRACTOR SHALL PROVIDE STRICT CONTROL OF JOB CLEANUP TO REMOVE DUST AND DEBRIS FROM CONSTRUCTION AREA.

6. ALL SPECIAL INSPECTION AGENCIES, INDIVIDUALS, AND SHOP FABRICATORS SHALL BE APPROVED BY THE BUILDING DEPARTMENT PRIOR TO ANY WORK BEING

PERFORMED. CONTRACTOR SHALL SUBMIT ALL DOCUMENTATION FOR APPROVAL.

7. CONTRACTOR SHALL ENSURE 50% REDUCTION OF NON-HAZARDOUS CONSTRUCTION AND DEMOLITION WASTE OR LOCAL ORDINANCE, WHICHEVER IS MORE STRINGENT (EXCEPTION SOIL AND LAND-CLEARING DEBRIS), PER CALGREEN 4.408.

8. CONTRACTOR SHALL PROVIDE BUILDING OWNER WITH BUILDING AND MAINTENANCE MANUAL, PER CALGREEN 4.410.

GENERAL

1. PROVIDE SEISMIC ANCHORAGE OF ALL APPLIANCES, BOILERS AND WATER HEATERS.

2. VERIFY CLEARANCES FOR BOILERS, WATER HEATERS AND APPLIANCES PER MANUFACTURERS' SPECIFICATIONS AND INSTALL ACCORDINGLY.

3. PROVIDE EXHAUST VENTILATION TO THE OUTSIDE FROM ALL GAS BURNING APPLIANCES.4. PROVIDE MIN. 100 SQ. IN. EACH UPPER AND LOWER COMBUSTION AIR CLEAR

OPENINGS FOR WATER HEATERS, BOILERS, FURNACES, AND OTHER GAS BURNING APPLIANCES. LOCATE OPENINGS WITHIN 12 INCH FROM FLOOR AND WITHIN 12 INCH FROM CEILING.

5. ENCLOSED ACCESSIBLE SPACE UNDER-STAIR SURFACE AND ANY SOFFITS PROTECTED ON THE ENCLOSED SIDE WITH 1/2 INCH GYPSUM BOARD, PER CBC 1009.6.3.

6. PER CBC 406.1.4, THE PRIVATE GARAGE SHALL BE SEPARATED FROM THE DWELLING UNIT AND ITS ATTIC AREA BY MEANS OF A MINIMUM 1/2 INCH GYPSUM BOARD APPLIED TO THE GARAGE SIDE. GARAGES BENEATH HABITABLE ROOMS SHALL BE SEPARATED FROM ALL HABITABLE ROOMS ABOVE BY NOT LESS THAN A 5/8 INCH TYPE X GYPSUM BOARD OR EQUIVALENT. DOOR OPENINGS BETWEEN A PRIVATE GARAGE AND THE DWELLING UNIT SHALL BE EQUIPPED WITH EITHER SOLID WOOD DOORS OR SOLID OR HONEYCOMB CORE STEEL DOORS NOT LESS THAN 1 3/8 INCHES THICK, OR DOORS IN COMPLIANCE WITH SECTION 715.4.3. DOORS SHALL BE SELF-CLOSING AND SELF-LATCHING. DUCTS IN A PRIVATE GARAGE AND DUCTS PENETRATING THE WALLS OR CEILINGS SEPARATING THE DWELLING UNIT FROM THE GARAGE SHALL BE CONSTRUCTED OF A MINIMUM 0.019 INCH SHEET STEEL AND SHALL HAVE NO OPENINGS INTO THE GARAGE.

7. DENSHIELD OR EQ. TO BE INSTALLED IN ALL WET LOCATIONS IN BATHROOMS. DENSHIELD OR EQ. MUST BE INSTALLED TO A POINT A MIN. OF 72 INCH ABOVE THE SHOWER DRAIN. DO NOT INSTALL A VAPOR BARRIER BEHIND IT AND THE FRAMING. CORROSION RESISTANT FASTENERS MUST BE USED. CONCRETE BOARD REQUIRES A VAPOR BARRIER INSTALLED IN BETWEEN IT AND THE FRAMING. CORROSION RESISTANT FASTENERS MUST BE USED.

8. GLAZING IN LOCATIONS SUBJECT TO HUMAN IMPACT SHALL BE OF TEMPERED / SHATTER PROOF SAFETY GLASS. USE SAFETY GLAZING AT DOORS, GLAZING ADJACENT TO DOORS WITHIN 24" OF THE VERTICAL EDGES OF THE DOOR, GLAZING WITHIN 5 FT. FROM THE TOP AND BOTTOM OF STAIRS, GLAZING LESS THAN 18" ABOVE FLOOR LEVEL, GLAZING IN DOORS AND ENCLOSURES OF TUBS AND SHOWERS, AND GLAZING IN WARDROBE DOORS PER UBC SEC. 2406.4. WINDOWS WITHIN 60 INCHES FROM TUB OR SHOWER FLOOR REQUIRE SAFETY GLAZING.

9. VAPOR RETARDER AND CAPILLARY BREAK SHALL BE INSTALLED FOR SLAB ON GRADE FOUNDATION. SHALL HAVE MINIMUM 4" OF 1/2" CLEAN AGGREGATE BASE BETWEEN VAPOR RETARDER AND SLAB IN ACCORDANCE WITH CALGREEN 4.505.

10. PROVIDE BACKFLOW PREVENTION VALVE ON MAIN SEWAGE CONNECTION AND ALL POTABLE WATER.

11. INSTALL SOLID BLOCKING AS REQUIRED FOR FINISH HARDWARE, CABINETS, TRIM, PLUMBING ACCESSORIES, AND FIXTURES.

12. PRE-PRIME KNOTS IN LUMBER WITH ZINSSER'S "BIN" PRIMER SEALER OR APPROVED EQUAL.

13. ALL PORTIONS OF WOOD EXPOSED TO WEATHER TO BE OF NATURAL RESISTANCE TO DECAY OR TREATED WOOD.

14. ALL CUT OR NOTCHED TREATED WOOD SHALL BE SEALED WITH COPPER GREEN WOOD PRESERVATIVE SEALER.

15. ALL EXTERIOR SHEATING TO BE 1/2" THK. PLYWOOD UNLESS OTHERWISE NOTED IN STRUCTURAL DRAWINGS.

LIFE SAFETY

16. SMOKE DETECTORS SHALL BE HARD-WIRED IN CEILINGS AND EQUIPPED WITH A BATTERY BACKUP IN ACCORDANCE WITH CBC 907. REFER TO ME0.0 FOR MORE

17. PER CBC 420.4.1, FOR NEW CONSTRUCTION AN APPROVED CARBON MONOXIDE ALARM SHALL BE INSTALLED IN DWELLING UNITS AND IN SLEEPING UNITS WITHIN WHICH FUEL-BURNING APPLIANCES ARE INSTALLED; AND IN DWELLING UNITS THAT HAVE ATTACHED GARAGES. REFER TO ME0.0 FOR MORE INFORMATION.

SCOPE OF WORK

NEW WOOD DECK WITHIN THE REAR YARD SETBACK. NO NEW FLOOR AREA ADDED.

626 HAMPSHIRE STREET SAN FRANCISCO, CA 94110 (415) 824-0478 **PROJECT INFORMATION:**

A.P.N.	0967-006	
OCCUPANCY GROUP CONSTRUCTION TYPE	R-1 V	
ZONING DISCTRICT	RH-1	

EXISTING AREA (NO CHANGES)


LOT AREA	2,705SF
FIRST FLOOR	1,658SF
SECOND FLOOR	1,427SF
THIRD FLOOR	1,265SF
TOTAL	4,350SF
GARAGE FLOOR	1,711SF

DRAWING INDEX

COVER SHEET, PROPOSED SITE PLAN AND GENERAL NOTES EXISTING SITE PLAN SITE PHOTOS	A0.0 A0.1 A0.2
PROPOSED DECK PLAN EXTERIOR ELEVATIONS - NORTH EXTERIOR ELEVATIONS - WEST EXISTING EXTERIOR ELEVATIONS - WEST PROPOSED EXTERIOR ELEVATIONS - EAST EXISTING	A2.3 A3.0 A3.1 A3.2 A3.3

S-2 FRAMING DETAILS


LOCATION MAP

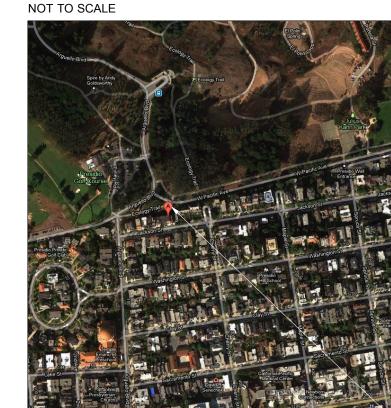

SUBJECT PROPERTY
3844 JACKSON STREET

GENERAL NOTES

1ST FLOOR/FOUNDATION PLAN/2ND FLOOR FRAMING

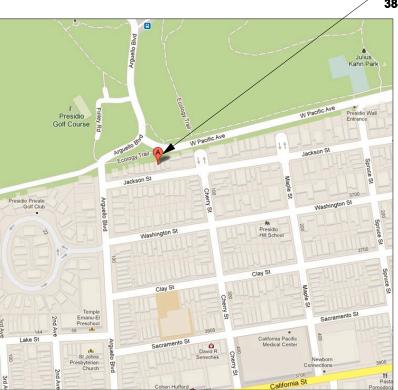

RESIDENC

MODEL

HARLIE

BARNETT

SSOCIATES

ARCHITECTURE

PLANNING

626 Hampshire Street

San Francisco, CA 94110

el 415-824-0478

Fax 415-824-0462

RECORD:

COVER, SITE PLAN


& GENERAL NOTES

DRAWN BY:

DATE: MAY 7, 2013

SCALE: AS NOTED

A0.0

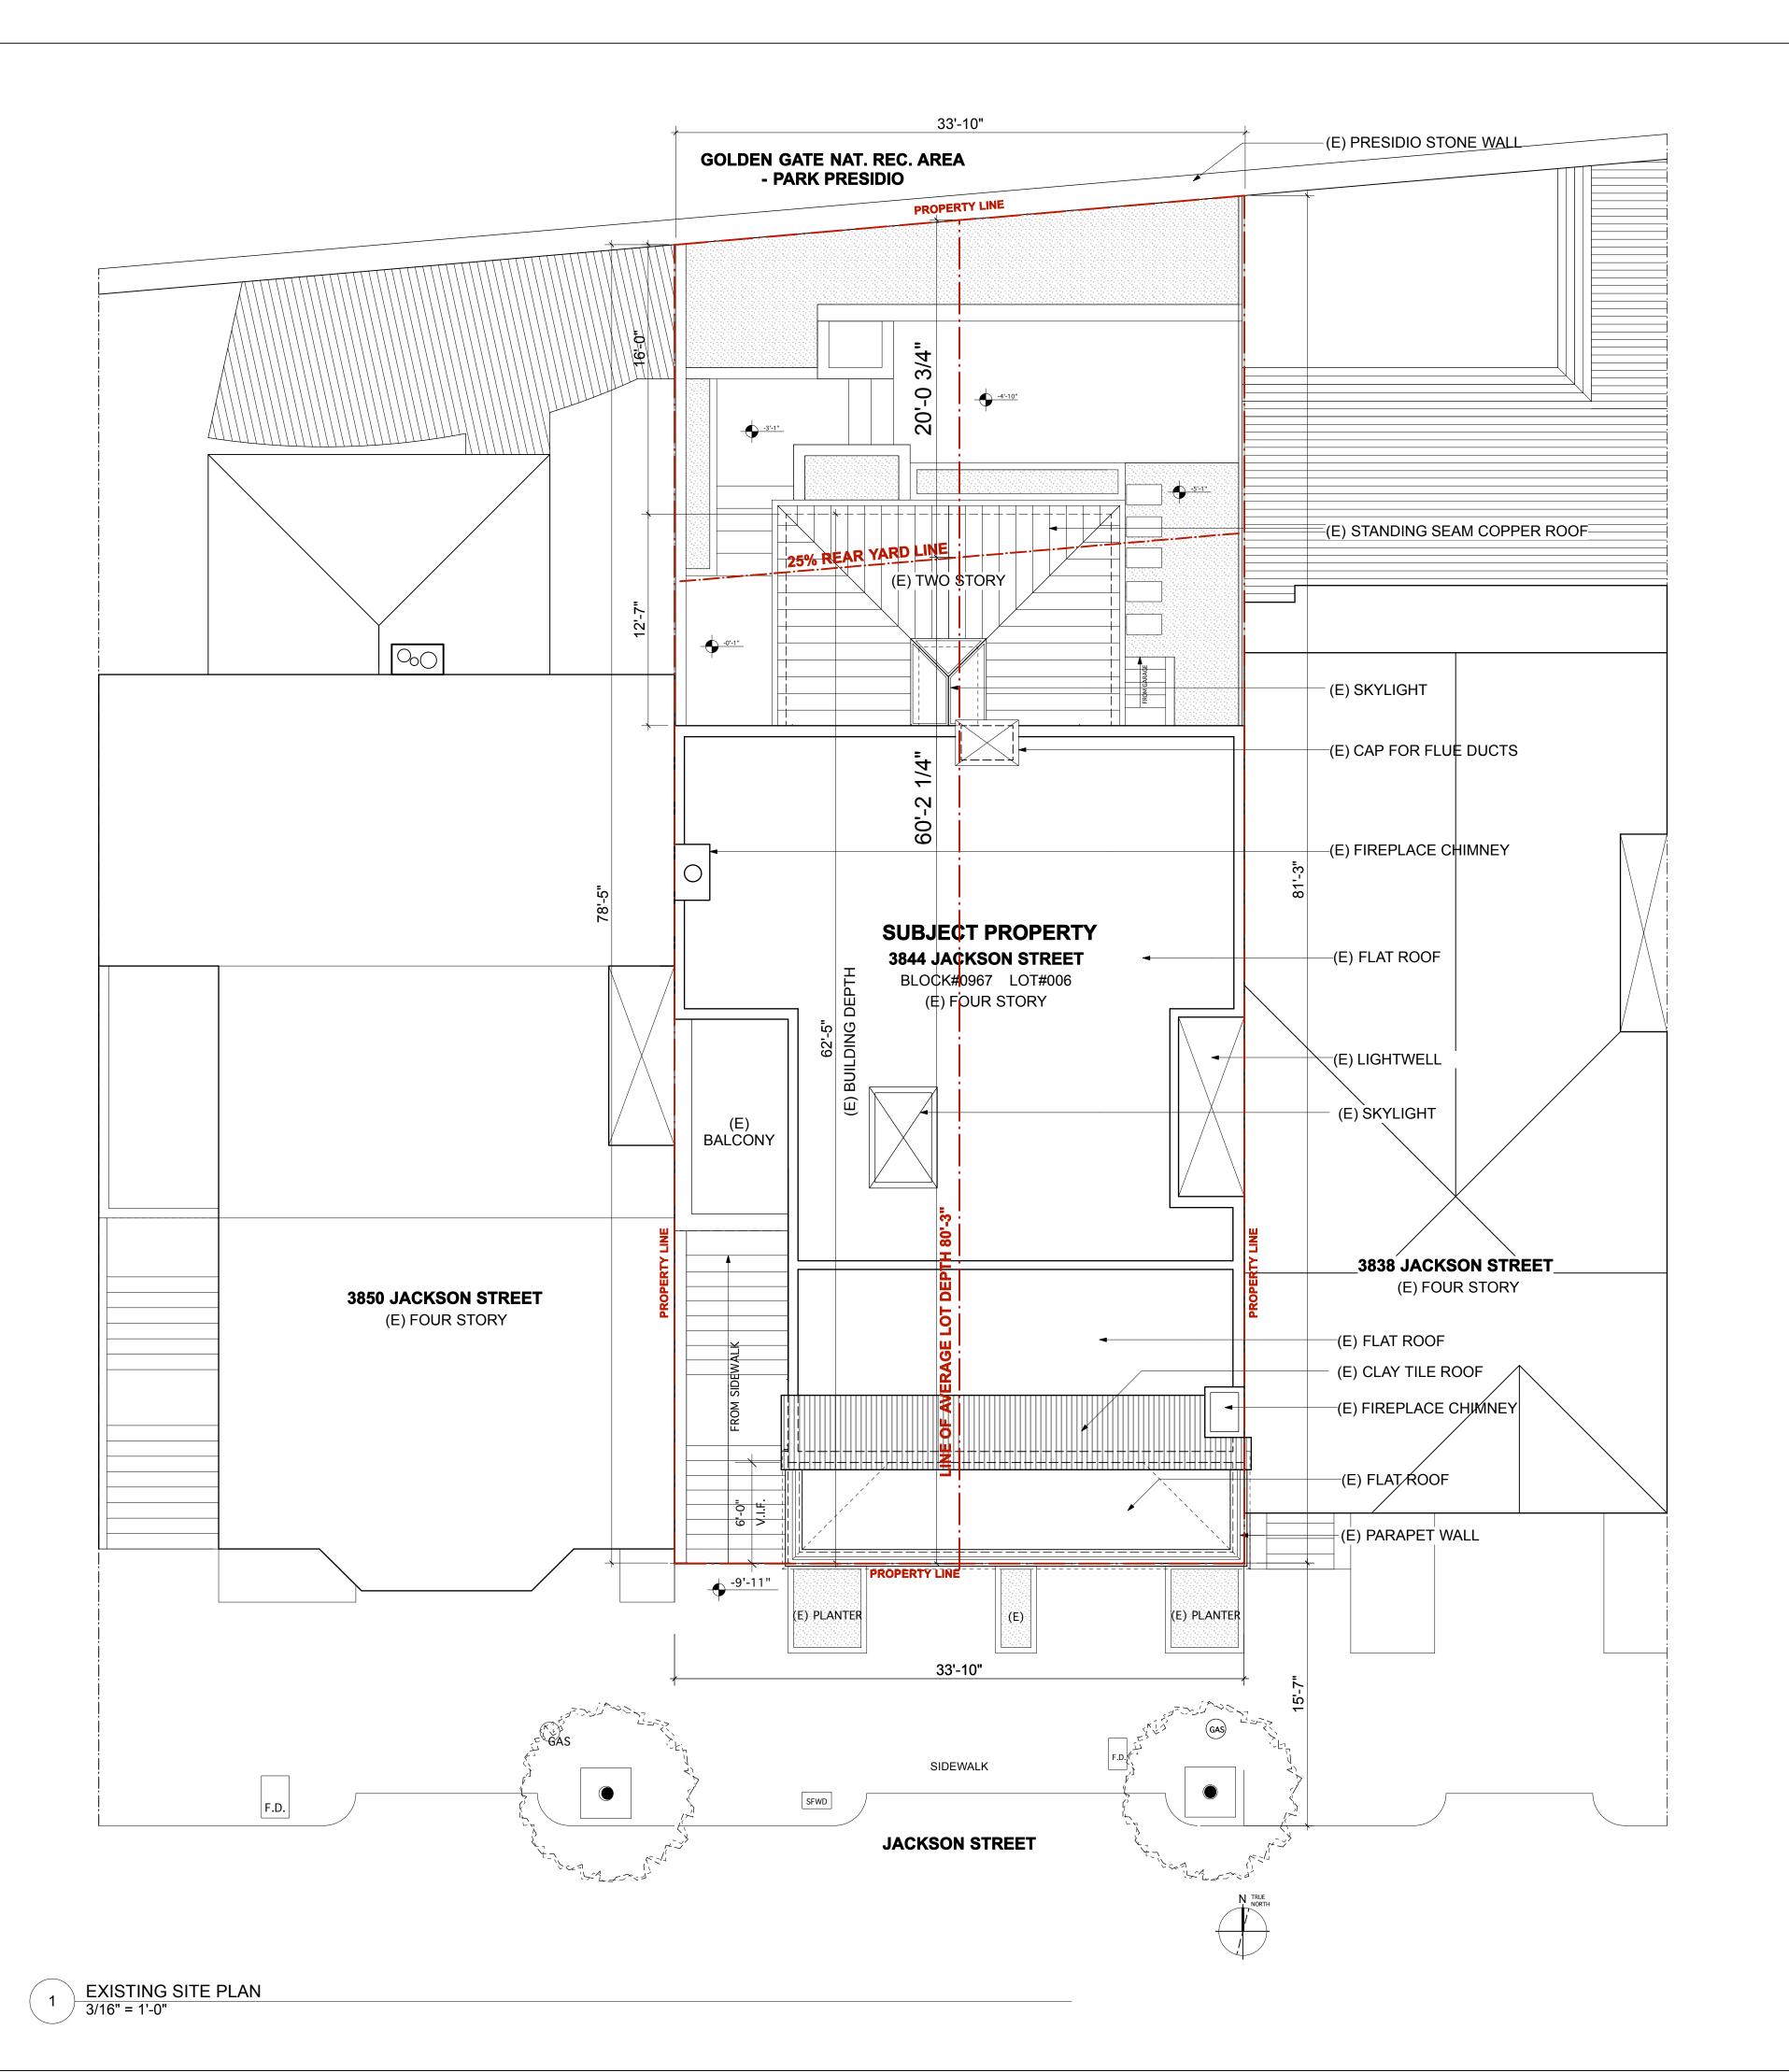

C HARLIE BARNETT A SSOCIATES

ARCHITECTURE PLANNING

626 Hampshire Street San Francisco, CA 94110 Tel 415-824-0478 Fax 415-824-0462

RECORD:

GREEN RESIDENCE

REMODEL

COVER, SITE PLAN & GENERAL NOTES

DRAWN BY: smb

ISSUED: 311/VARIANCE

DATE: MAY 7, 2013

SCALE: AS NOTED

A0.1





7 REAR YEAR OF THE NEIGHBOR TO THE WEST - LOOKING EAST




REAR YARD OF SUBJECT PROPERTY




FRONT OF SUBJECT PROPERTY - 3844 JACKSON STREET




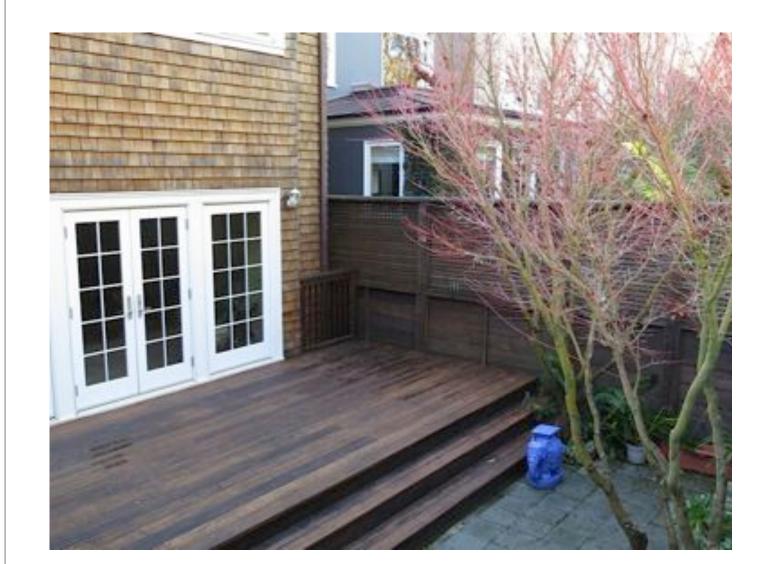

REAR YARD OF THE NEIGHBOR TO THE EAST

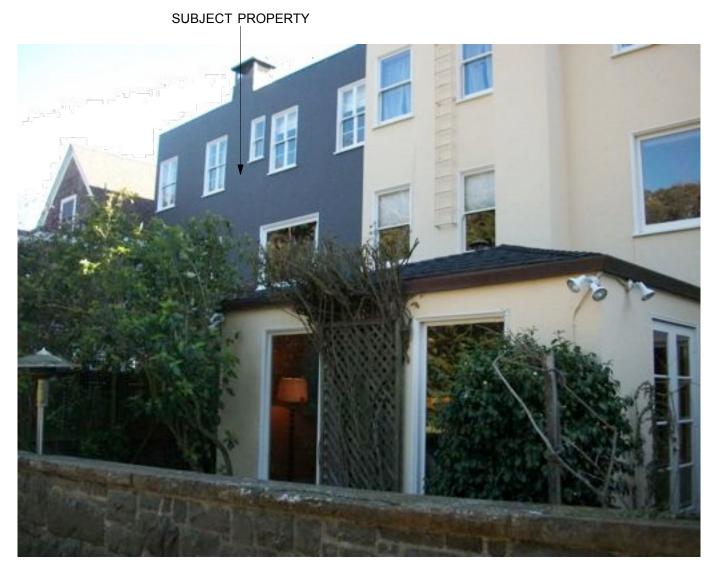


8 NEIGHBOR TO THE WEST

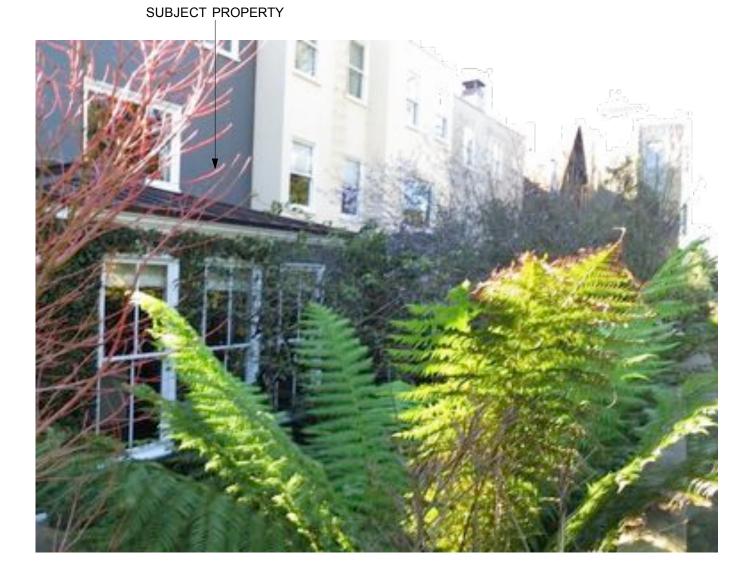

8 REAR OF SUBJECT PROPERTY - LOOKING WEST




2 ALONG PRESIDIO WALL

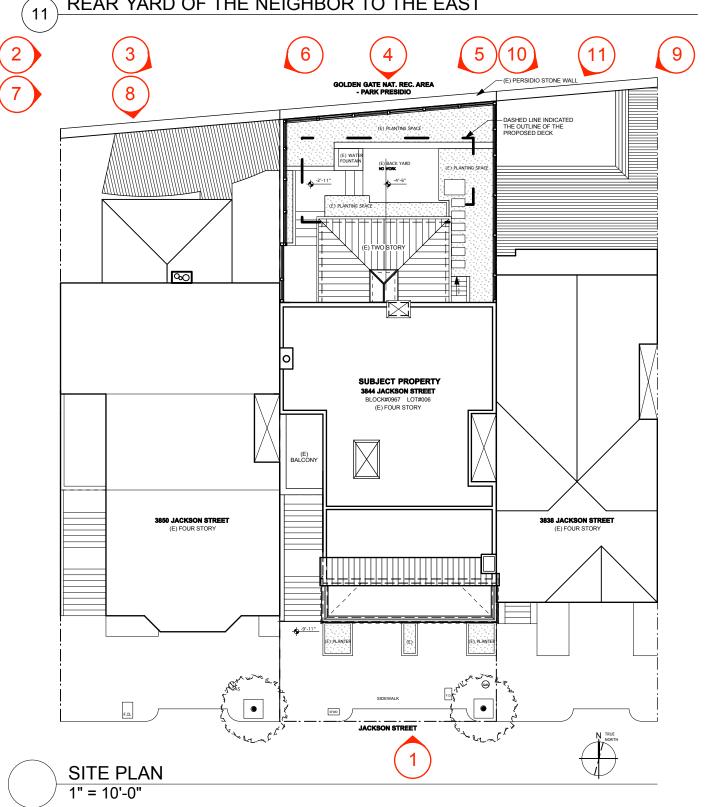

SUBJECT PROPERTY

9 NEIGHBOR TO THE EAST - LOOKING WEST

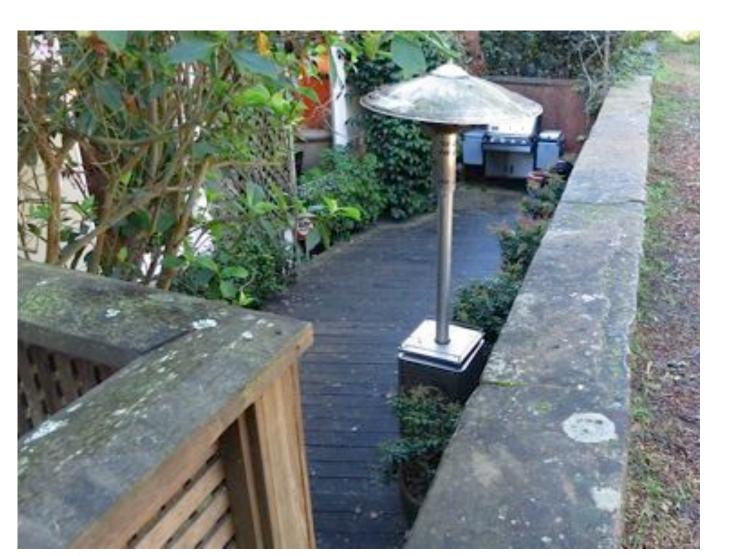

6 REAR YEAR OF THE NEIGHBOR TO THE WEST



3 REAR OF SUBJECT PROPERTY

GREEN RESIDENCE

SITE PHOTOS & KEYS				
DRAWN BY:	smb			
ISSUED:	311/VARIANCE			

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BARNETT

A SSOCIATES


ARCHITECTURE PLANNING

626 Hampshire Street San francisco, CA 94110 Tel 415-824-0478 fax 415-824-0462

RECORD:

A0.2

MARCH 18, 2013

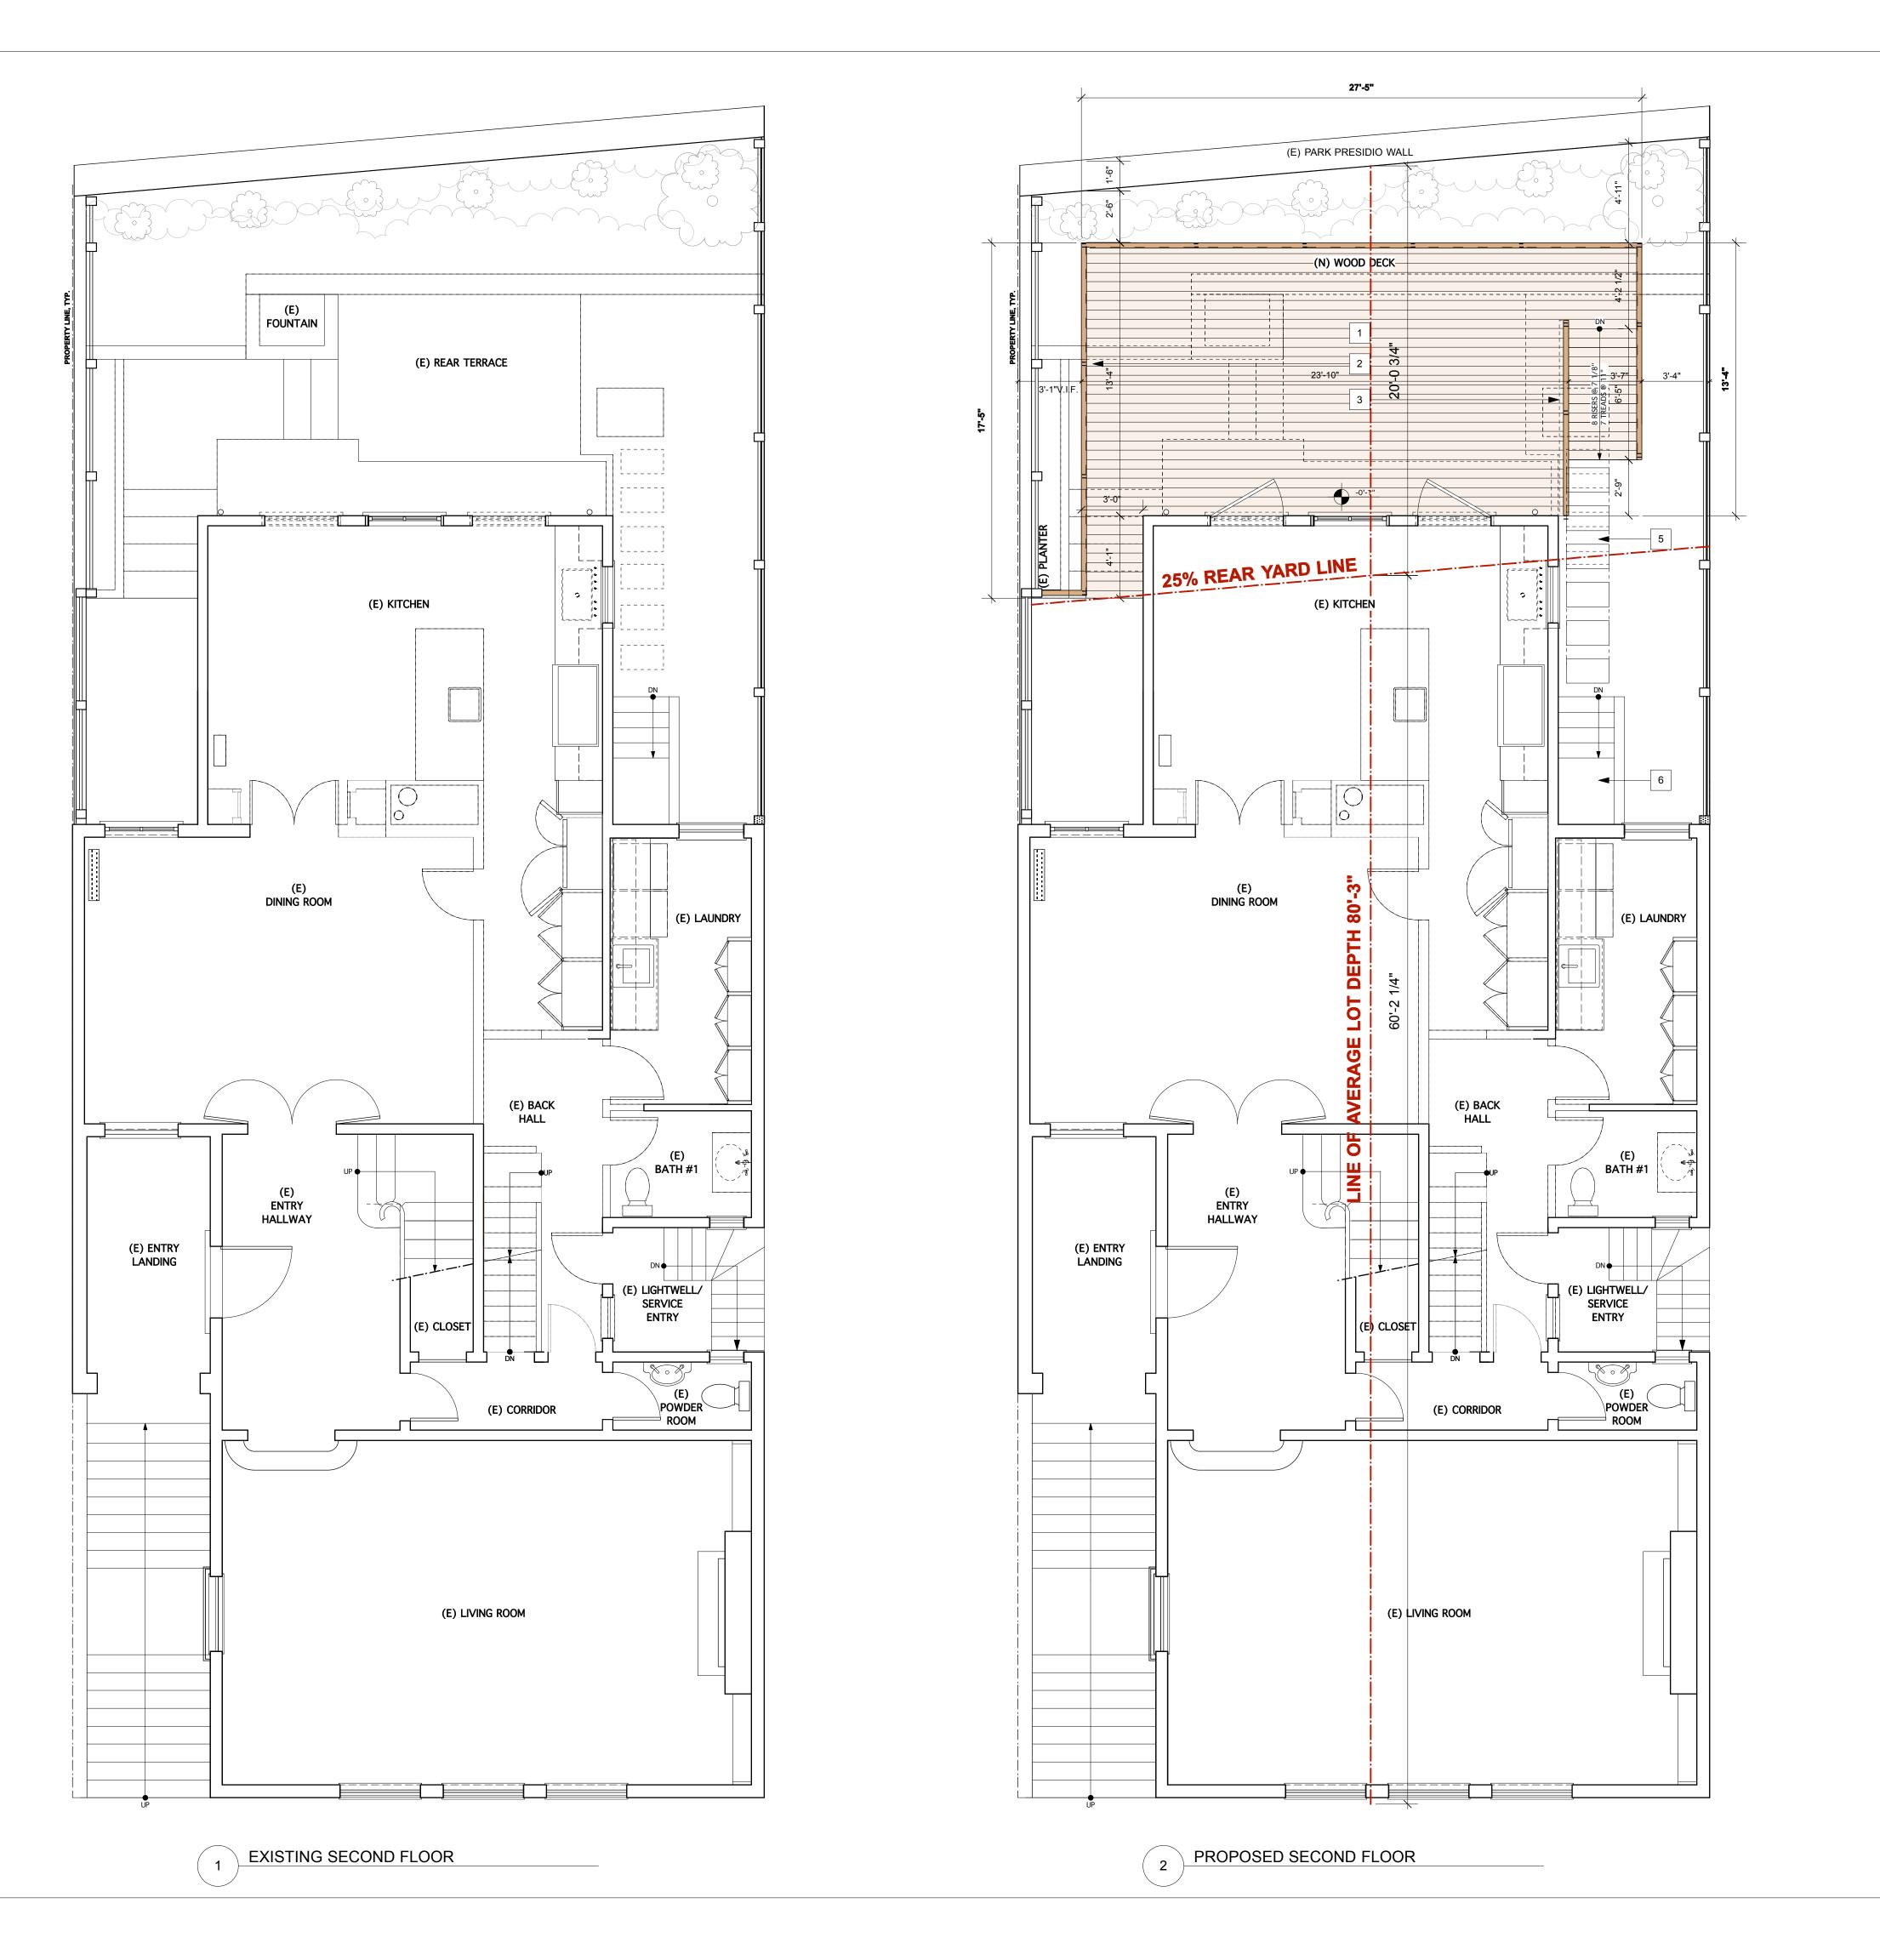

GENERAL NOTES - FLOOR PLAN

1. PROPOSED SCOPE OF WORK LIMITED TO AREA NOTED ON DRAWINGS. CONTRACTOR TO PROTECT OTHER AREAS THROUGHOUT CONSTRUCTION.

2. CONTRACTOR TO FAMILIARIZE SELF WITH CONTECTS ON THIS SHEET AND CONDUCT A PRE-DEMO MEETING WITH ARCHITECT PRIOR TO BEGINING DEMOLITION ACTIVITIES.

3. ALL (E) DIMENSIONS TO BE VERIFIED IN FIELD.

4. ALL 2X6" WALLS TO HAVE R19 INSULATION AND 2X4" TO HAVE R13 INSULATION. ROOF AND CEILINGS TO HAVE R30 INSULATION. FLOORS TO HAVE R19 INSULATION. SEE TITLE 24 REPORT FOR ADDITIONAL INFORMATION.

5. ALL BUILDING PENETRATIONS TO BE WEATHERSTRIPPED, CAULKED AND SEALED. 6. PROVIDE NON-SLIP FINISH AT ALL EXTERIOR WALKING SURFACES, PAVING AND STAIRS. **7.** EXTERIOR LANDINGS OR FLOORS AT THE REQUIRED EGRESS DOOR SHALL NOT BE MORE THAN 1-1/2" LOWER THAN THE TOP OF THRESHOLD IF SWINGS OVER LANDING, AND UP TO 7 1/4" DROP WITH RAMP IF INSWING. PER CRC 311.3.1.

8. DOOR OTHER THAN THE REQUIRED EGRESS DOOR SHALL BE PROVIDED WITH LANDING OR FLOOR NOT MORE THAN 7-3/4" BELOW THE TOP OF THE THRESHOLD, PER CRC 311.3.2.

9. THERE SHALL BE A LANDING OR FLOOR ON EACH SIDE OF EACH EXTERIOR DOOR. THE WIDTH OF EACH LANDING SHALL NOT BE LESS THAN THE DOOR SERVED. EVERY LANDING SHALL HAVE A MINIMUM DIMENSION OF 36" MEASURED IN THE DIRECTION OF TRAVEL. EXTERIOR LANDINGS SHALL BE PERMITTED TO HAVE A SLOPE NOT EXCEED 1/4" PER FT. (2%).

10. STAIR HANDRAIL AND GUARD TO BE PROVIDED IN ACCORDANCE WITH CRC 311.7. SEE A3.0 FOR MORE INFORMATION.

KEY NOTES- FLOOR PLAN

NEW IPE 1x6 DECK, OPEN STAIR AND 42" TALL GUARDRAIL, SEE THE DETAIL BELOW FOR MORE INFORMATION.

2 RELOCATE GFI TO DECK LEVEL.

3 MOVE HOSE BIB TO DECK LEVEL.

4 NOT USED

5 EXISTING STEPPING STONES TO BE REUSED IN NEW LOCATION

6 EXISTING STAIR

RAILING DETAILS

2X3" IPE HANDRAIL W/ EASED EDGES

CABLE RAIL SYSTEM FOR
RAILING BY KEUKA STUDIOS (855-454-5678) ITHACA STYLE
WITH SIDE MOUNT STEEL
PLATE WITH DOUBLE POWDER
COATED STEEL AND STAILESS
STEEL CABLE. FOLLOW
MANUFACTURE'S SPECS
FOR INSTALLATION. 1X6" IPE DECKING. INSTALL DECK WITH
"EB-TY" HIDDEN
FASTENERS BY SIMPSON


BOLT TO RIM JOIST PER MANUFACT. SPECS. BLOCKING AND— PLATE. S.E.D.

A RAILING SECTION
Scale: 1/4" = 1'-0" Scale: 1/4" = 1'-0" 2X10" BLOCKING

> -2X10" RIM JOIST -2X2 METAL POSTS WITH
>
> DOUBLE POWDER COAT FINISH
> AND STAILESS STEEL CABLE.
> FOLLOW MANUFACTURE'S SPECS
> FOR INSTALLATION. PLAN @ POST Scale: 1/4" = 1'-0"

LEGEND

(N) WALL (W/ BATT INSULATION) (E) WOOD FRAMING TO REMAIN (E) WALL TO BE REMOVED

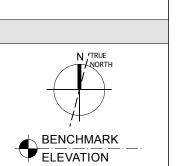

GHARLIE BARNETT () SSOCIATES

ARCHITECTURE PLANNING

626 Hampshire Street San francisco, CA 94110 Tel 415-824-0478 fax 415-824-0462


RECORD:

RESIDENCE GREEN

REAR DECK

EXISTING + PROPOSED DRAWN BY: ISSUED: 311/VARIANCE MAY 7, 2013


SCALE: 1/4" =1'0"

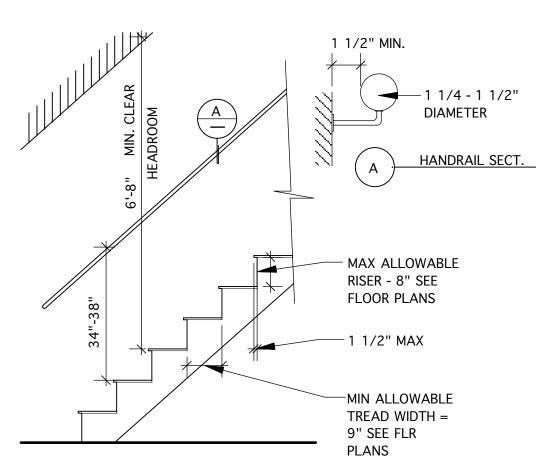


Guards: §R312, 2010 CRC

Guards shall be located along open-sided walking surfaces, including, stairs, ramps, an landings that are located more than 30 inches above the floor or grade below. The top of guardrails shall not be less than 42 inches in height. Guards whose top rail serves as a handrail, shall have a height not less than 34 inches and not more than 38 inches. The triangular openings formed by the riser, tread and bottom element of the guardrail at the open side of a stairway may be of such size that a sphere of 6 inches in diameter cannot pass through. The top rail of the guardrail must be able to withstand a load per lineal foot of 50 pounds applied horizontally at a right angle. Intermediate rails, panel fillers and their connections shall be capable of withstanding a load of 50 pounds per square foot applied horizontally at right angles over the entire tributary area, including openings and spaces between rails.

1 STANDARD STAIR REQUIREMENTS
1/4" = 1'-0"

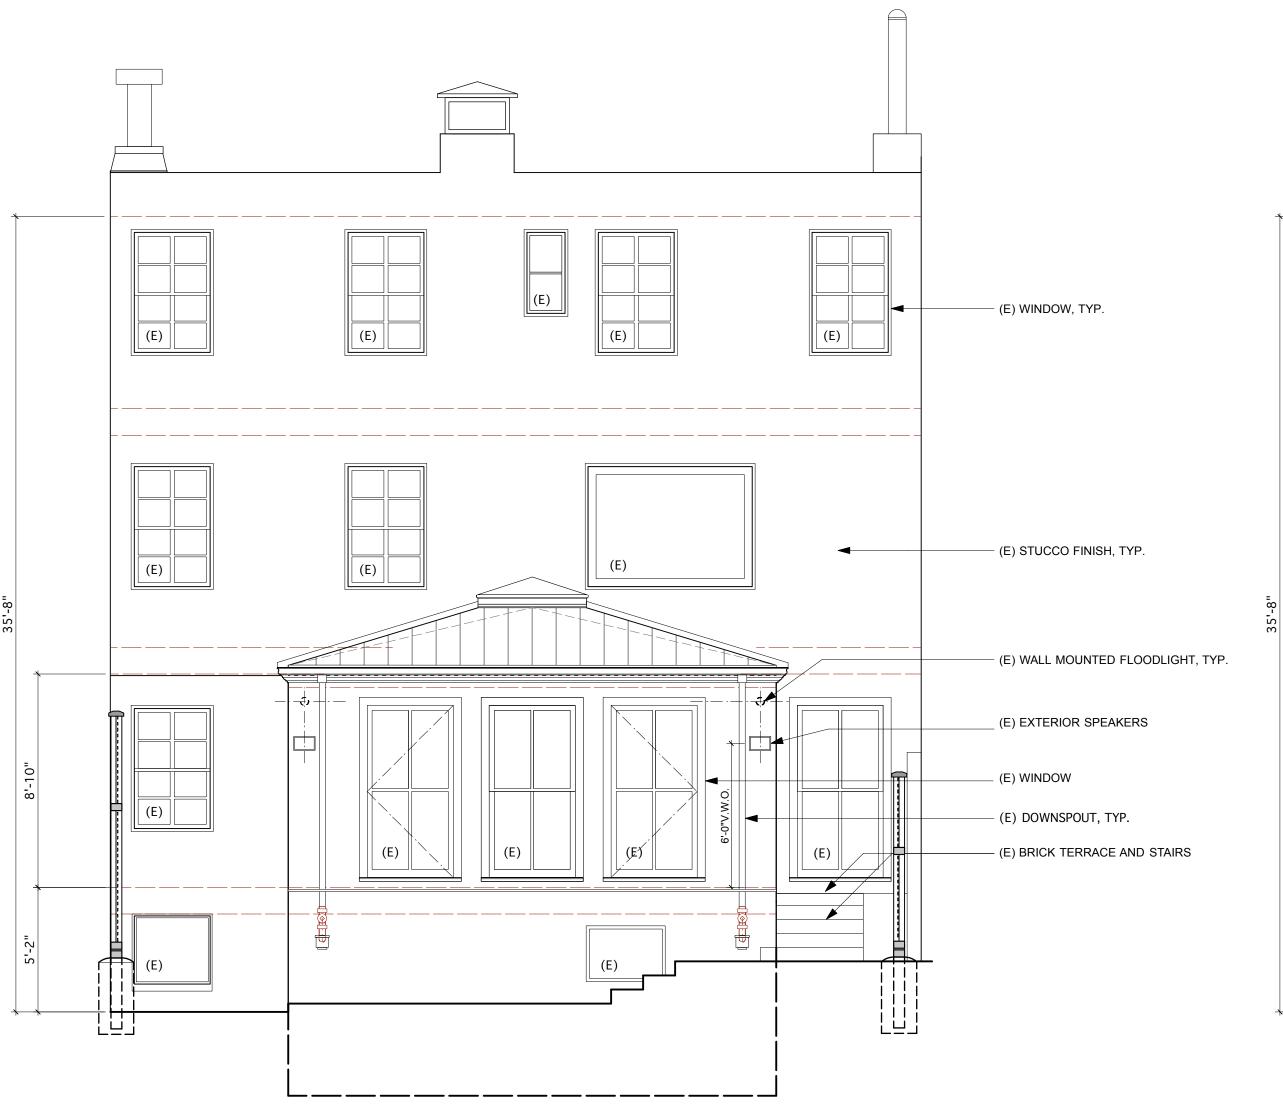

2 NORTH ELEVATION - EXISTING
1/4" = 1'-0"

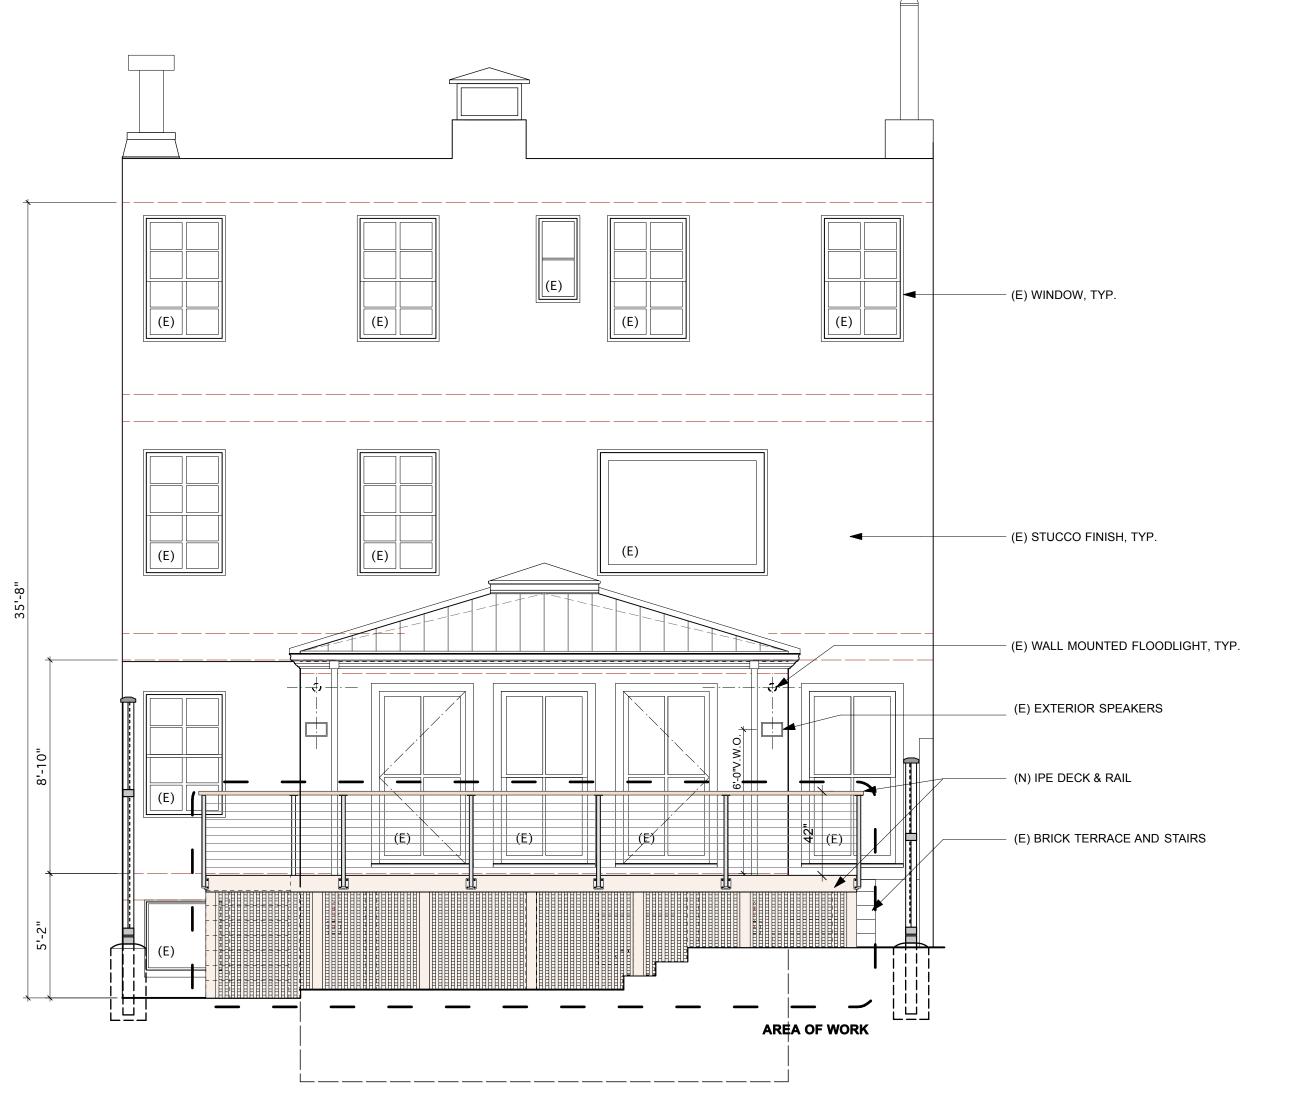

3 NORTH ELEVATION - PROPOSED
1/4" = 1'-0"

C HARLI€ BARNETT

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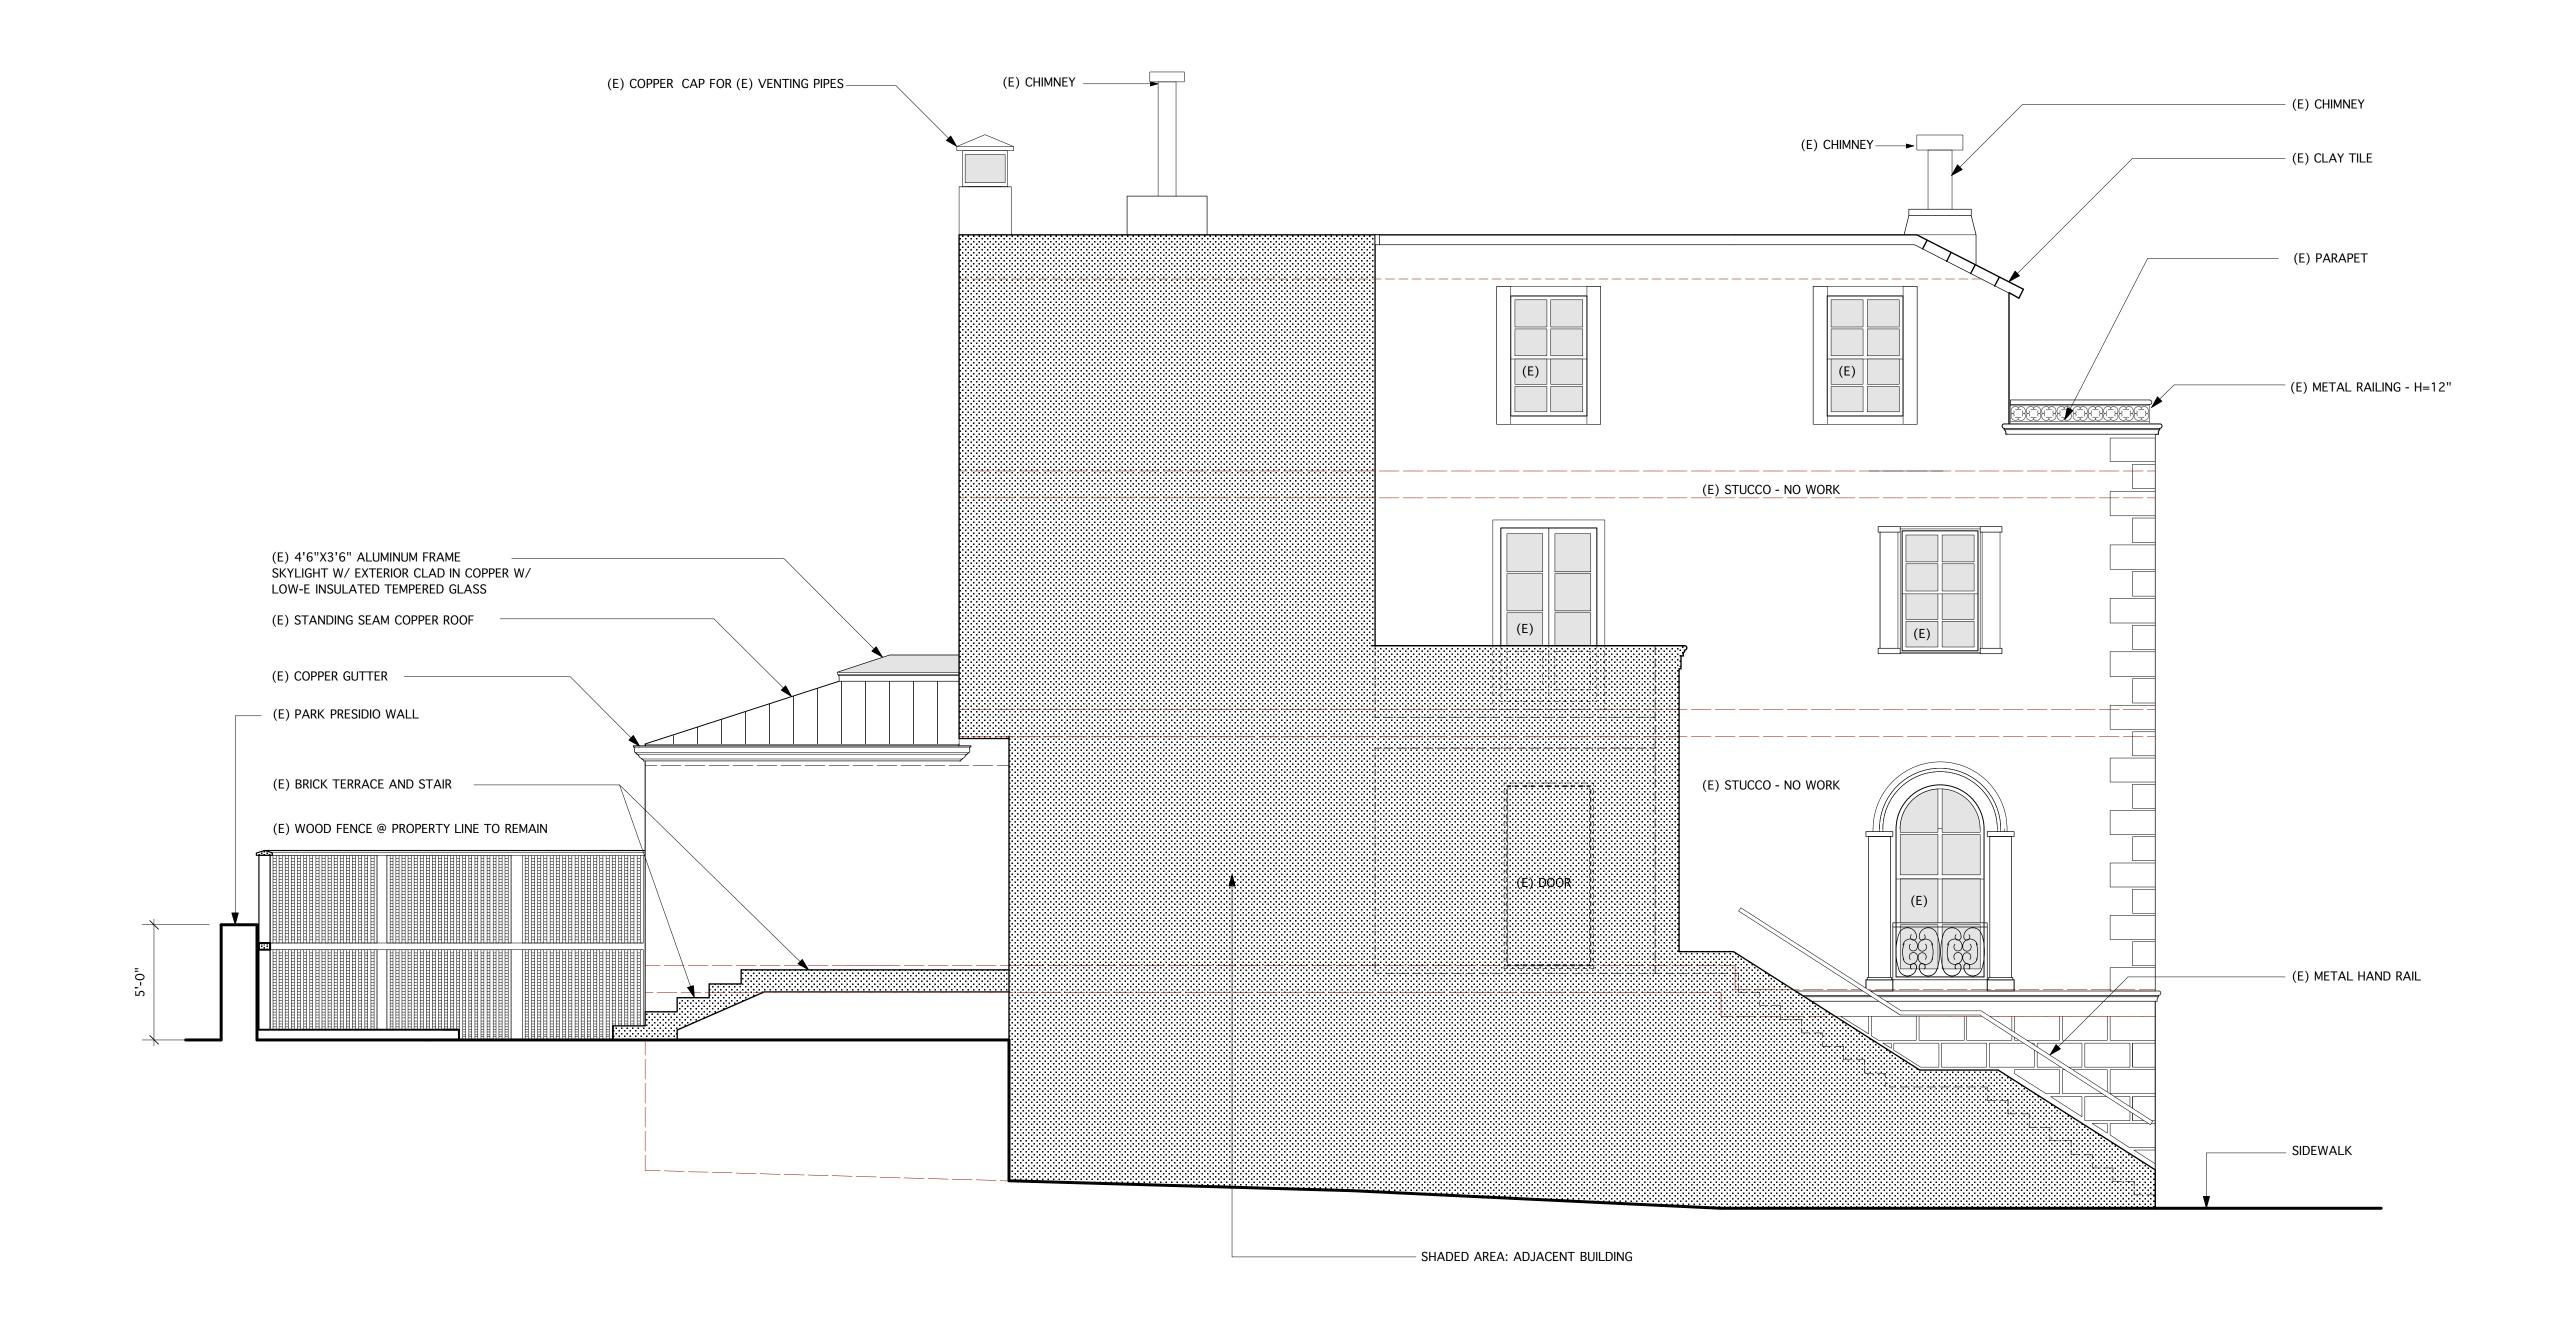
626 Hampshire Street San Francisco, CA 94110 Tel 415-824-0478 Fax 415-824-0462

RECORD:

GREEN RESIDENCE

EXTERIOR ELEVATIONS

DRAWN BY: 311/VARIANCE MAY 7, 2013



1 WEST ELEVATION - EXISTING
1/4" = 1'-0"

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RECORD:

GREEN RESIDENCE

EXTERIOR ELEVATIONS

DRAWN BY: smb

ISSUED: 311/VARIANCE

DATE: MAY 7, 2013

SCALE: NTS

A3.1


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RECORD:


GREEN RESIDENCE

EXTERIOR ELEVATIONS

DRAWN BY: ISSUED: 311/VARIANCE MAY 7, 2013

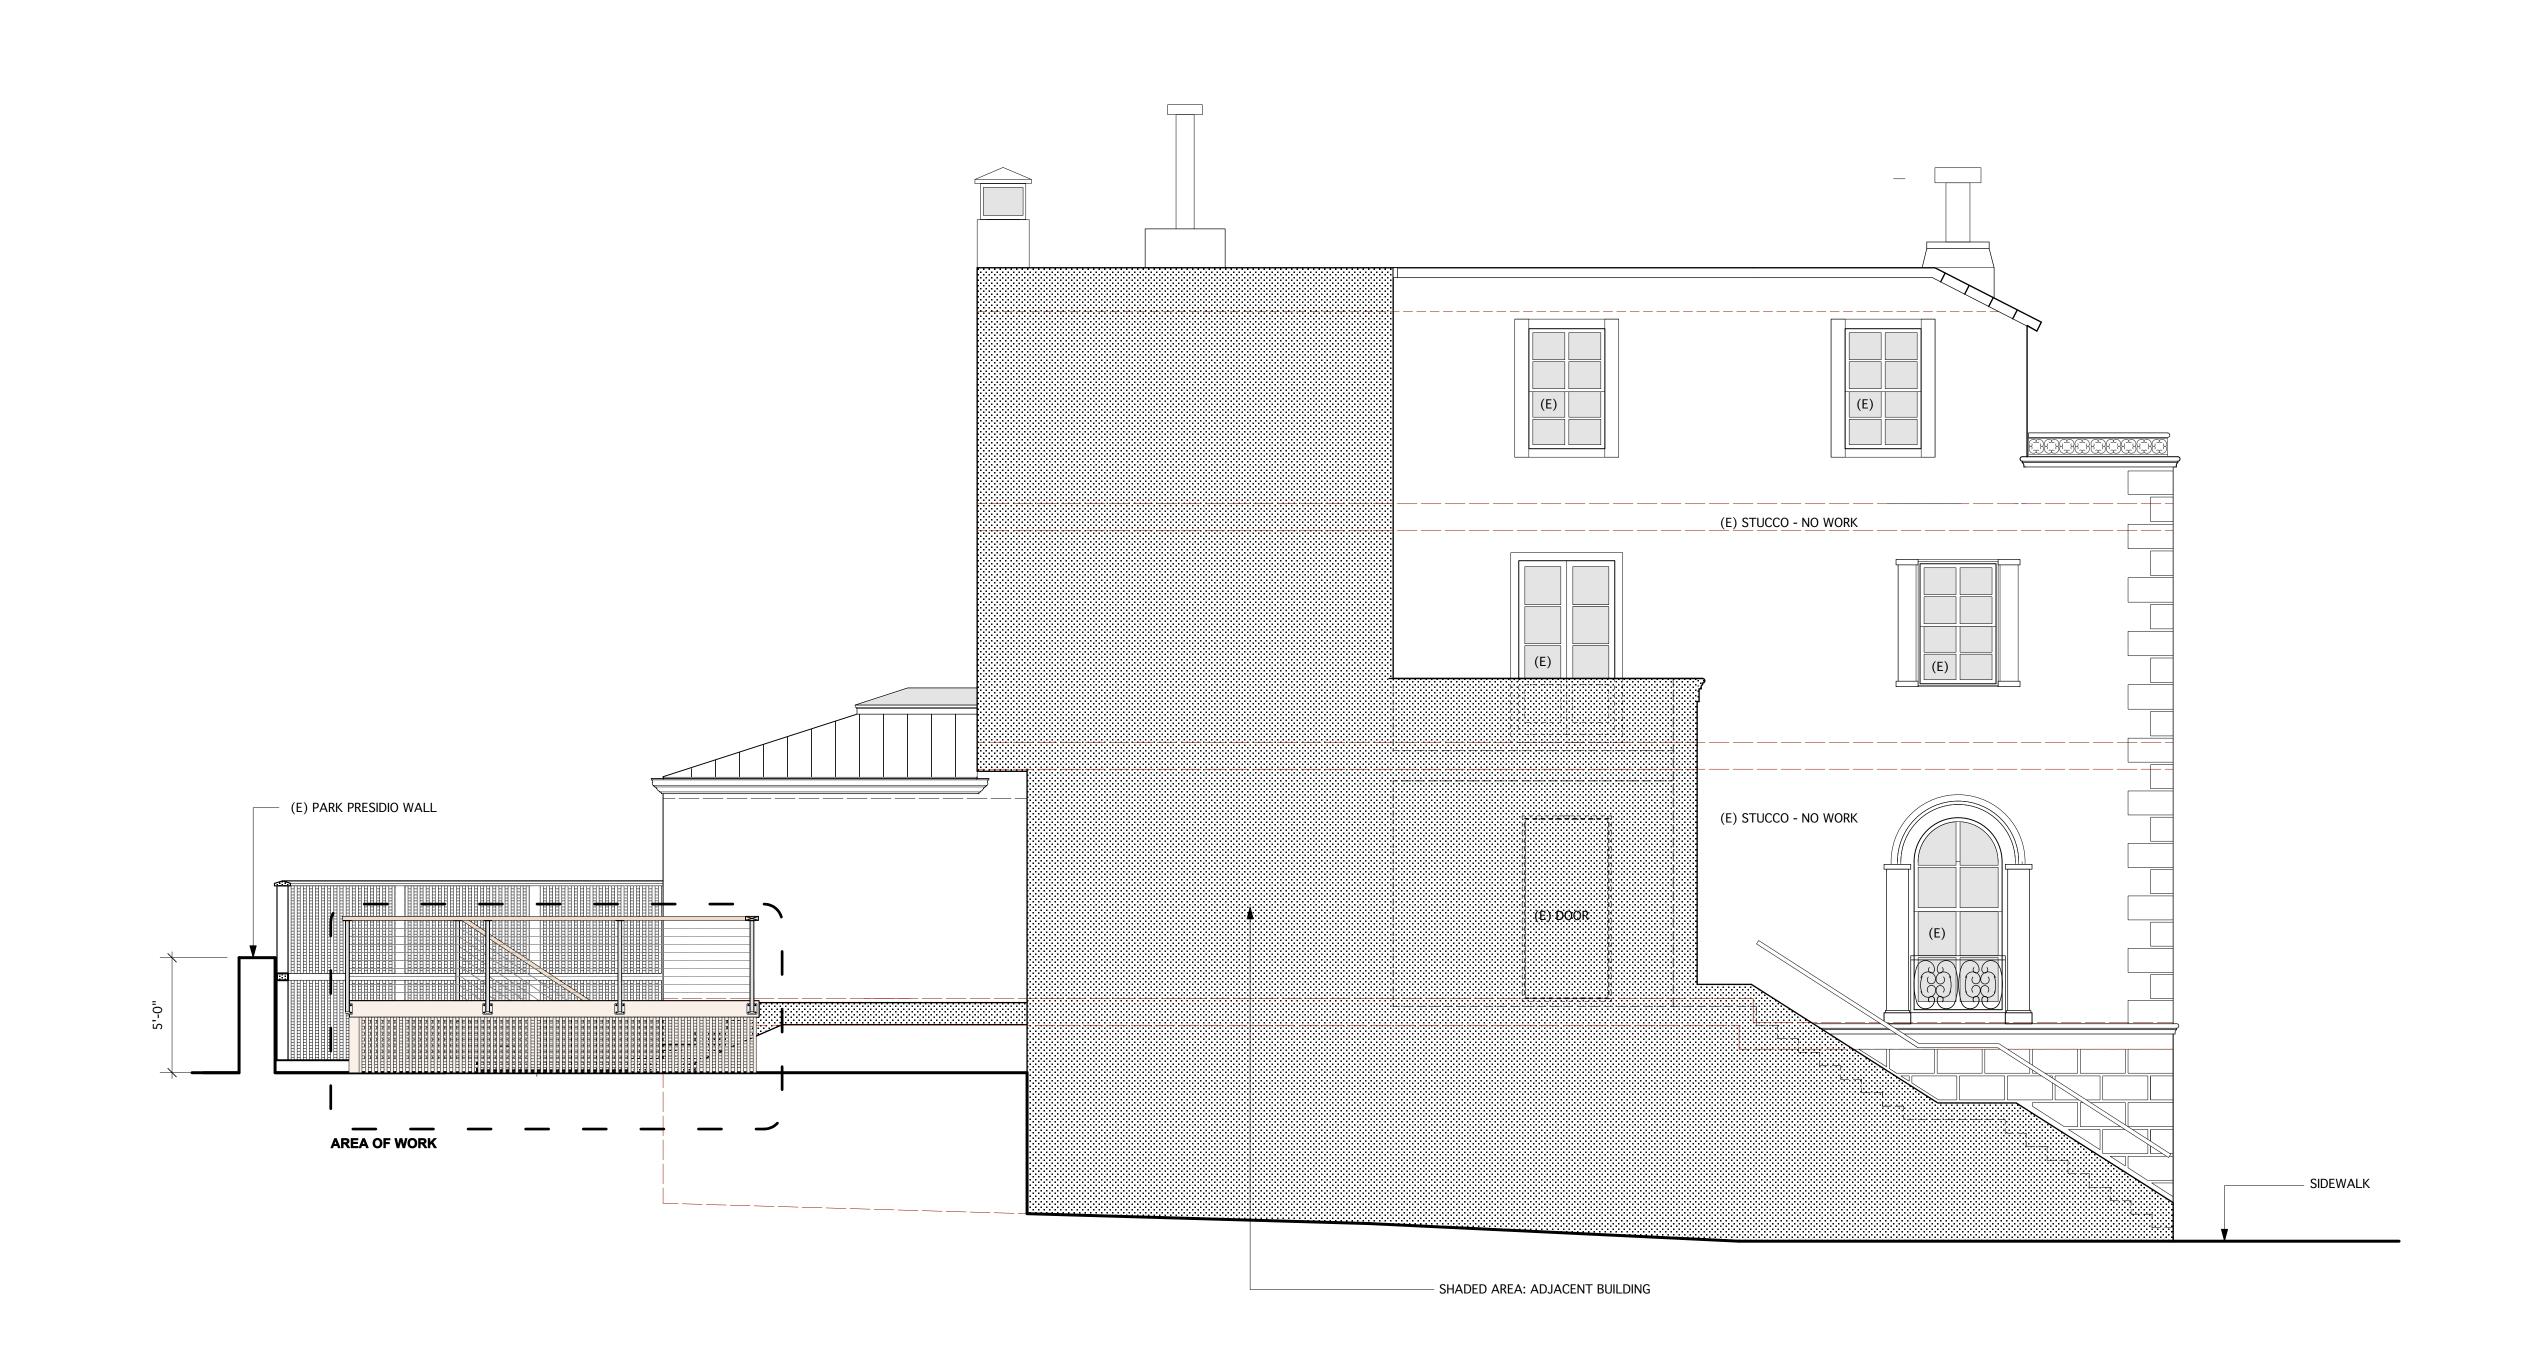

WEST ELEVATION - PROPOSED
1/4" = 1'-0"

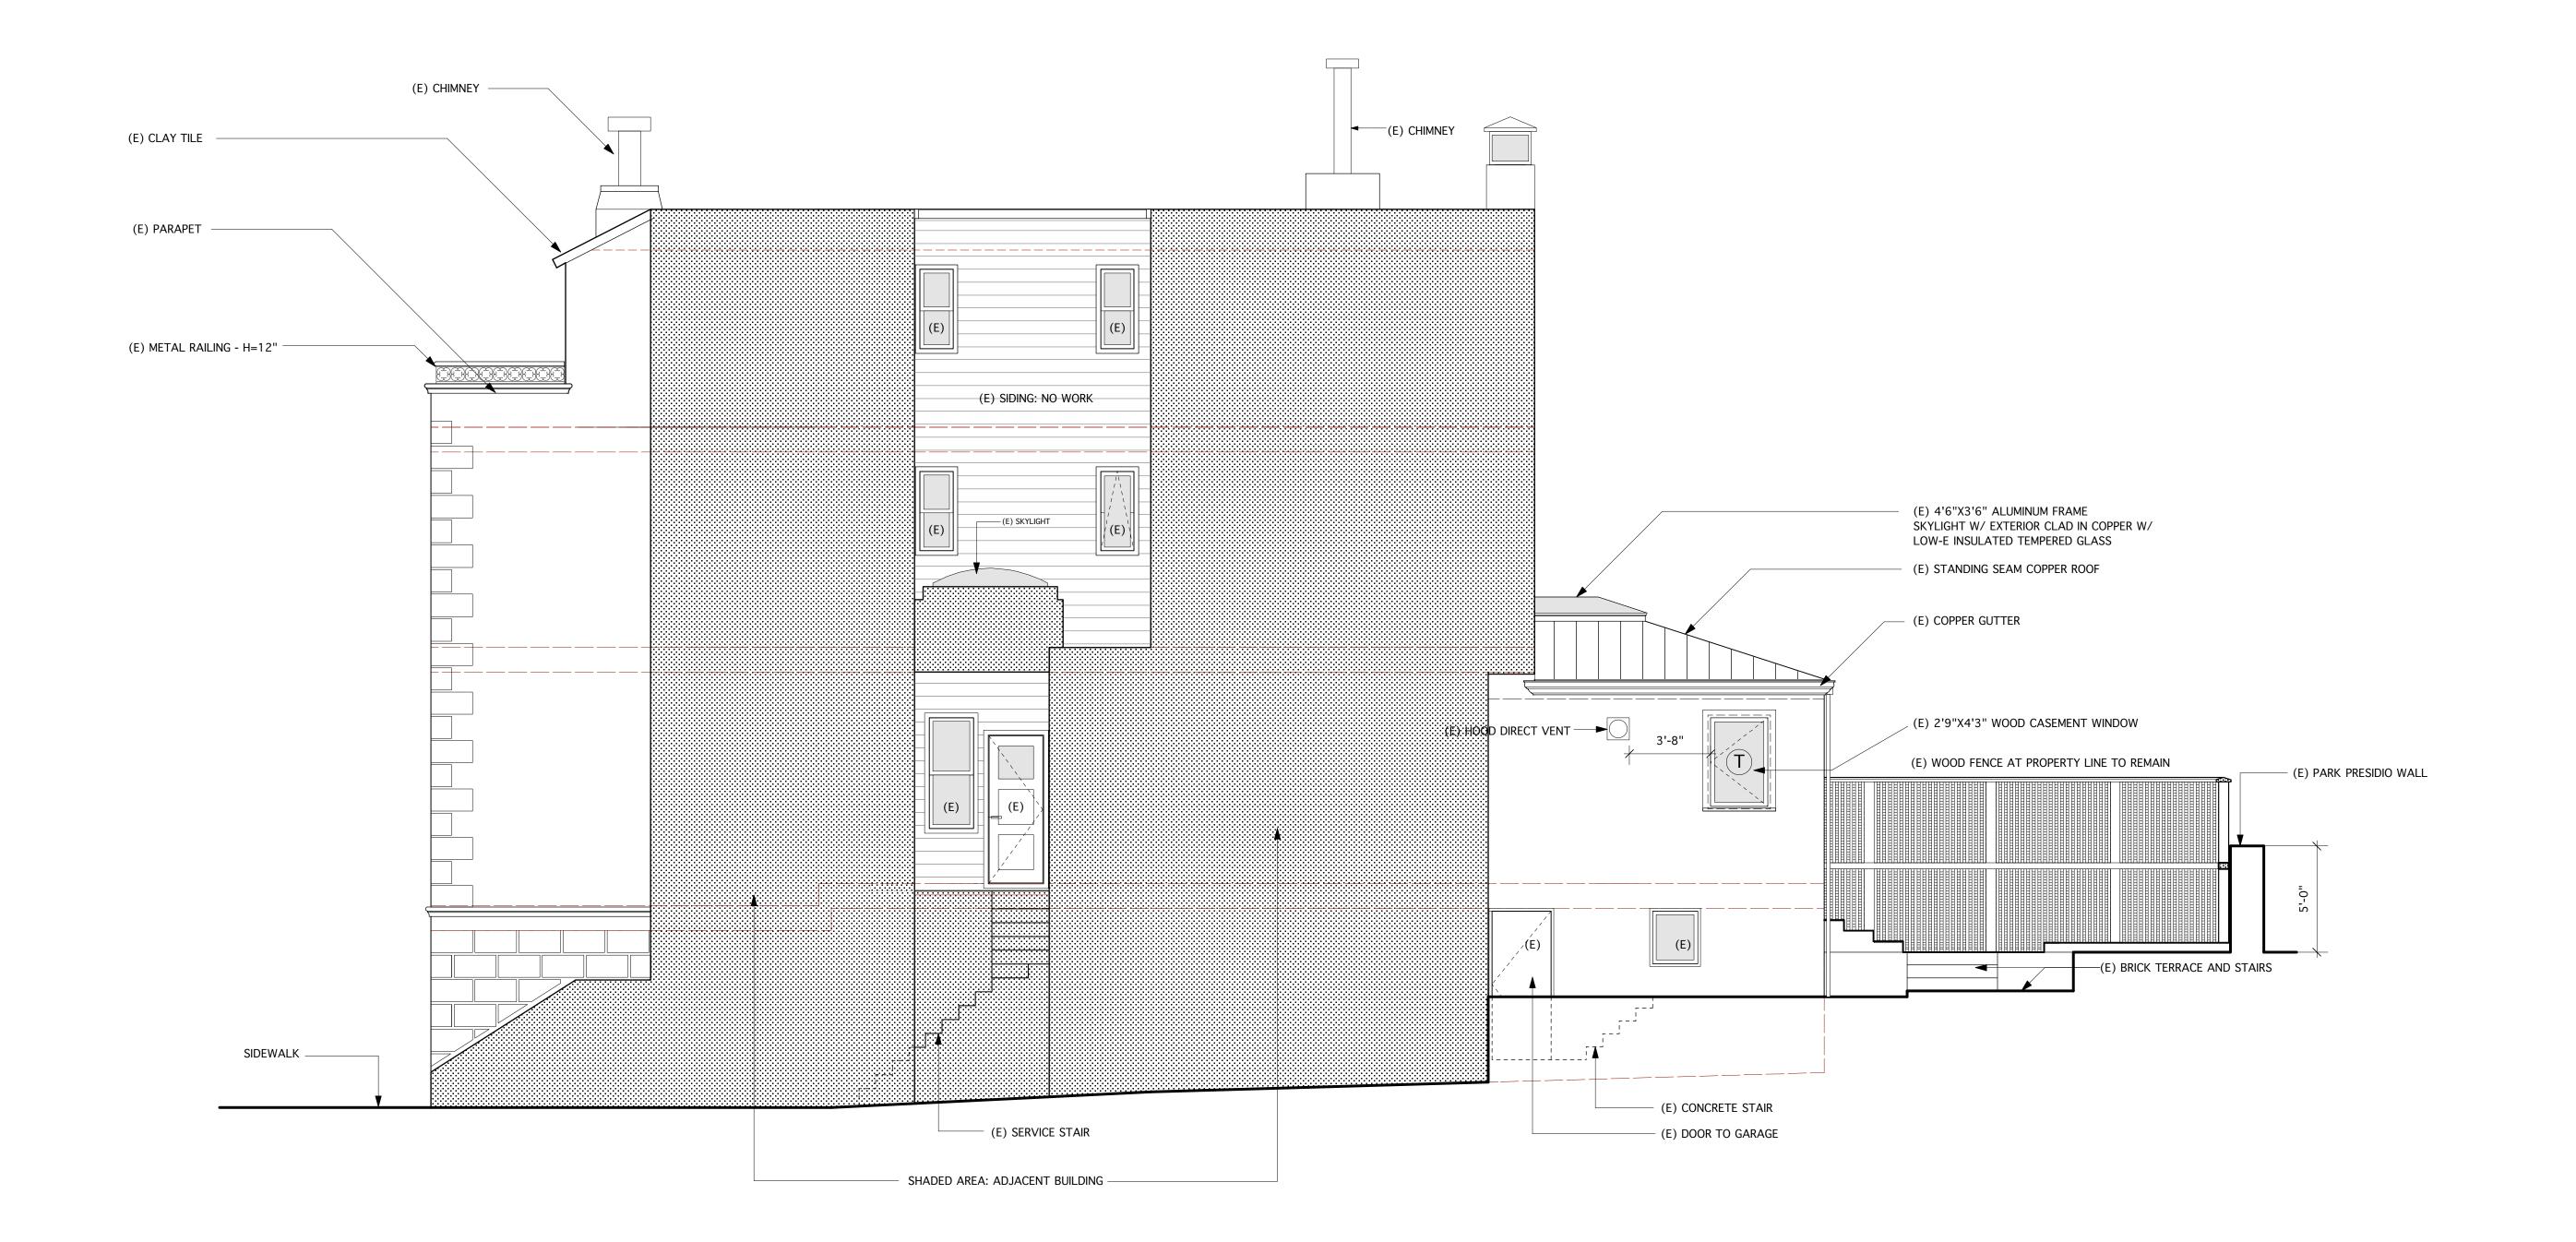

3 EAST ELEVATION - EXISTING
1/4" = 1'-0"

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626 Hampshire Street San francisco, CA 94110 Tel 415-824-0478 Fax 415-824-0462

RECORD:

GREEN RESIDENCE

GREEN RES

EXTERIOR ELEVATIONS

DRAWN BY: smb

ISSUED: 311/VARIANCE

DATE: MAY 7, 2013

SCALE: AS NOTED

A3.3

2 EAST ELEVATION - PROPOSED
1/4" = 1'-0"

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RECORD:

GREEN RESIDENCE

SKEEN I

EXTERIOR ELEVATIONS

DRAWN BY: smb

ISSUED: 311/VARIANCE

DATE: MAY 7, 2013

SCALE: AS NOTED

A3.4