


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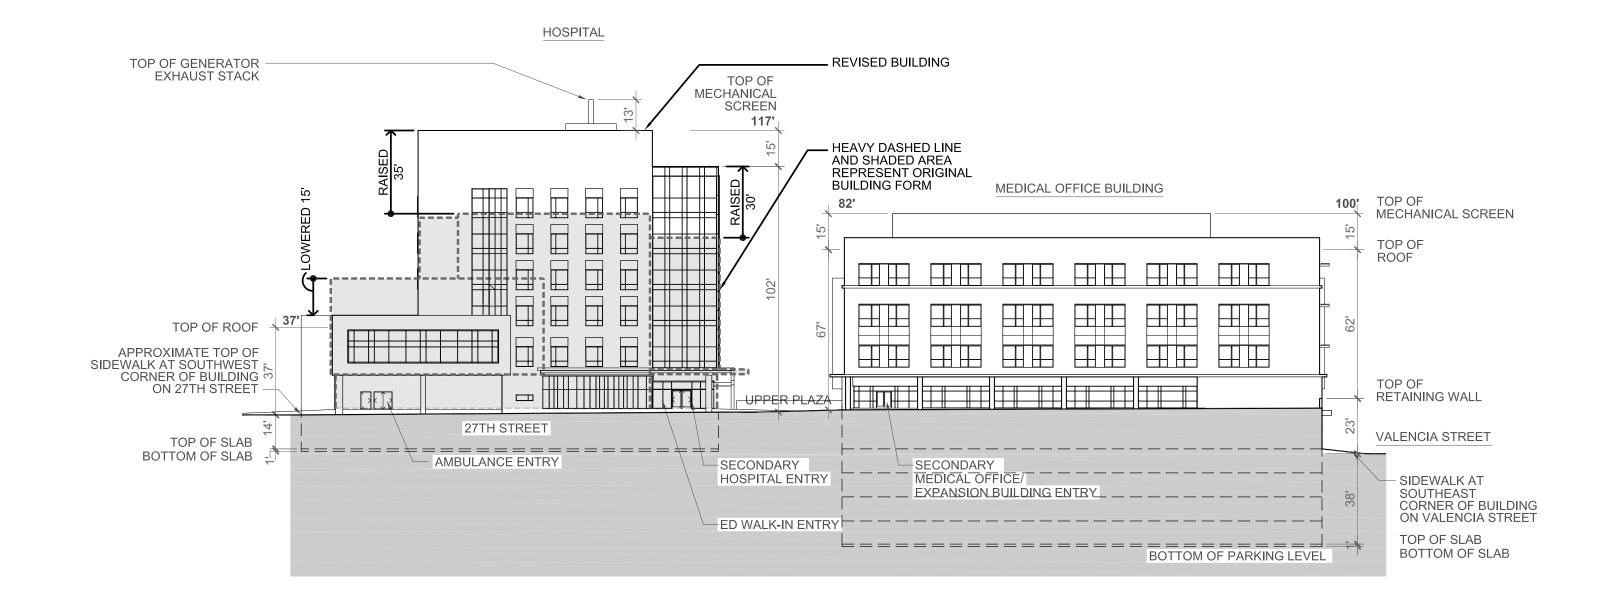
BUILDING HEIGHTS SHOWN ARE APPROXIMATE
 BUILDING HEIGHTS MEASURED FROM TOP OF SIDEWALK AT LOCATIONS INDICATED

APPROXIMATE SCALE 0 5' 10' 20' 40'

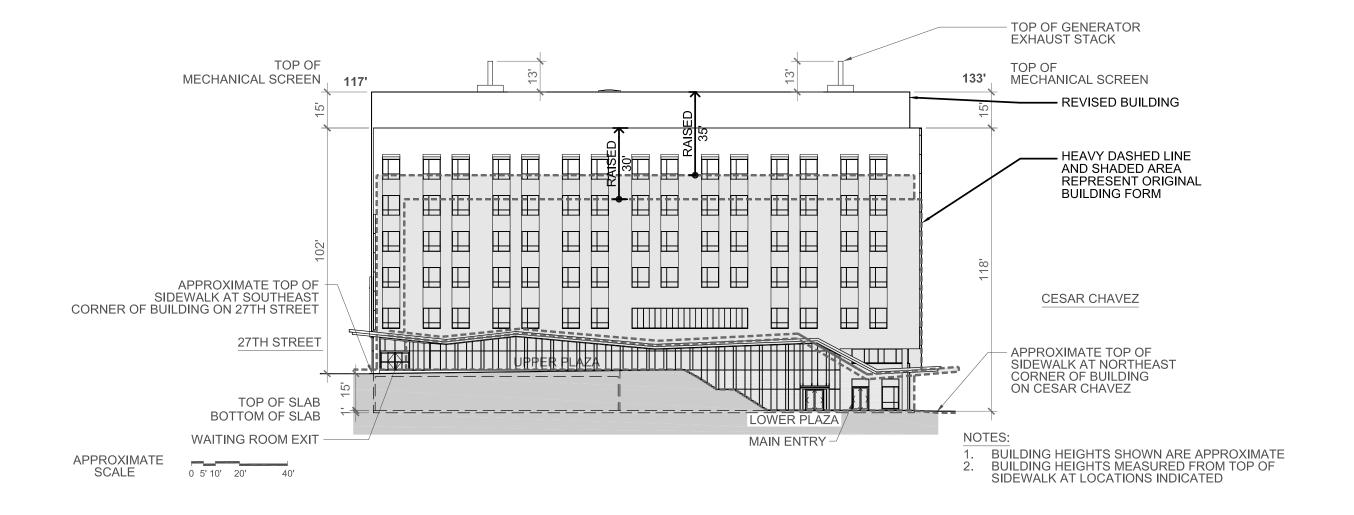








NOTES:

- BUILDING HEIGHTS SHOWN ARE APPROXIMATE BUILDING HEIGHTS MEASURED FROM TOP OF SIDEWALK AT LOCATIONS INDICATED





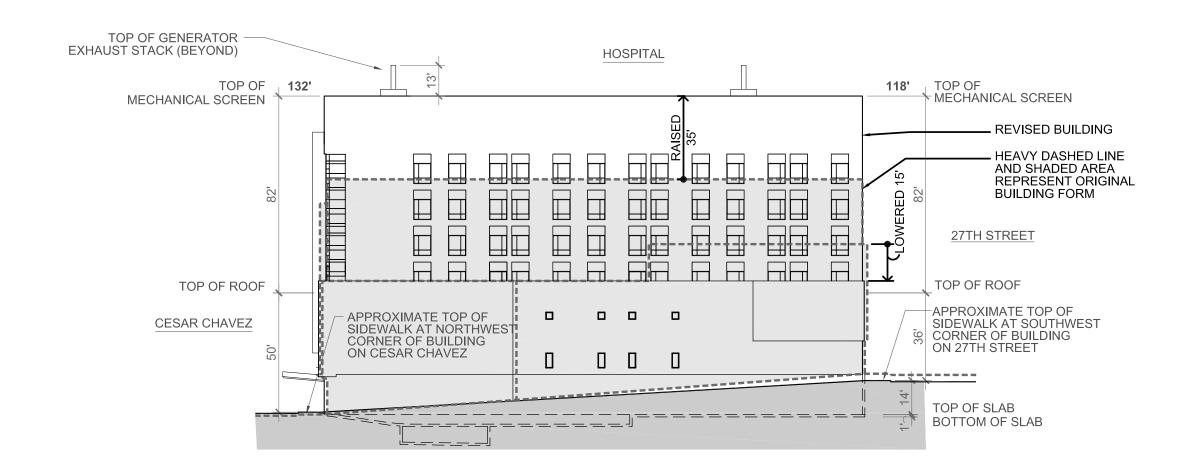



California Pacific Medical Center St Luke's Hospital

Conditional Use Permit Application Update 2

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HOSPITAL SECTION

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LANDSCAPE LAYOUT AND PLANTING PLAN

LANDSCAPE DETAILS

PROJECT DESCRIPTION

Construction of the St. Luke's Replacement Hospital, a 214,061 sq. ft. seven-story hospital, providing approximately 120 acute care beds. The St. Luke's Replacement Hospital may include, but is not limited to, surgical care, critical care, labor and delivery, post-partur care, an emergency epartment, cafeteria, loading area, and central utility plant space.

Primary pedestrian entrance and passenger drop-off is at Level 1, building entrance on Cesar Chavez. The hospital's secondary access and the emergency department drop-off is on Level 2 from San Jose Ave. The loading area entry is on Cesar Chavez.

TREE PROTECTION PLAN

All existing trees to remain are to be protected per the Tree Survey and Protection Plan prepared by Consulting Arborist, Roy C Leggitt with Tree Management Experts, dated October 28, 2011. Recommendations include but are not limited to the following:

Pre-Construction Requirements:

Nesting Survey Requirement: The Federal Migratory Bird Treaty Act of 1g1a prohibits the laking or destroying of any bird, part, nest or eggs. To comply with this law, tree pruning and removal activities should not occur during bird nesting season. As noted in the Presidio of San Francisco Vegetation Management Plan of 2001, most bird species breed and nest between February and August 15. A qualified biologist must evaluate the site prior to tree work during this timeframe to determine the presence of active or inactive nests, and give recommendations.

Clearance Pruning: It is preferable to remove branches using clean cuts rather than to break them with equipment. The survey indicates which trees should be pruned to a street clearance height of 14 feet. Where minimal pruning is indicated, prune as little as possible, tying branches out of the way as an alternative to making excess cuts. Until branches when work is complete in that immediate area.

A qualified ISA-Certified Ariborist must carry out all pruning in accordance with ANSI A300 Pruning Standards and must comply with City of San Francisco Pruning Standards, available from the San Francisco Department of the Environment at http://www.sfenvironment.org/our_programs/ Complete clearance pruning before any construction activities beneath the tree commence. Monterey Pines (Pinus radiata) should be pruned only from November through February when bark beetles are least active.

Tree Removals: Remove all trees recommended and approved for removal before construction begins. If trees cannot be removed before the start of the project, they must be protected and alternate means of construction will be required. Working around trees without taking the protection measures indicated in this report may create hazard trees and decrease the safety of this project. Monterey Pines (Pinus radiata) should be removed during November through February and the stumps ground out to minimize bark beetle activity that will harm trees of the same species that remain.

Establishment of Tree Protection Zones (TPZs): Establishing and fencing off the TPZ is vital to tree preservation. Protecting the TPZ prevents damage to roots, branches and trunk, and protects soil from compaction. The optimal TPZ is a round area with a radius equivalent to 10 or 12 times the trunk diameter, depending on the tree species, root confinement and soil type. A TPZ of this size is best to preserve both health and structure of the tree.

Install TPZ fencing in a particular area before work commences. Work within the TPZ is possible, but must be done differently than work outside the TPZ. Do not operate equipment, store materials or park vehicles within the TPZ. Have the Project Arborist on site for any work within the TPZ. Remove TPZ fencing only for the necessary work and replace it immediately thereafter. Keep TPZ fencing up until construction activities in that area are complete. Because the project is multi-phased, TPZ fencing may be removed when one phase is complete and re-installed at a later date. The exact timeline for installing and removing TPZ fencing for each tree must be established as part of the timing for construction.

To enclose trees in the landscape, use 6-foot high chain link fencing, supported by 1-1/2 or 2-inch iron pipe, spaced no more than 10 feet apart. Drive the fence posts atleast 24 inches into the ground. On the St. Luke's campus, it is not possible to fence off the optimal TPZ for each tree. Follow the recommendations for TPZ fencing in the section titled "Tree Protection by

To protect street trees, the existing pavement forms an effective root buffer, so TPZ fencing is not necessary. Instead, wrap the trunk to prevent injury and cover the tree wells with plywood covers to prevent soil compaction and toxic runoff from getting into the soil. For the trunk protection, wrap the trunk a minimum of 3 times with orange plastic snow fencing. Place 2 x 4 planks edge-to-edge with the wide side against the trunk so that the trunk is covered. Wrap the planks a minimum of 3 times with the snow fencing and secure. Cover the tree wells with 3/4-inch plywood. Covers should form a square or rectangle that is a few inches larger than the tree well on all 4 sides, with a circle cut out of the middle for the trunk. The open area for the trunk should be a minimum 1 inch away from the trunk, and a maximum of 3 inches. Attach the plywood to the sidewalk so that it cannot be removed or casually moved.

Preservation Requirements during Construction

Project Arborist Requirement: Successful tree preservation depends on Project Arborist involvement throughout the project, including the landscaping phase. Trees are living things, and they react to the changes around them. The Project Ariborist provides the following vital services:

• To be on site whenever there is work within the TPZ radius of a protected tree or TPZ fencing. We will advise contractors or subcontractors to minimize impacts to

trees, and will either perform or supervise root pruning. • Review plan changes or additional plans not included in this report for additional recommendations.

 Provide monthly inspections of protected trees, especially the Landmark Tree, and to monitor for any changes and make additional recommendations for preservation. • Inspect protected trees at 6 months and 12 months after the project is completed

Air/Water Excavation: The TME Ariborist Report of May 17, 2010, excerpted in Section 4, Appendix D, compares the various excavation options in more detail. To summarize:

and make recommendations for their ongoing care.

Excavating trenches with equipment destroys roots. Hand excavation is slow and can also damage roots. Directional boring can damage unseen roots. Excavating the trench using air or water tools preserves roots, moves soil quickly, and allows the ariborist to see the roots and make the best decision. Use air or water excavation for utility work on Duncan Street, around the Landmark Tree on Valencia, on San Jose Avenue, and north of Cesar Chavez.

Selective Root Pruning: Once roots are exposed using air or water excavation, the Project Ariborist will inspect roots and determine which roots should remain and bridge the trench and which can be removed. Root pruning must be done cleanly with a sharp tool, under the direction of or by the Project Arborist.

Existing Pavement as a Root Buffer: The existing paved areas are protecting roots from damage and soil compaction. When existing pavement is removed, the exposed area within the TPZ radius should be fenced off and protected as described in this report. Staging: Stage materials on paved areas and outside of TPZ fencing. Irrigation: Protected trees should be maintained on their normal irrigation schedule throughout the project. Certain trees that sustain root losses may benefit from increased inrigation, as recommended by the Project Ariborist.



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CU APPLICATION

05/27/2011

02/22/2012

05/06/2013


CU APPLICATION UPDATE

CU APPLICATION UPDATE 2

COVER SHEET & SHEET INDEX

PROJECT NUMBER

DRAWING NUMBER

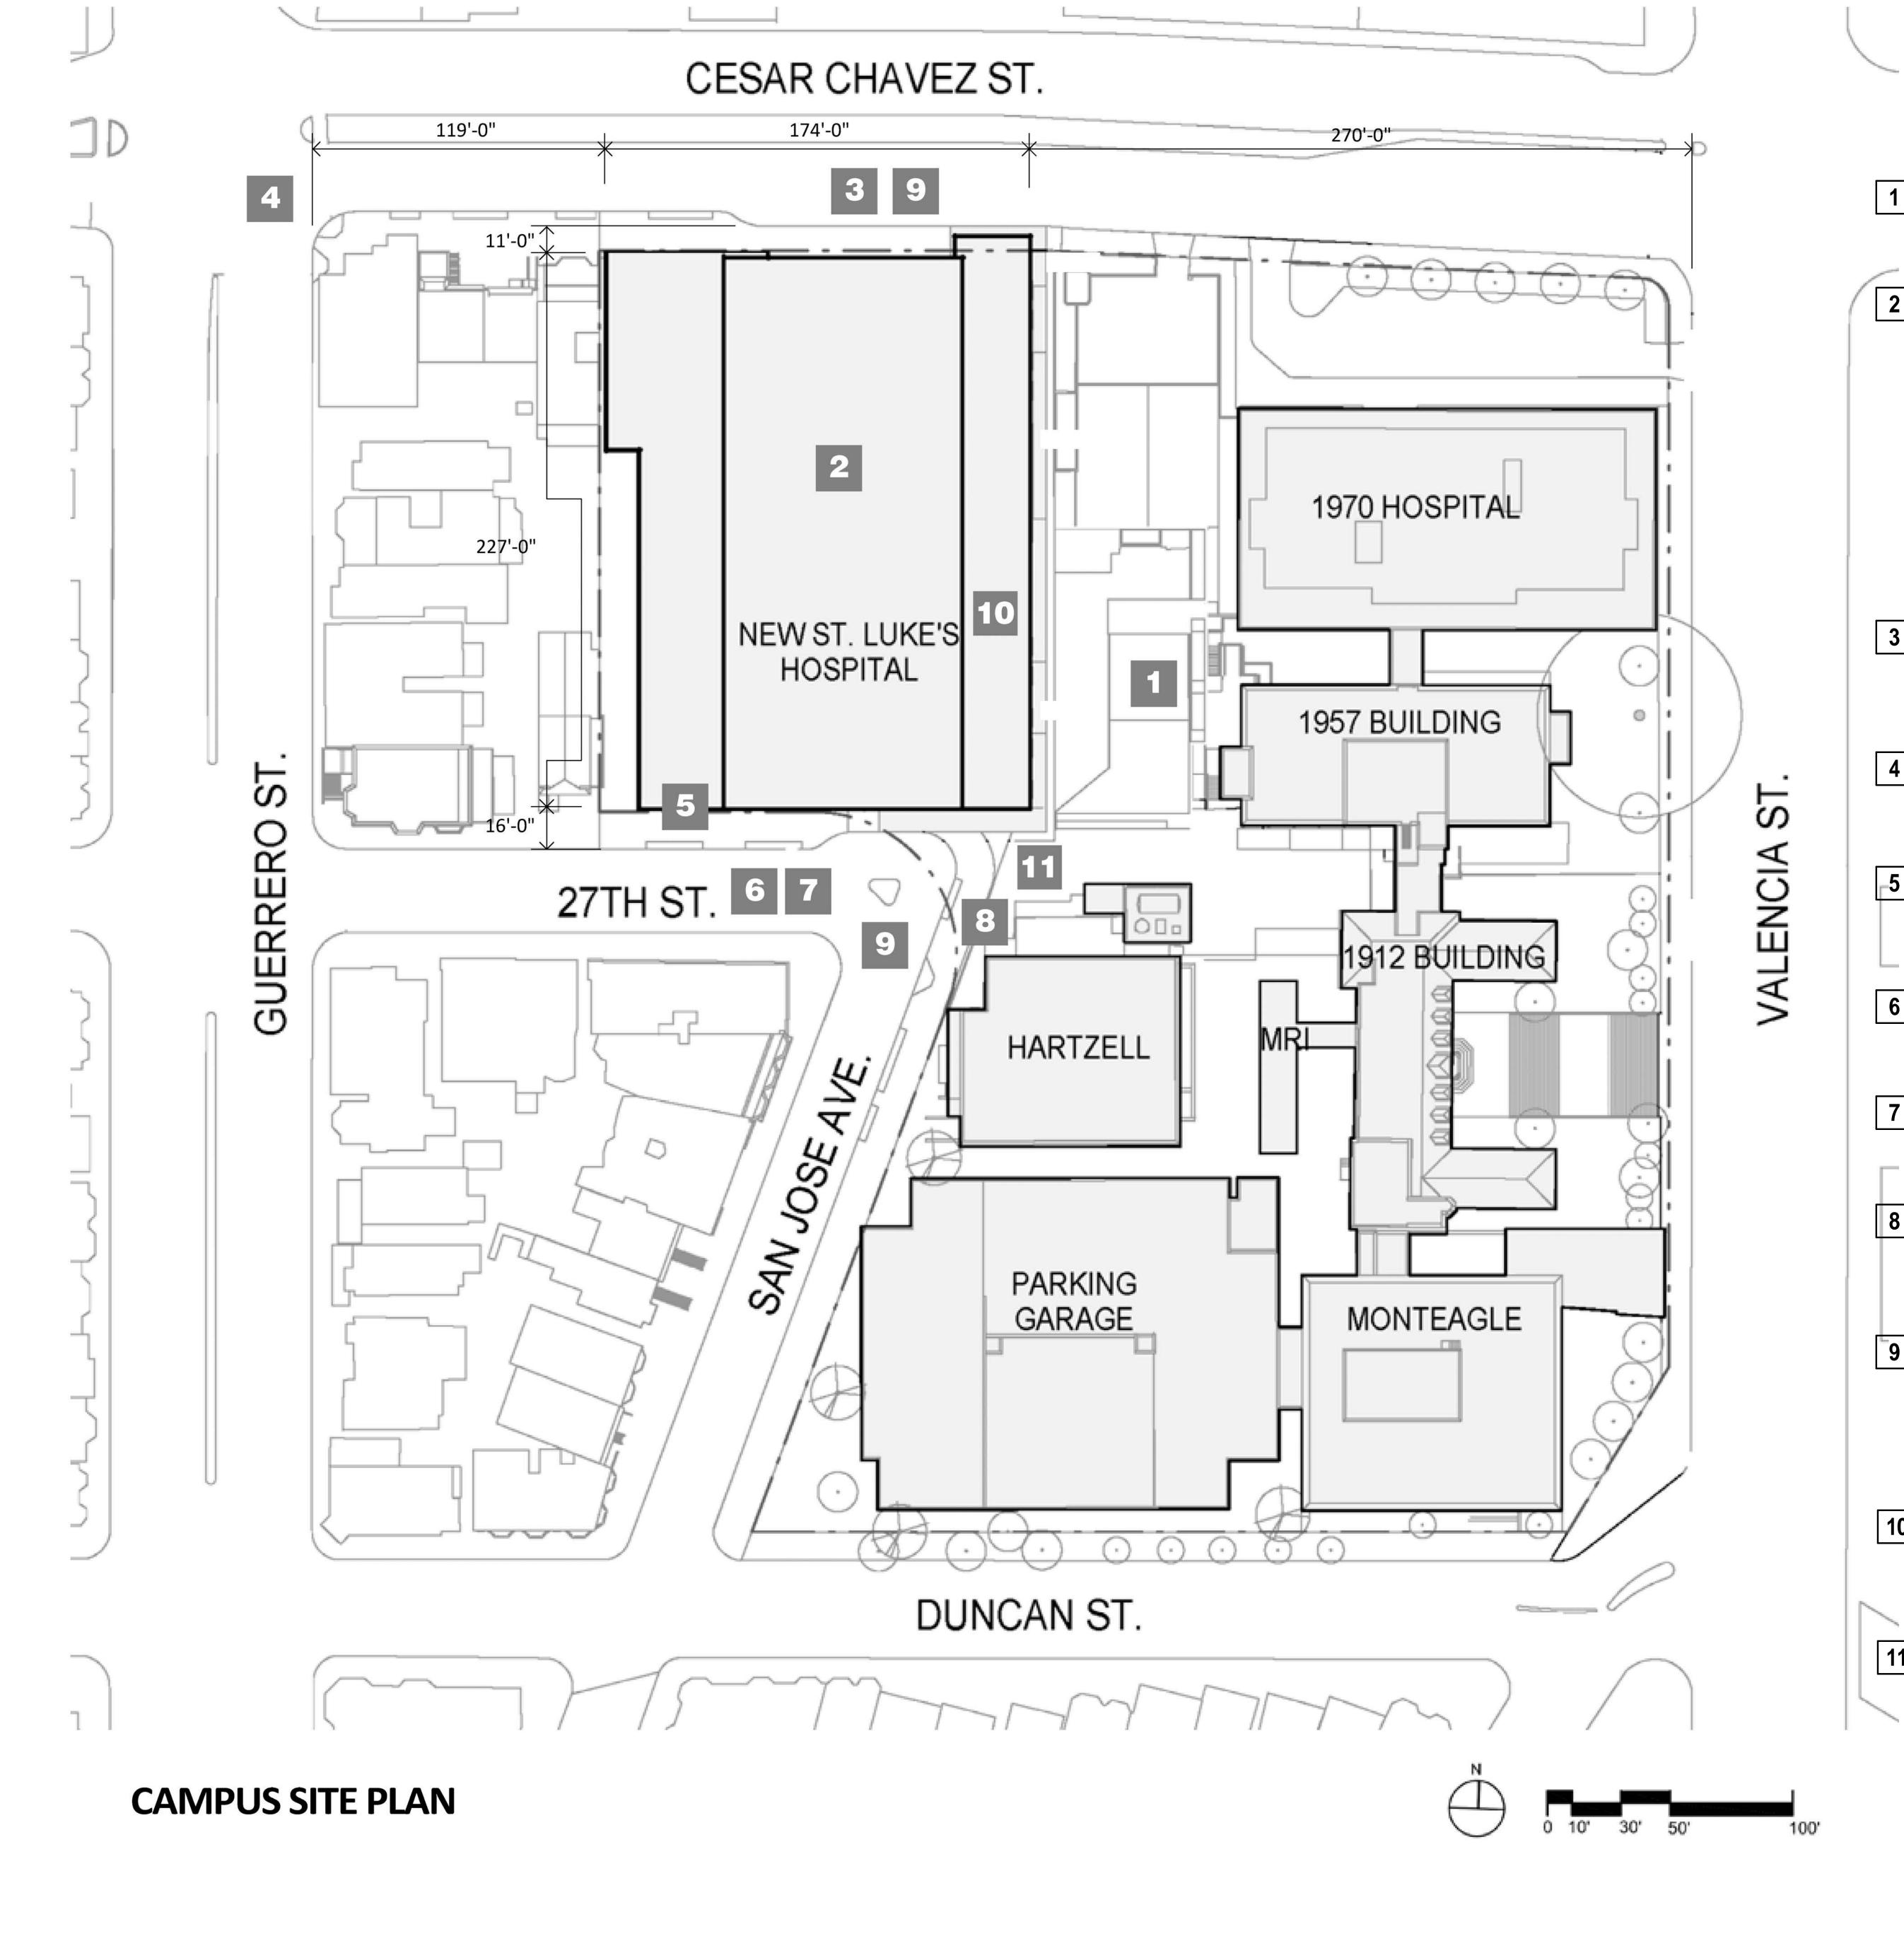



Demolition of the Redwood Administration Building and improvements on existing surface parking lot at 3615 Cesar Chavez Street.

Construction of the St. Luke's Replacement Hospital, a 325,690 sq. ft. seven-story hospital providing approximately 120 acute care beds. The St. Luke's Replacement Hospital may include, but is not limited to, inpatient medical care, diagnostic and treatment space, surgical care, critical care, labor and delivery, post-partum care, an expanded emergency department, cafeteria, loading area, and central utility plant space. Refer to sheets A2.1 through A4.1.

Street Improvements

Cesar Chavez Street sidewalk replacement and widening (south side between Guerrero Street and the eastern edge of the St. Luke's Replacement Hospital). Refer to sheets C3.0 & C4.0.

Pedestrian bulbouts on Cesar Chavez Street at Guerrero Street and Valencia Street. Refer to sheets C3.0 & C4.0.

27th Street sidewalk replacement (north side from western property line of the St. Luke's Campus to its terminus at San Jose Avenue). Refer to sheets C3.0 & C4.1.

27th Street/San Jose Avenue terminus street repaving (grind and overlay). Refer to sheets C3.0 &

7 27th Street/San Jose Avenue catch basin and manhole additions/replacements. Refer to sheet

San Jose Avenue sidewalk replacement (east side from 27th Street to the south facade of the Hartzell building) and including a curb ramp connector. Refer to sheets C3.0 & C4.1

Tree planting, landscape, hardscape and other streetscape improvements along portions of Cesar Chavez Street, 27th Street and San Jose Avenue!. Refer to sheets L1.00 & L1.01

Additional Improvements

Realign utilities currently located beneath San Jose Avenue between 27th Street and Cesar Chavez Street, including existing storm sewer, water main, and electrical and gas lines; Refer to sheet C5.0.

Install underground (hospital emergency generator) fuel storage tanks adjacent to hospital

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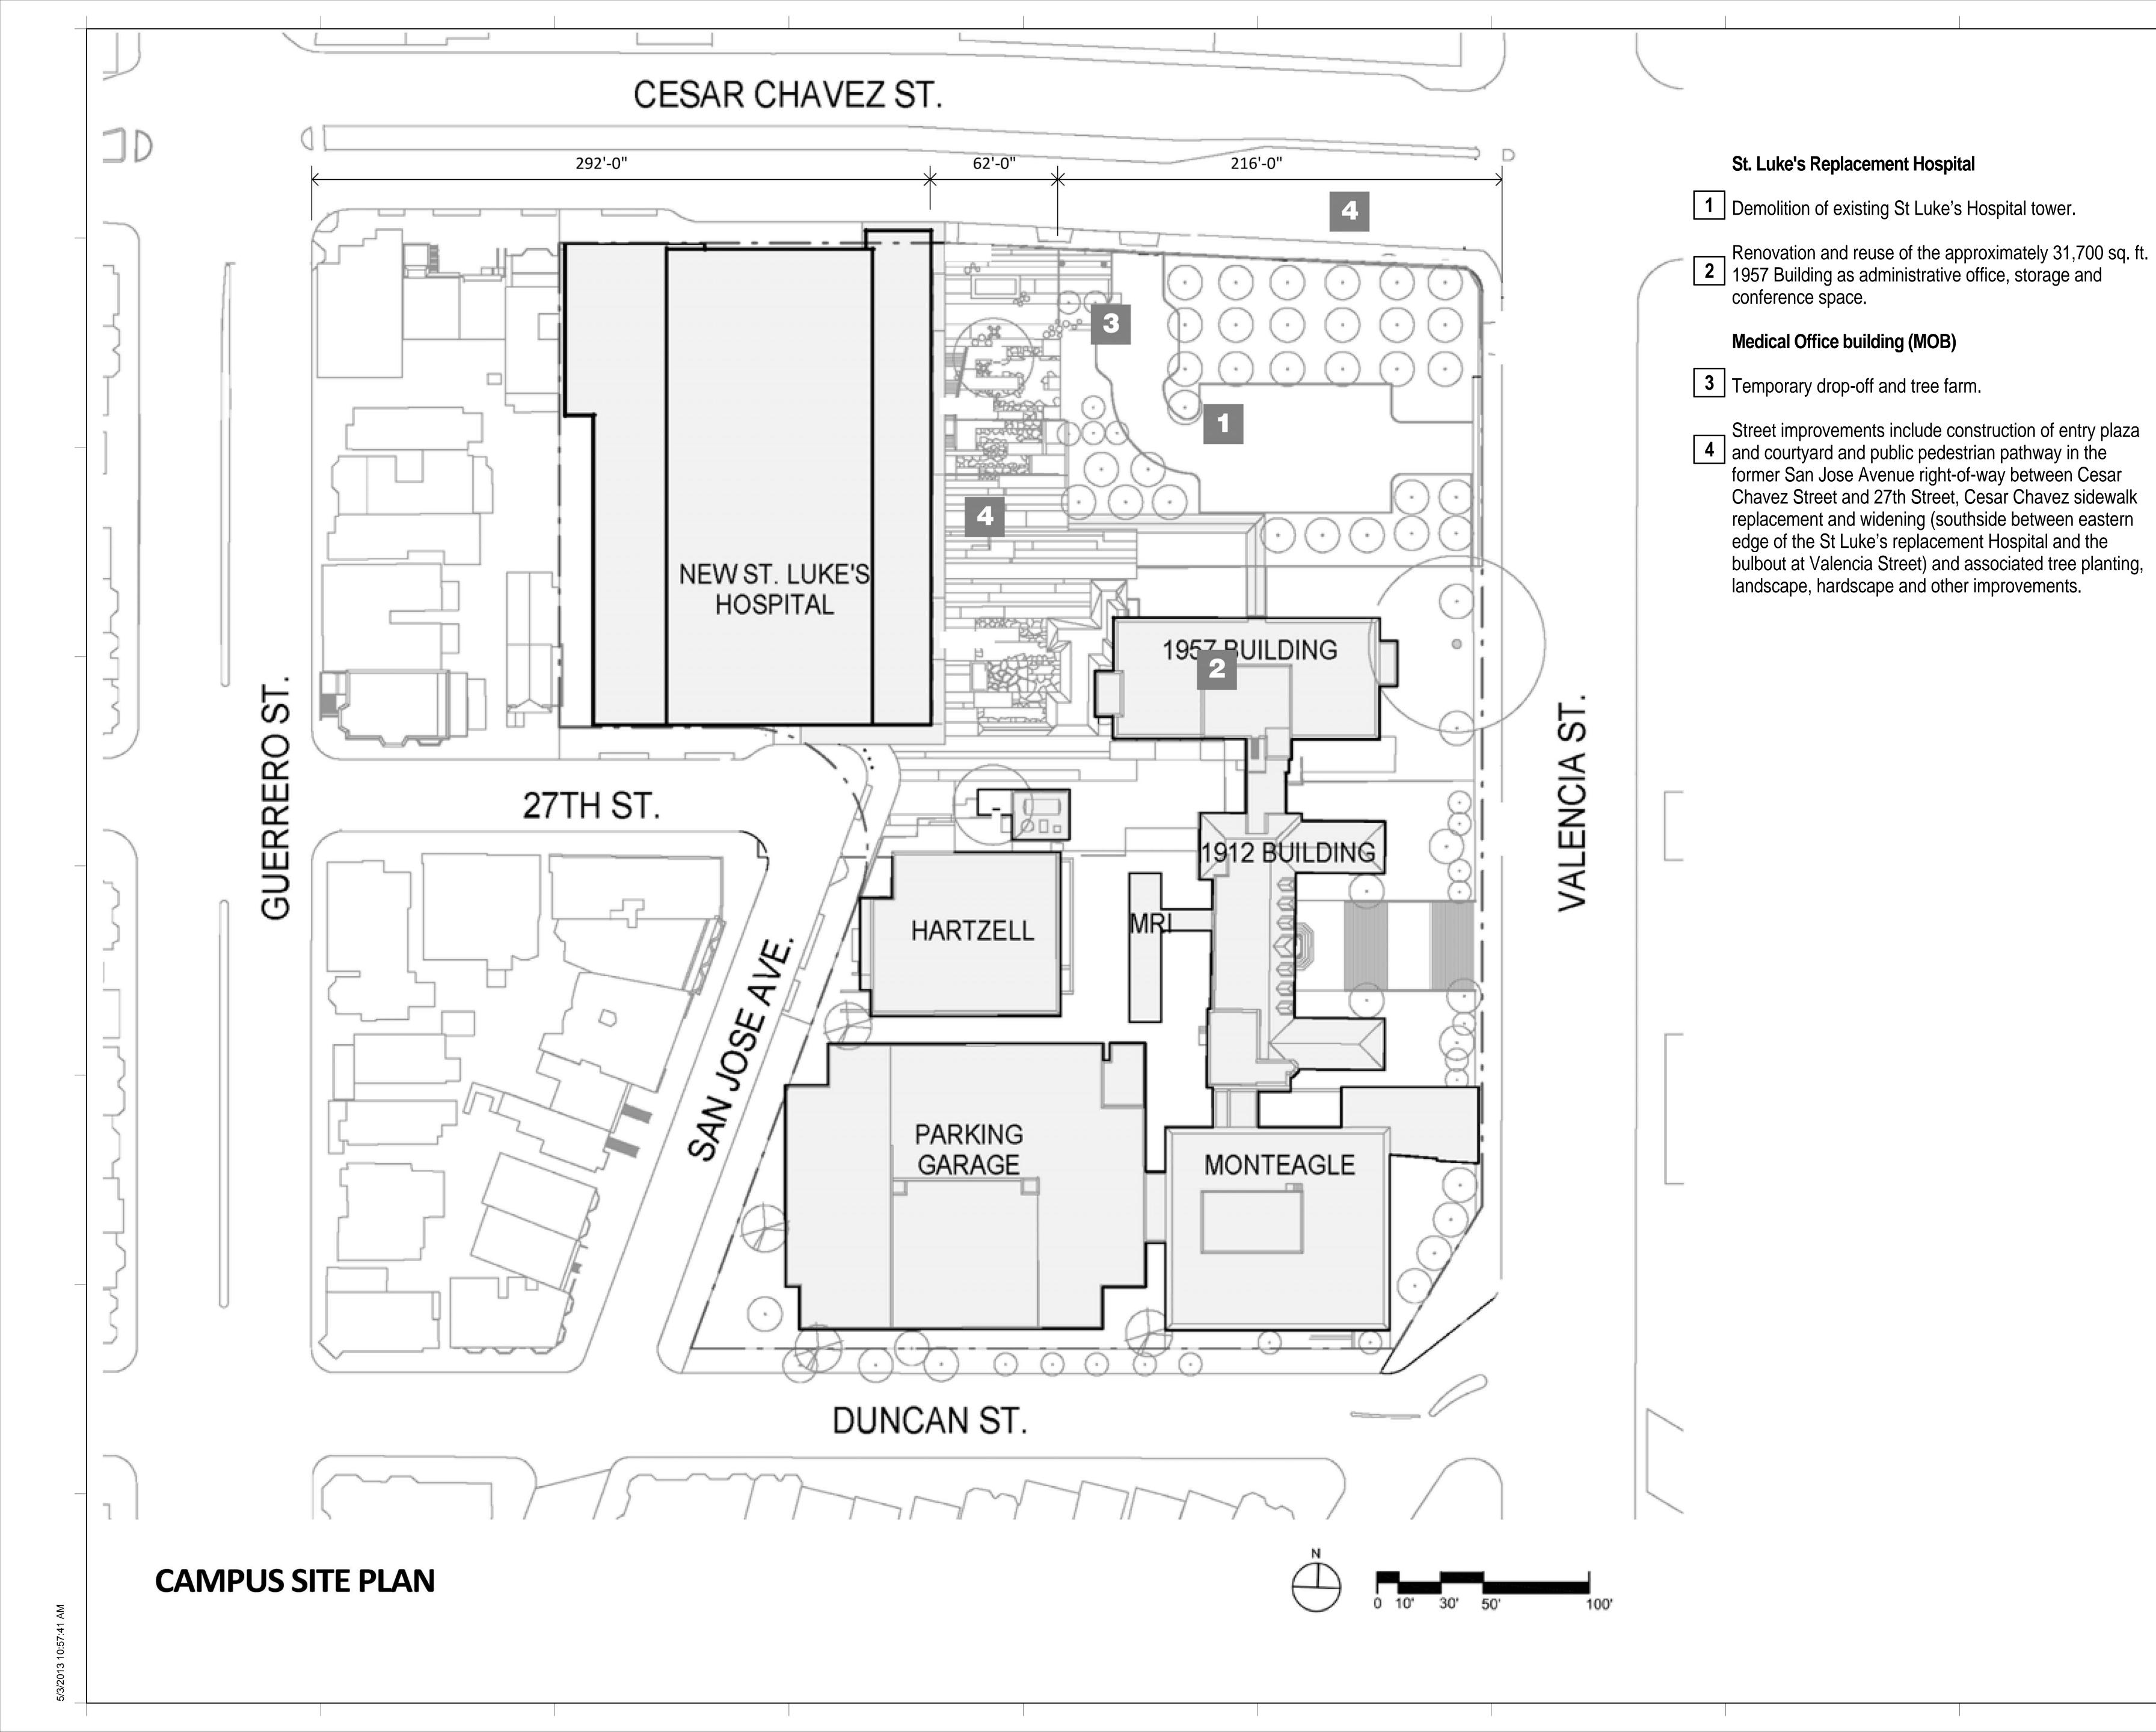
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CU APPLICATION UPDATE

CU APPLICATION UPDATE 2

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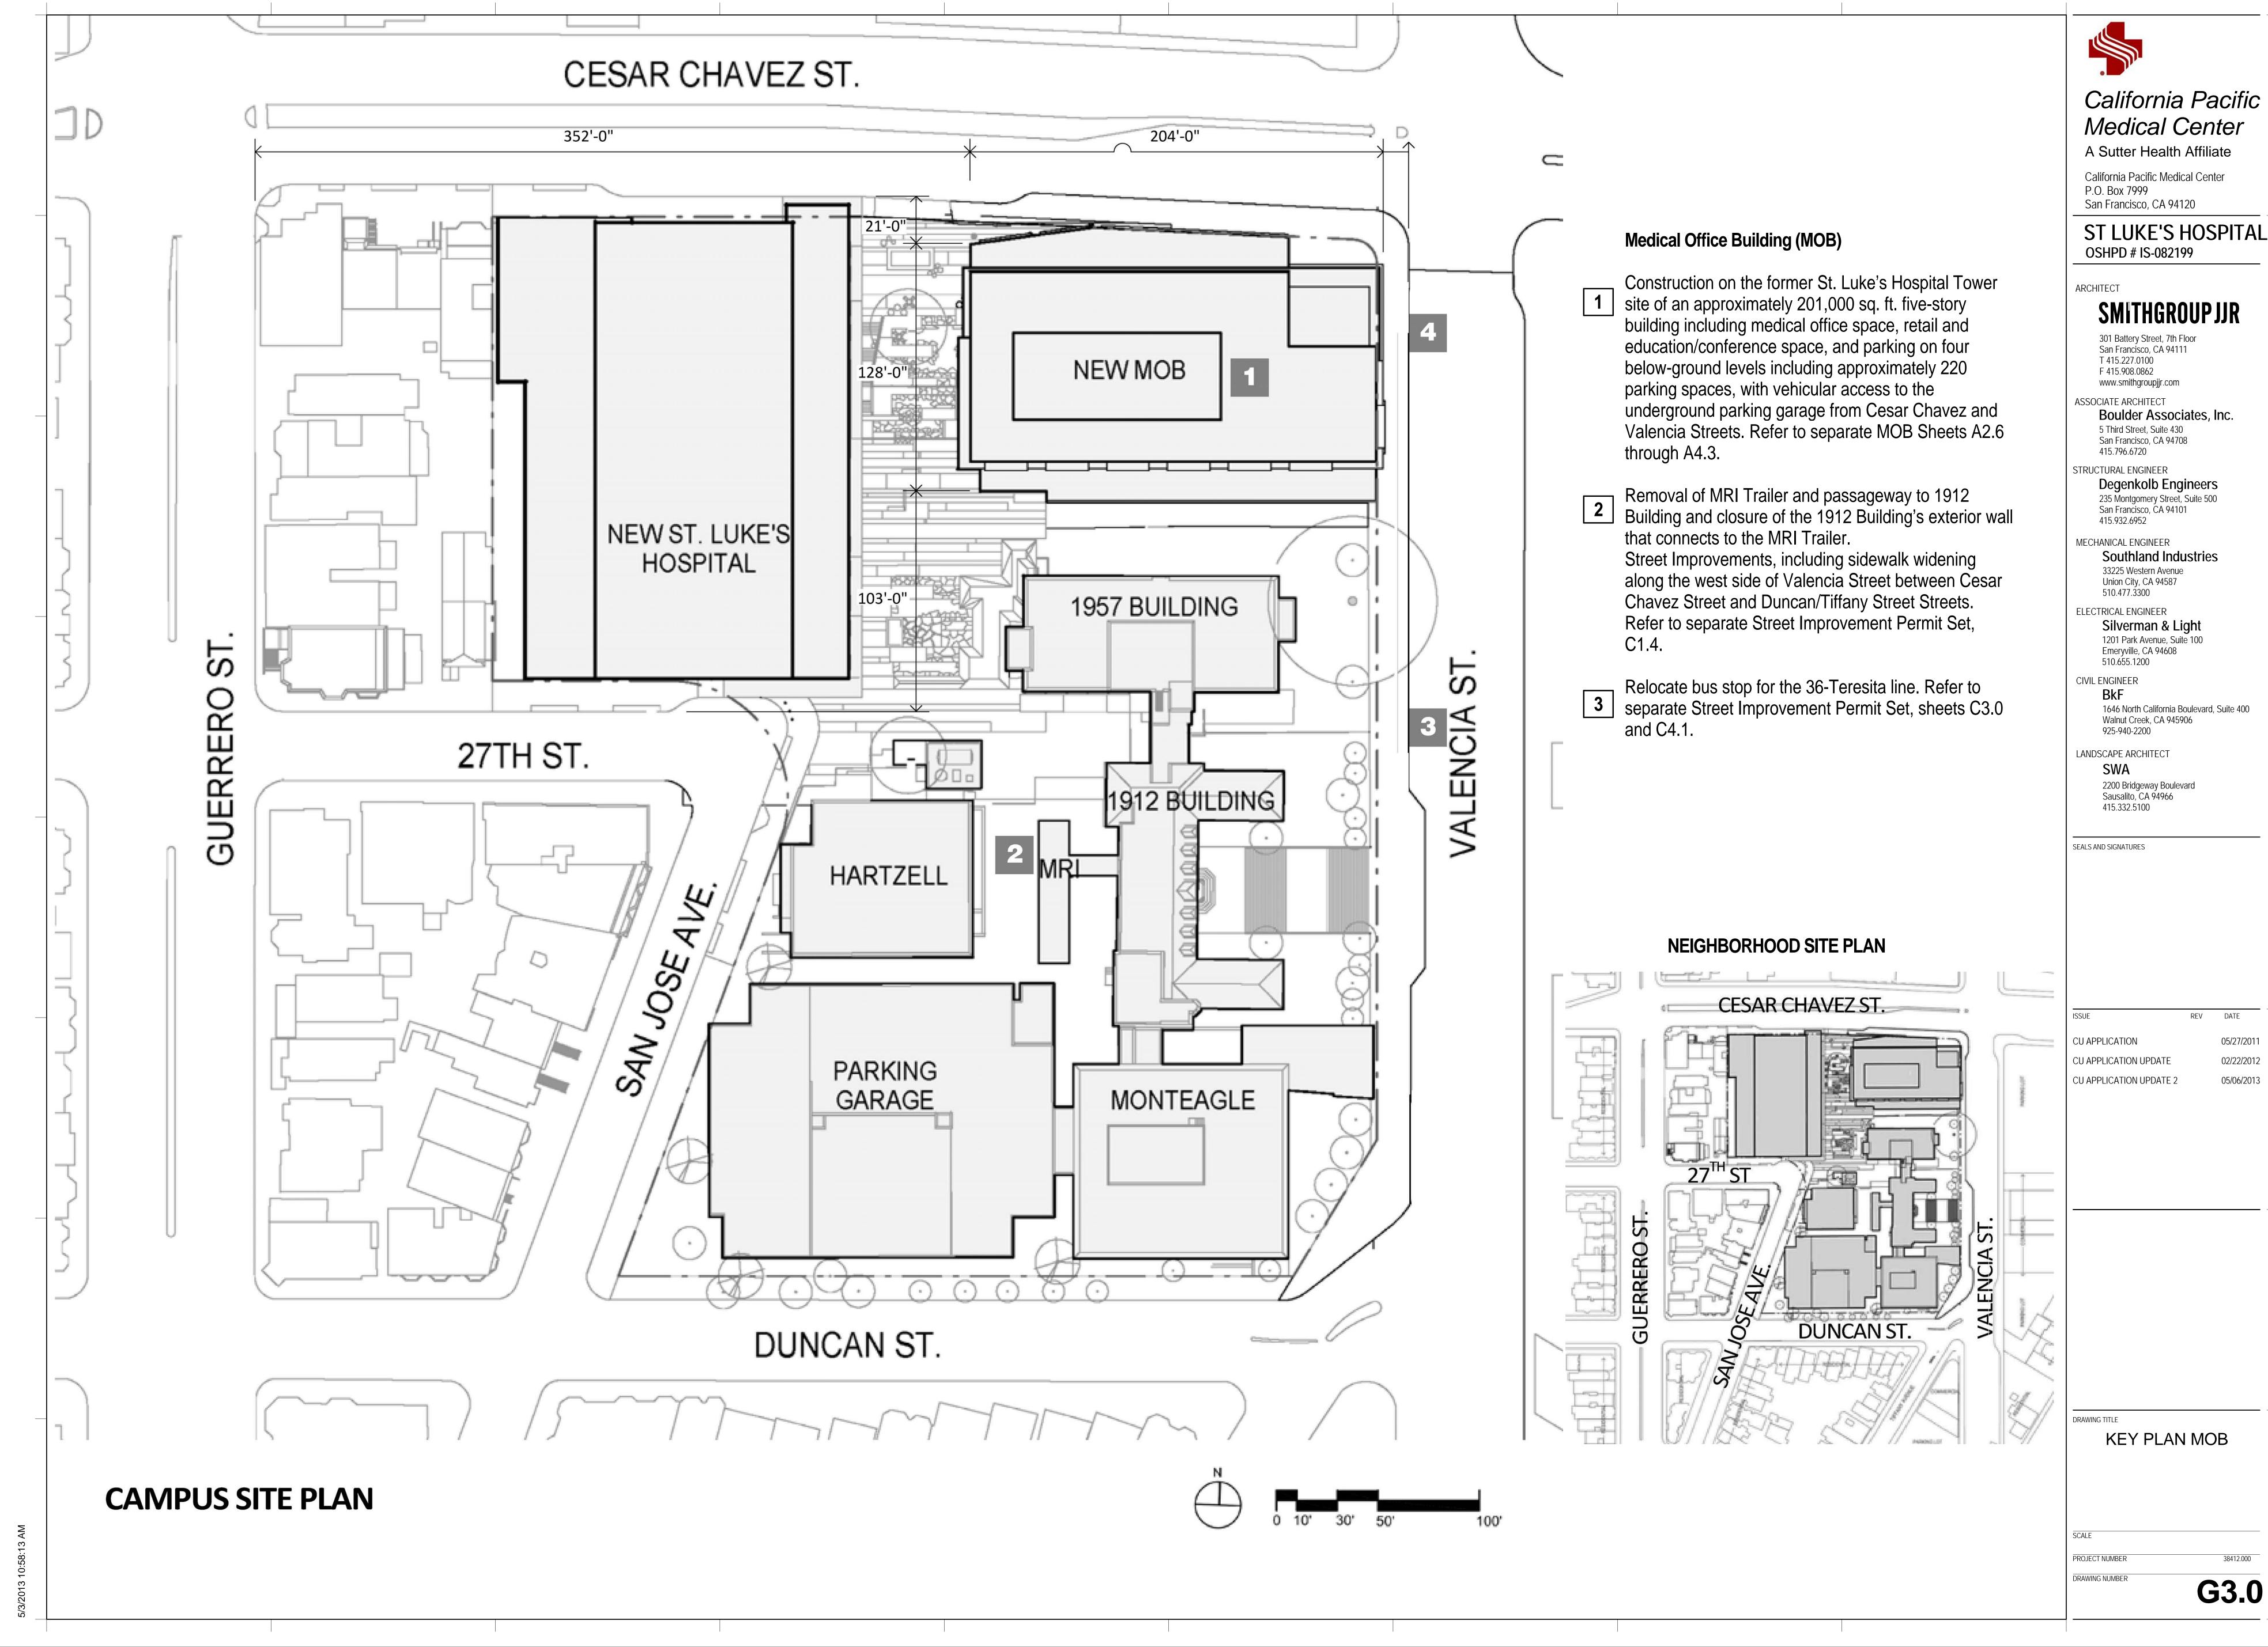
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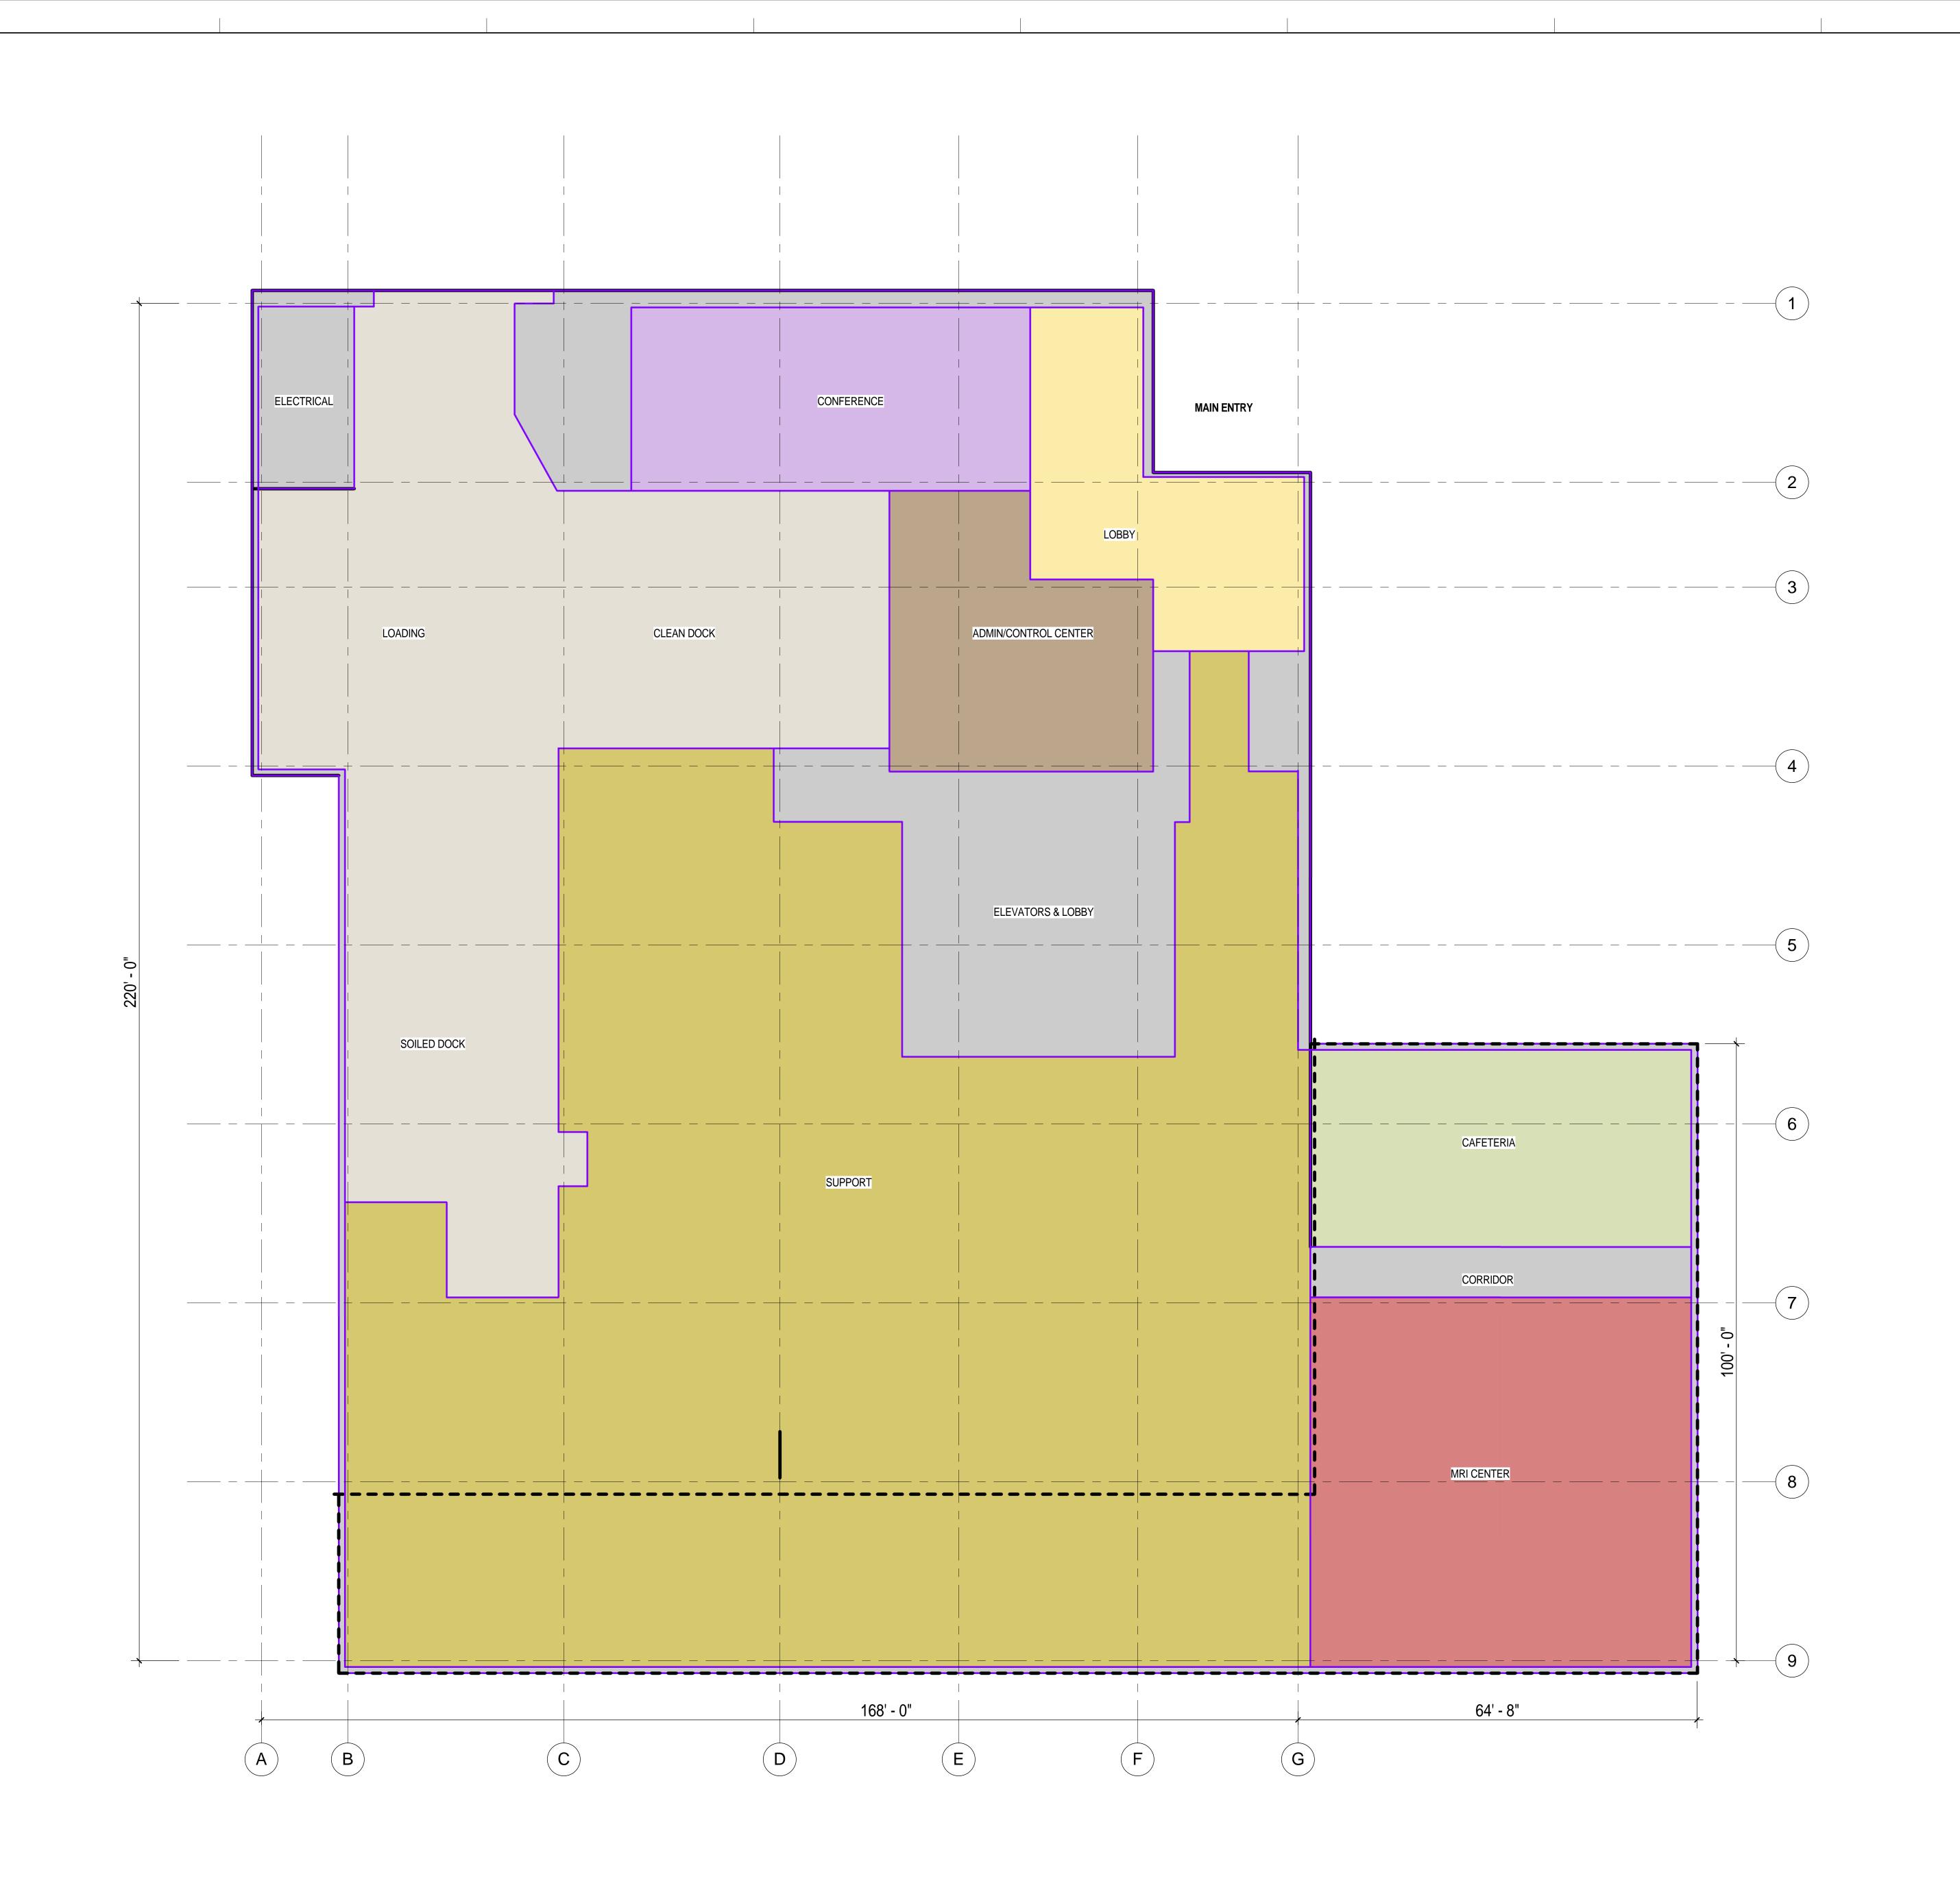
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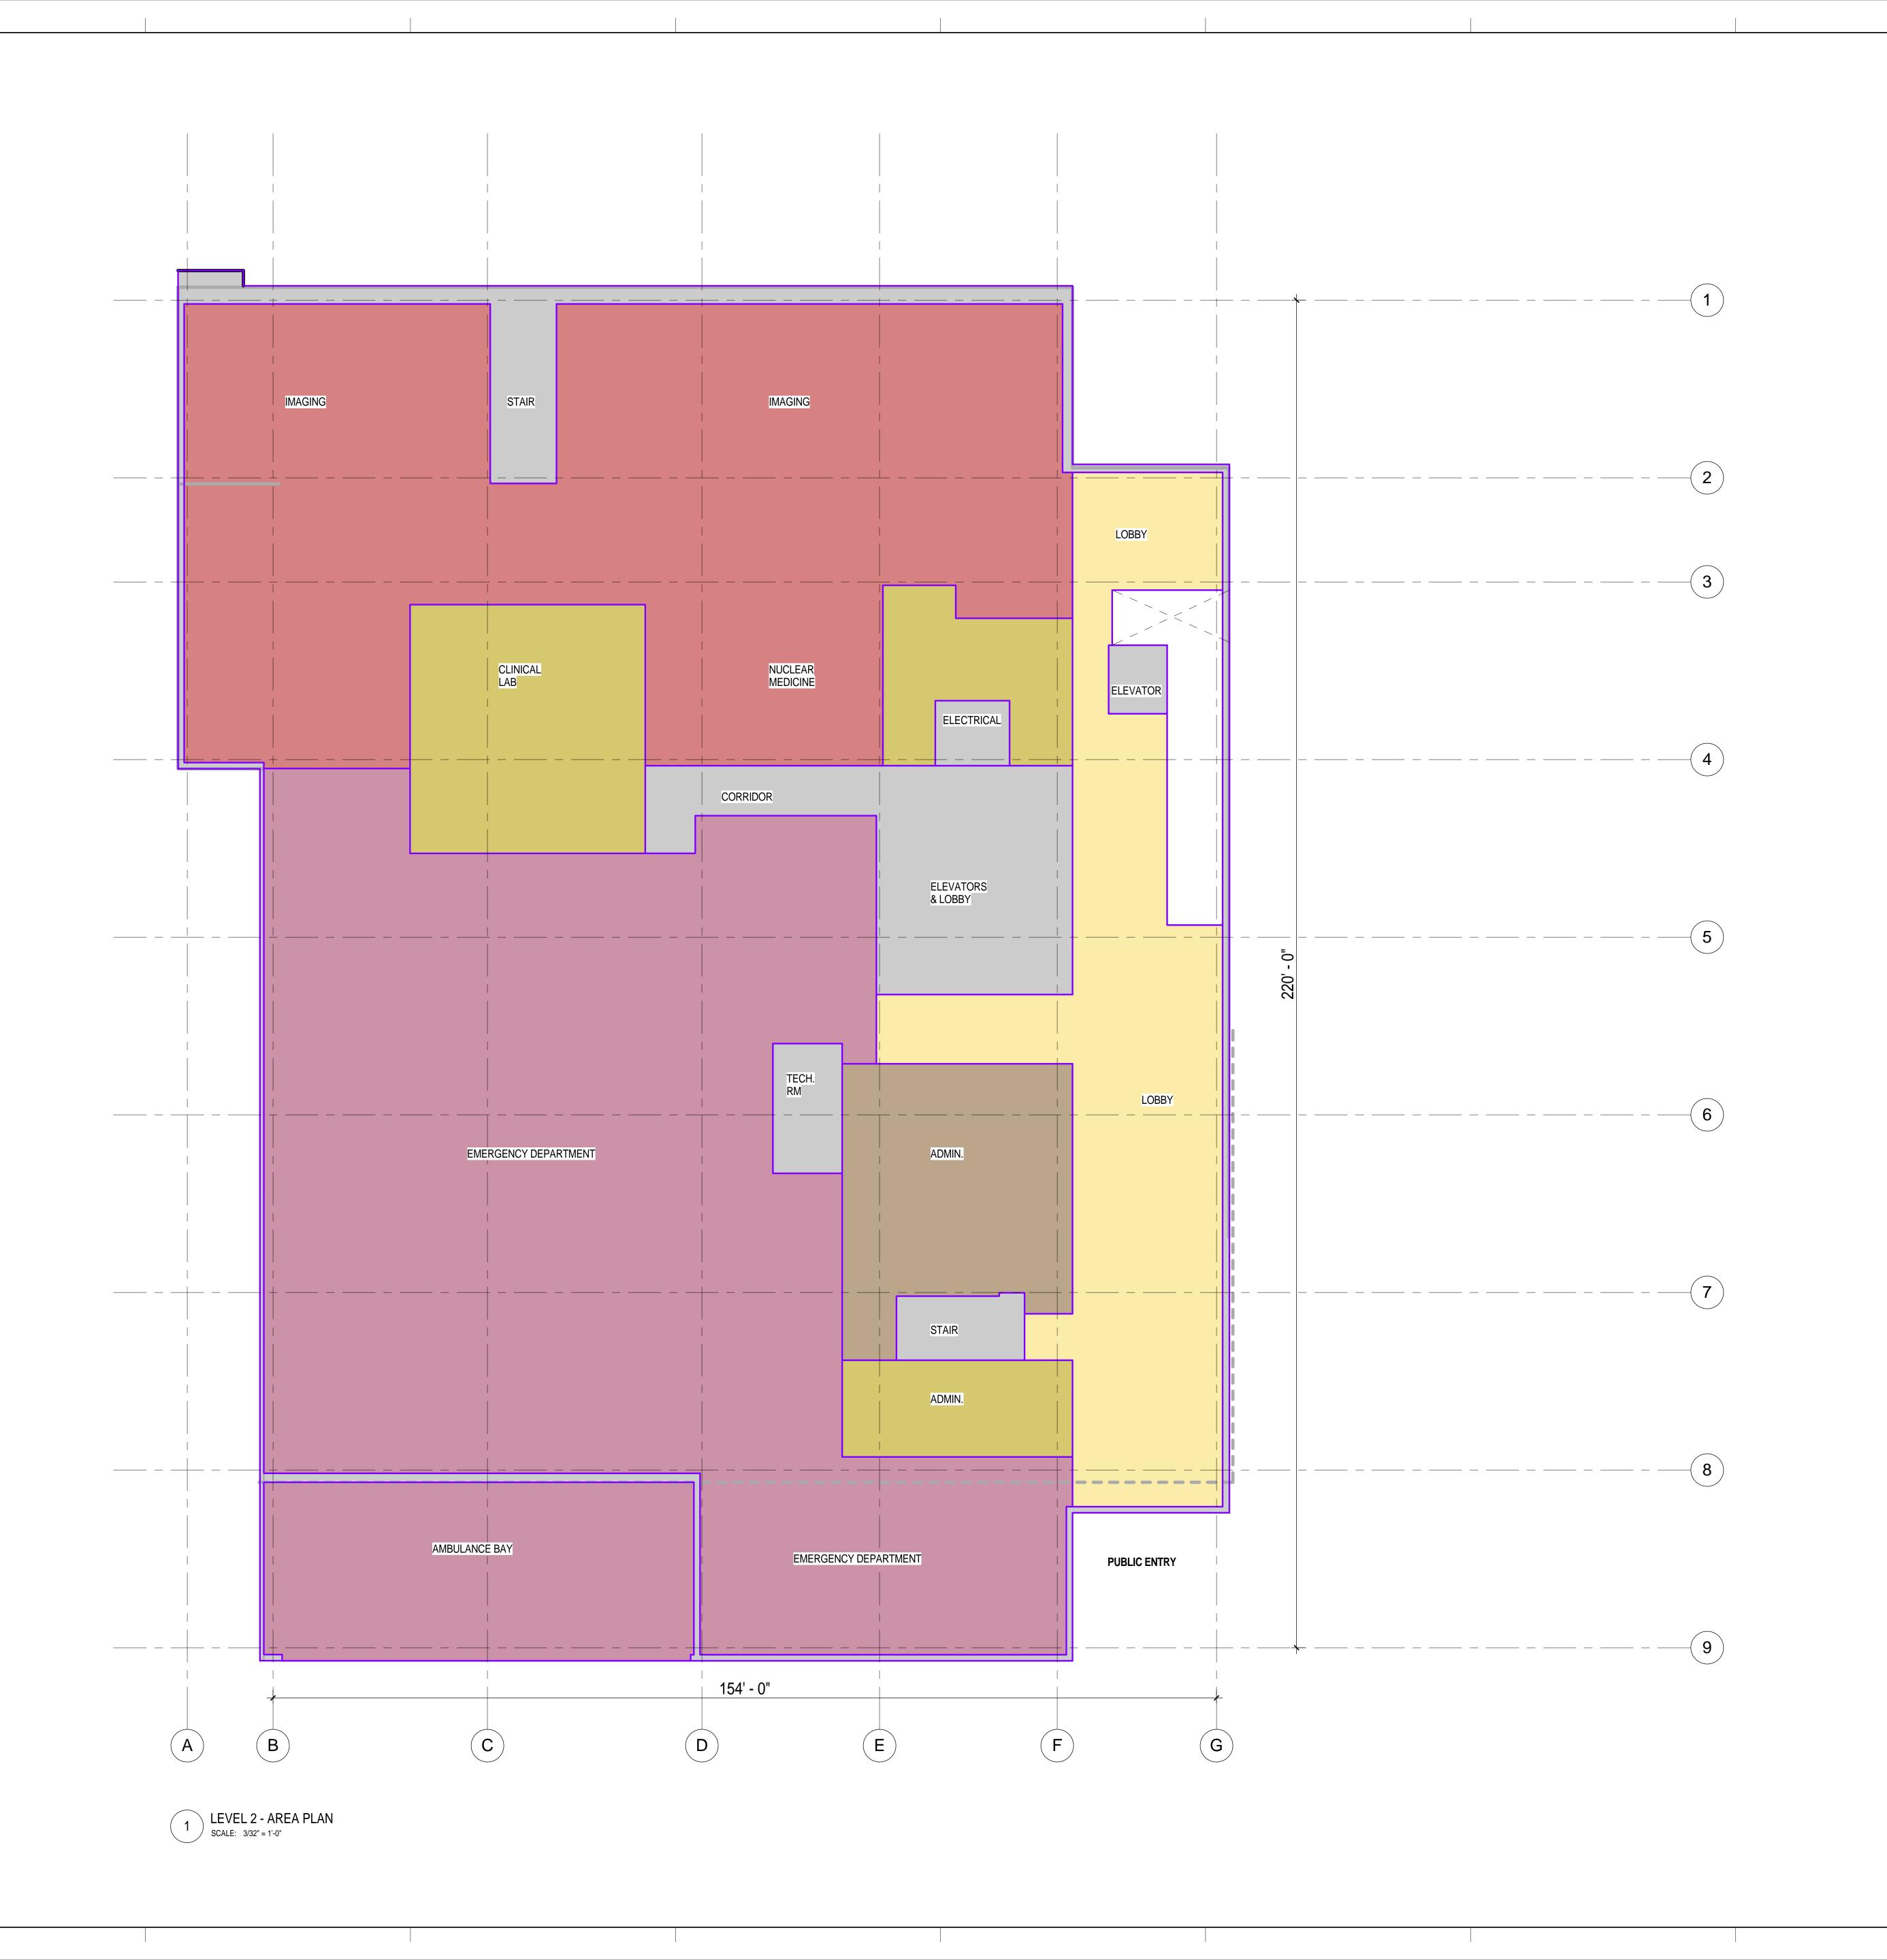
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HOSPITAL LEVEL 1 PLAN

PROJECT NUMBER

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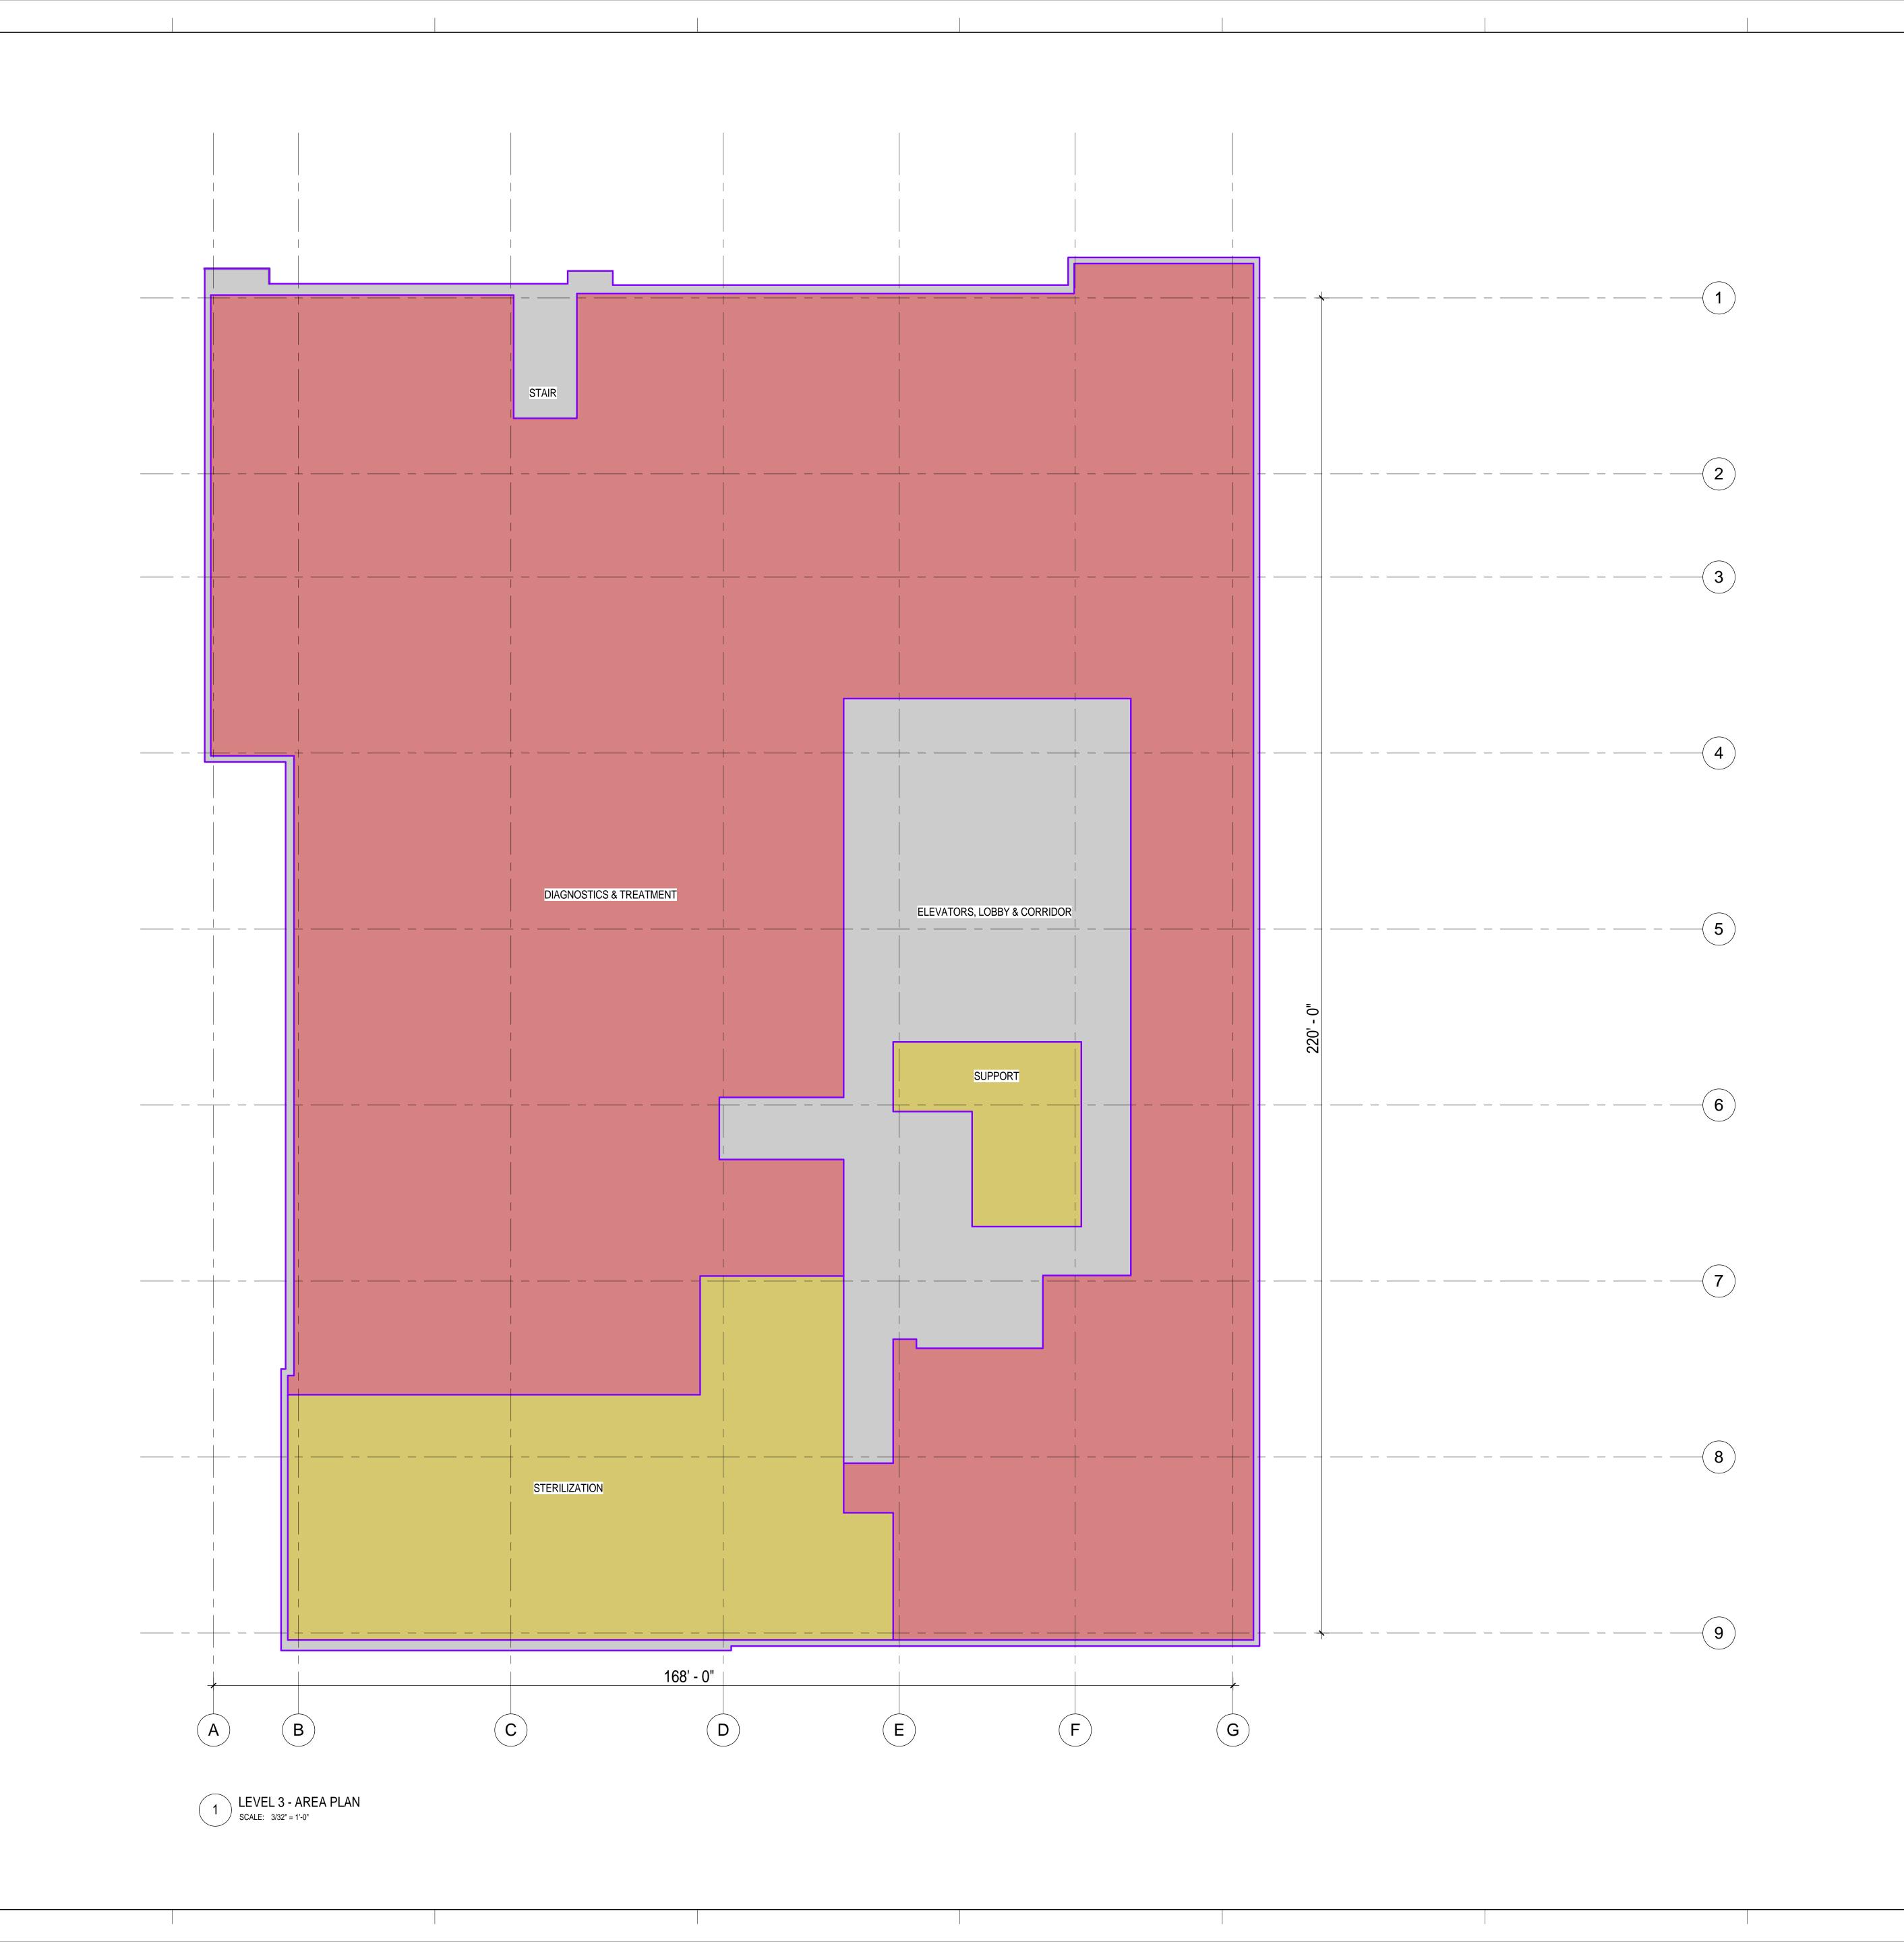
HOSPITAL LEVEL 2 PLAN

SCALE
PROJECT NUMBER

DRAWING NUMBER

A2.2

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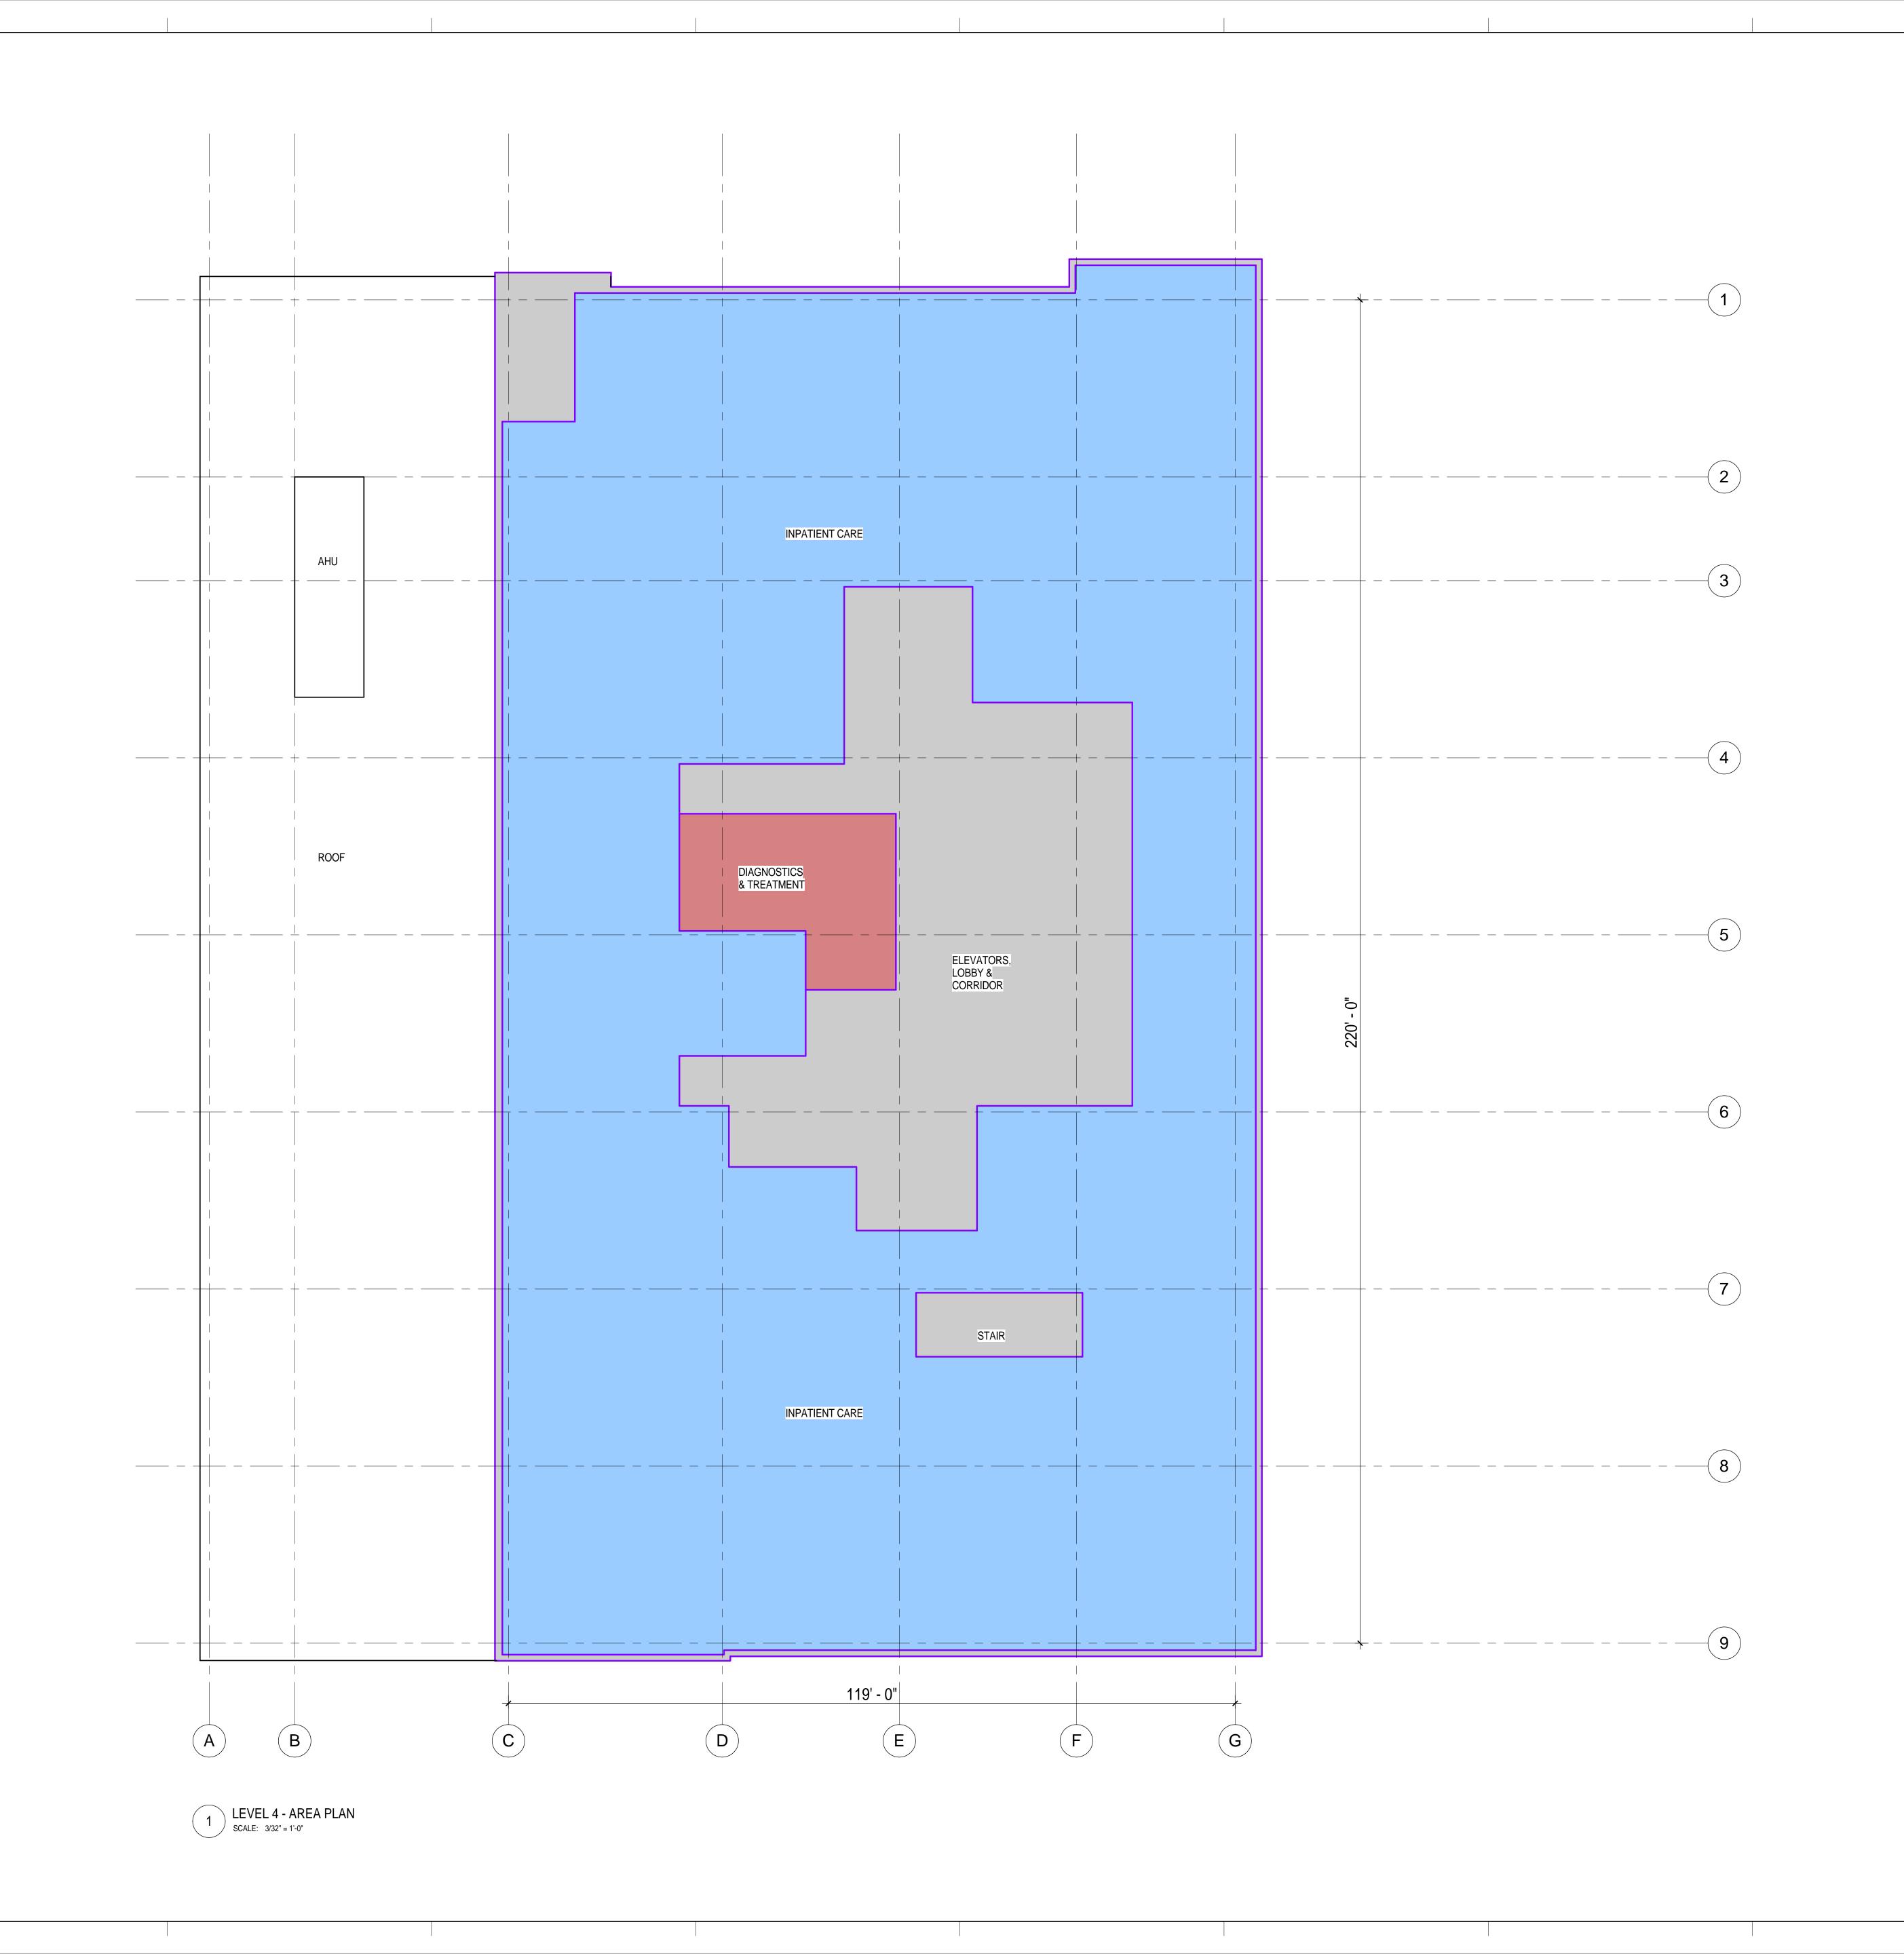
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HOSPITAL LEVEL 3 PLAN

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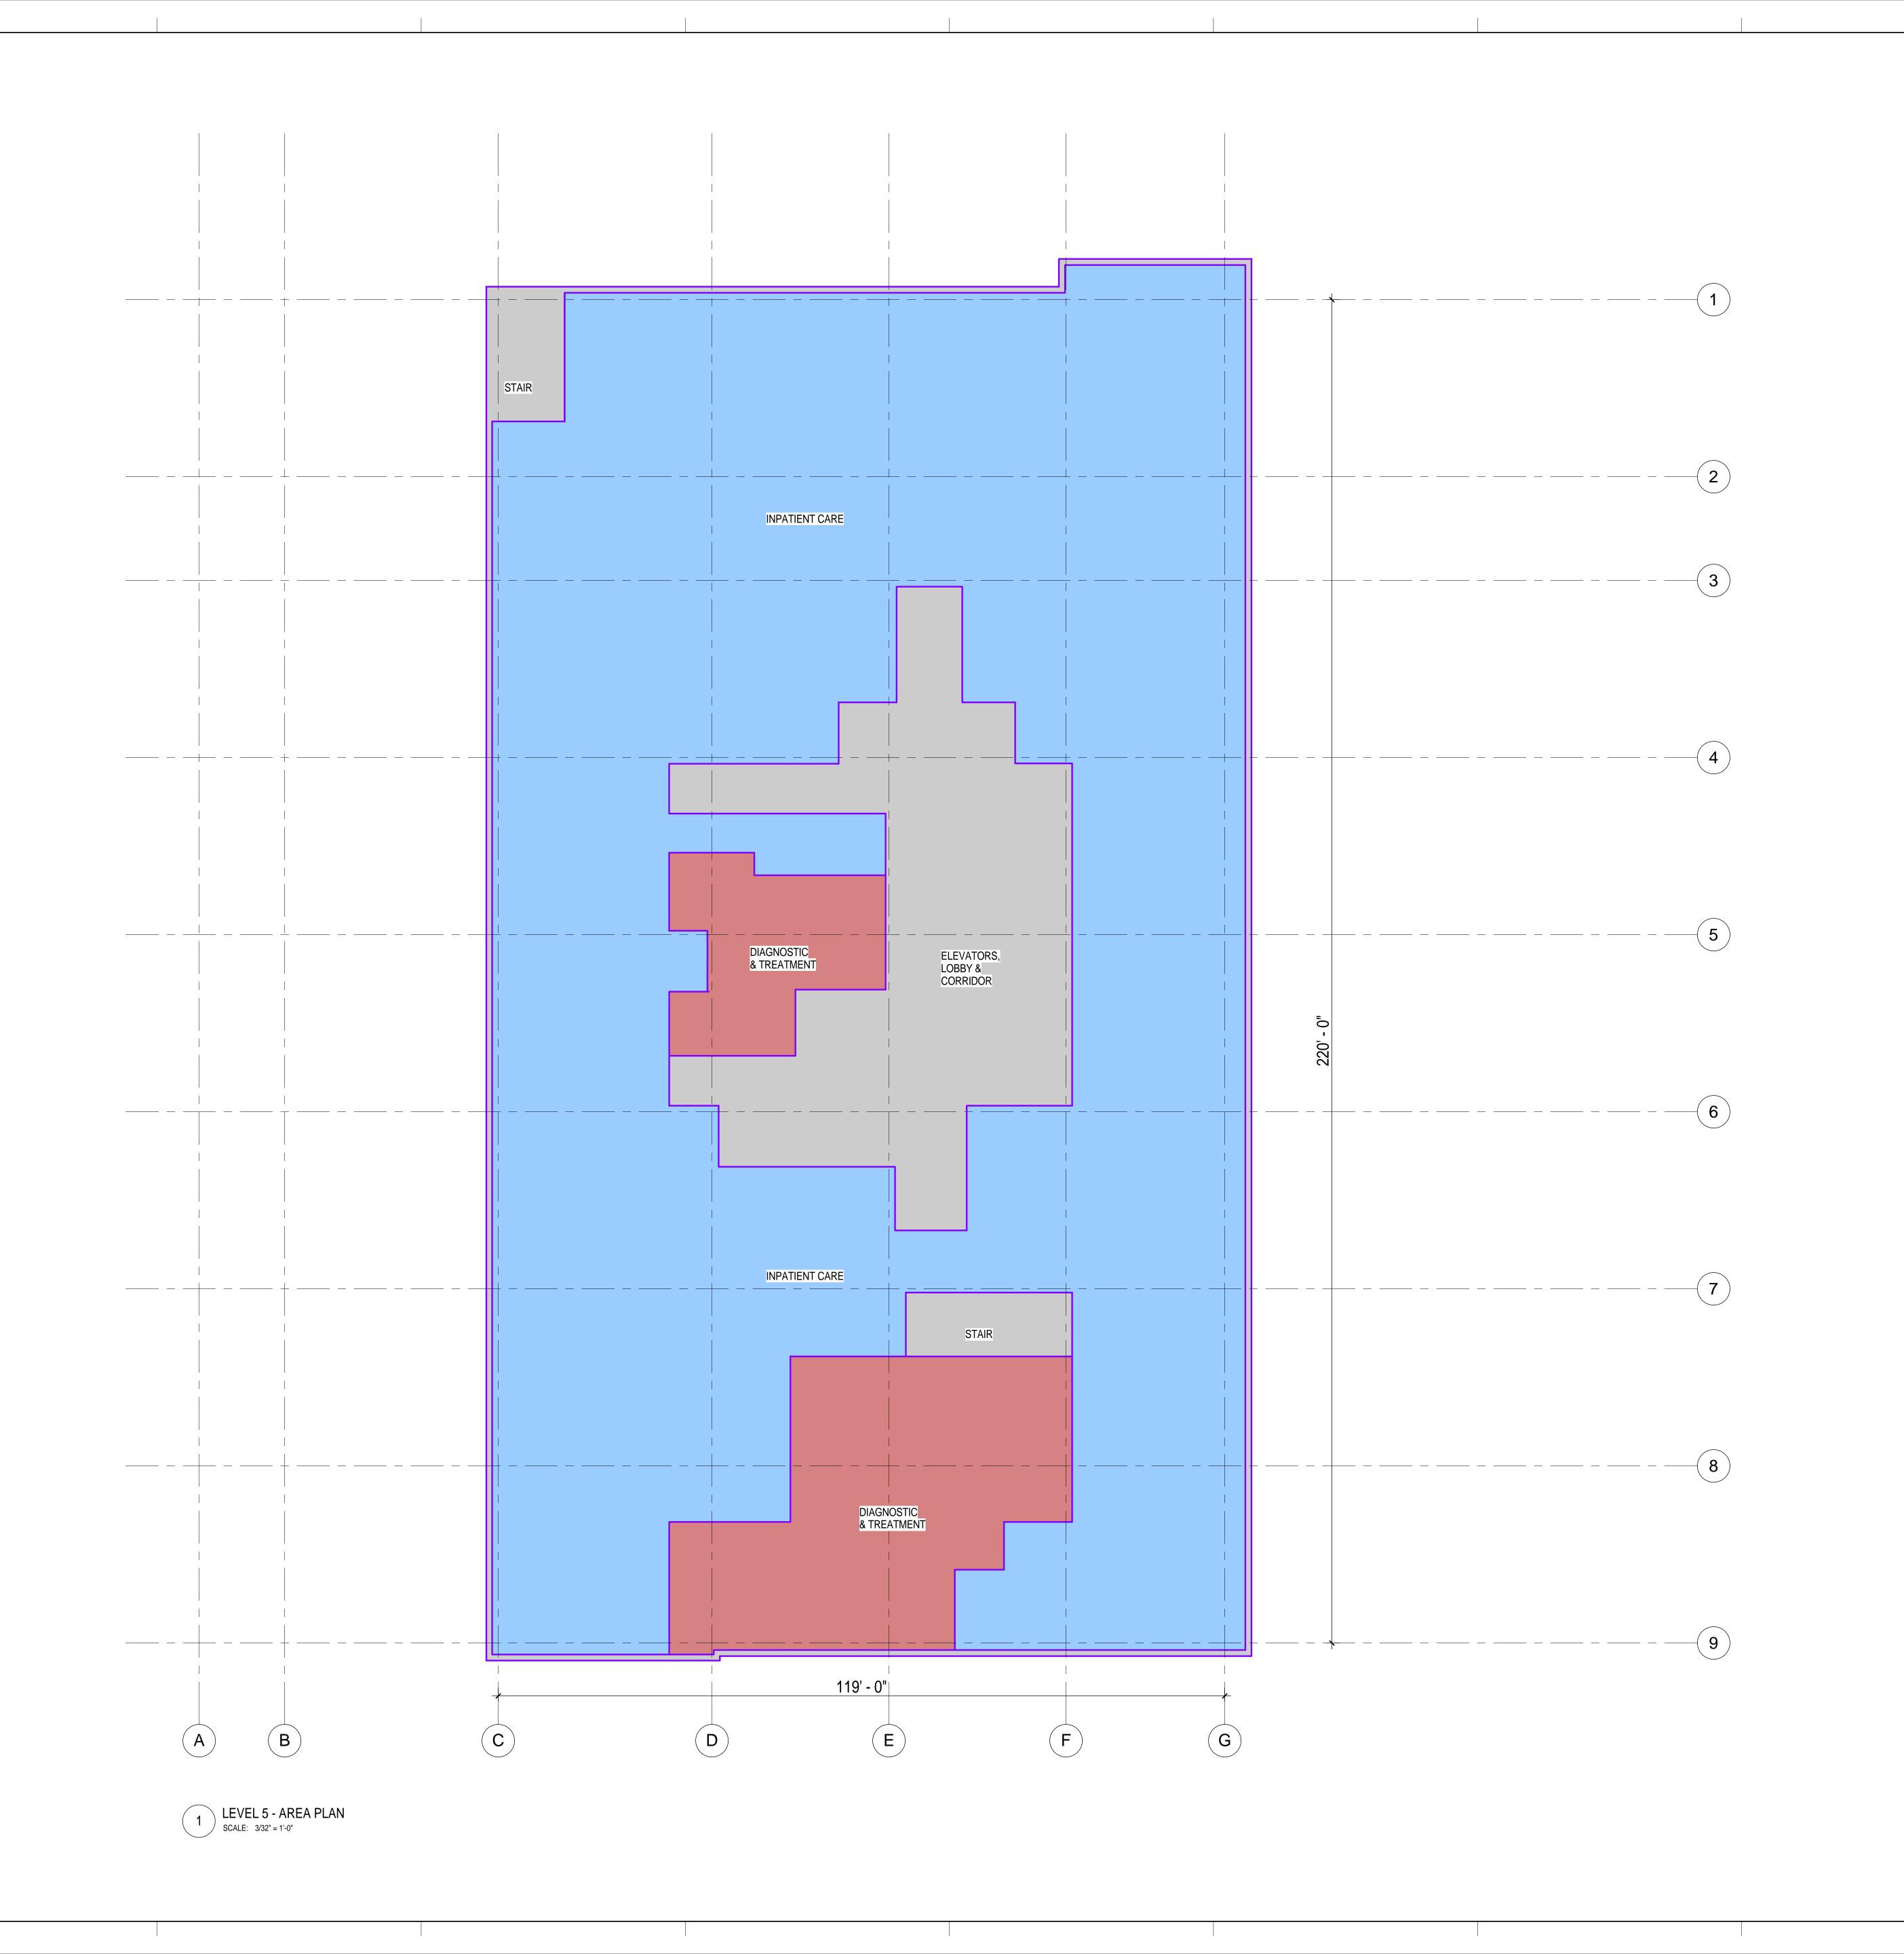
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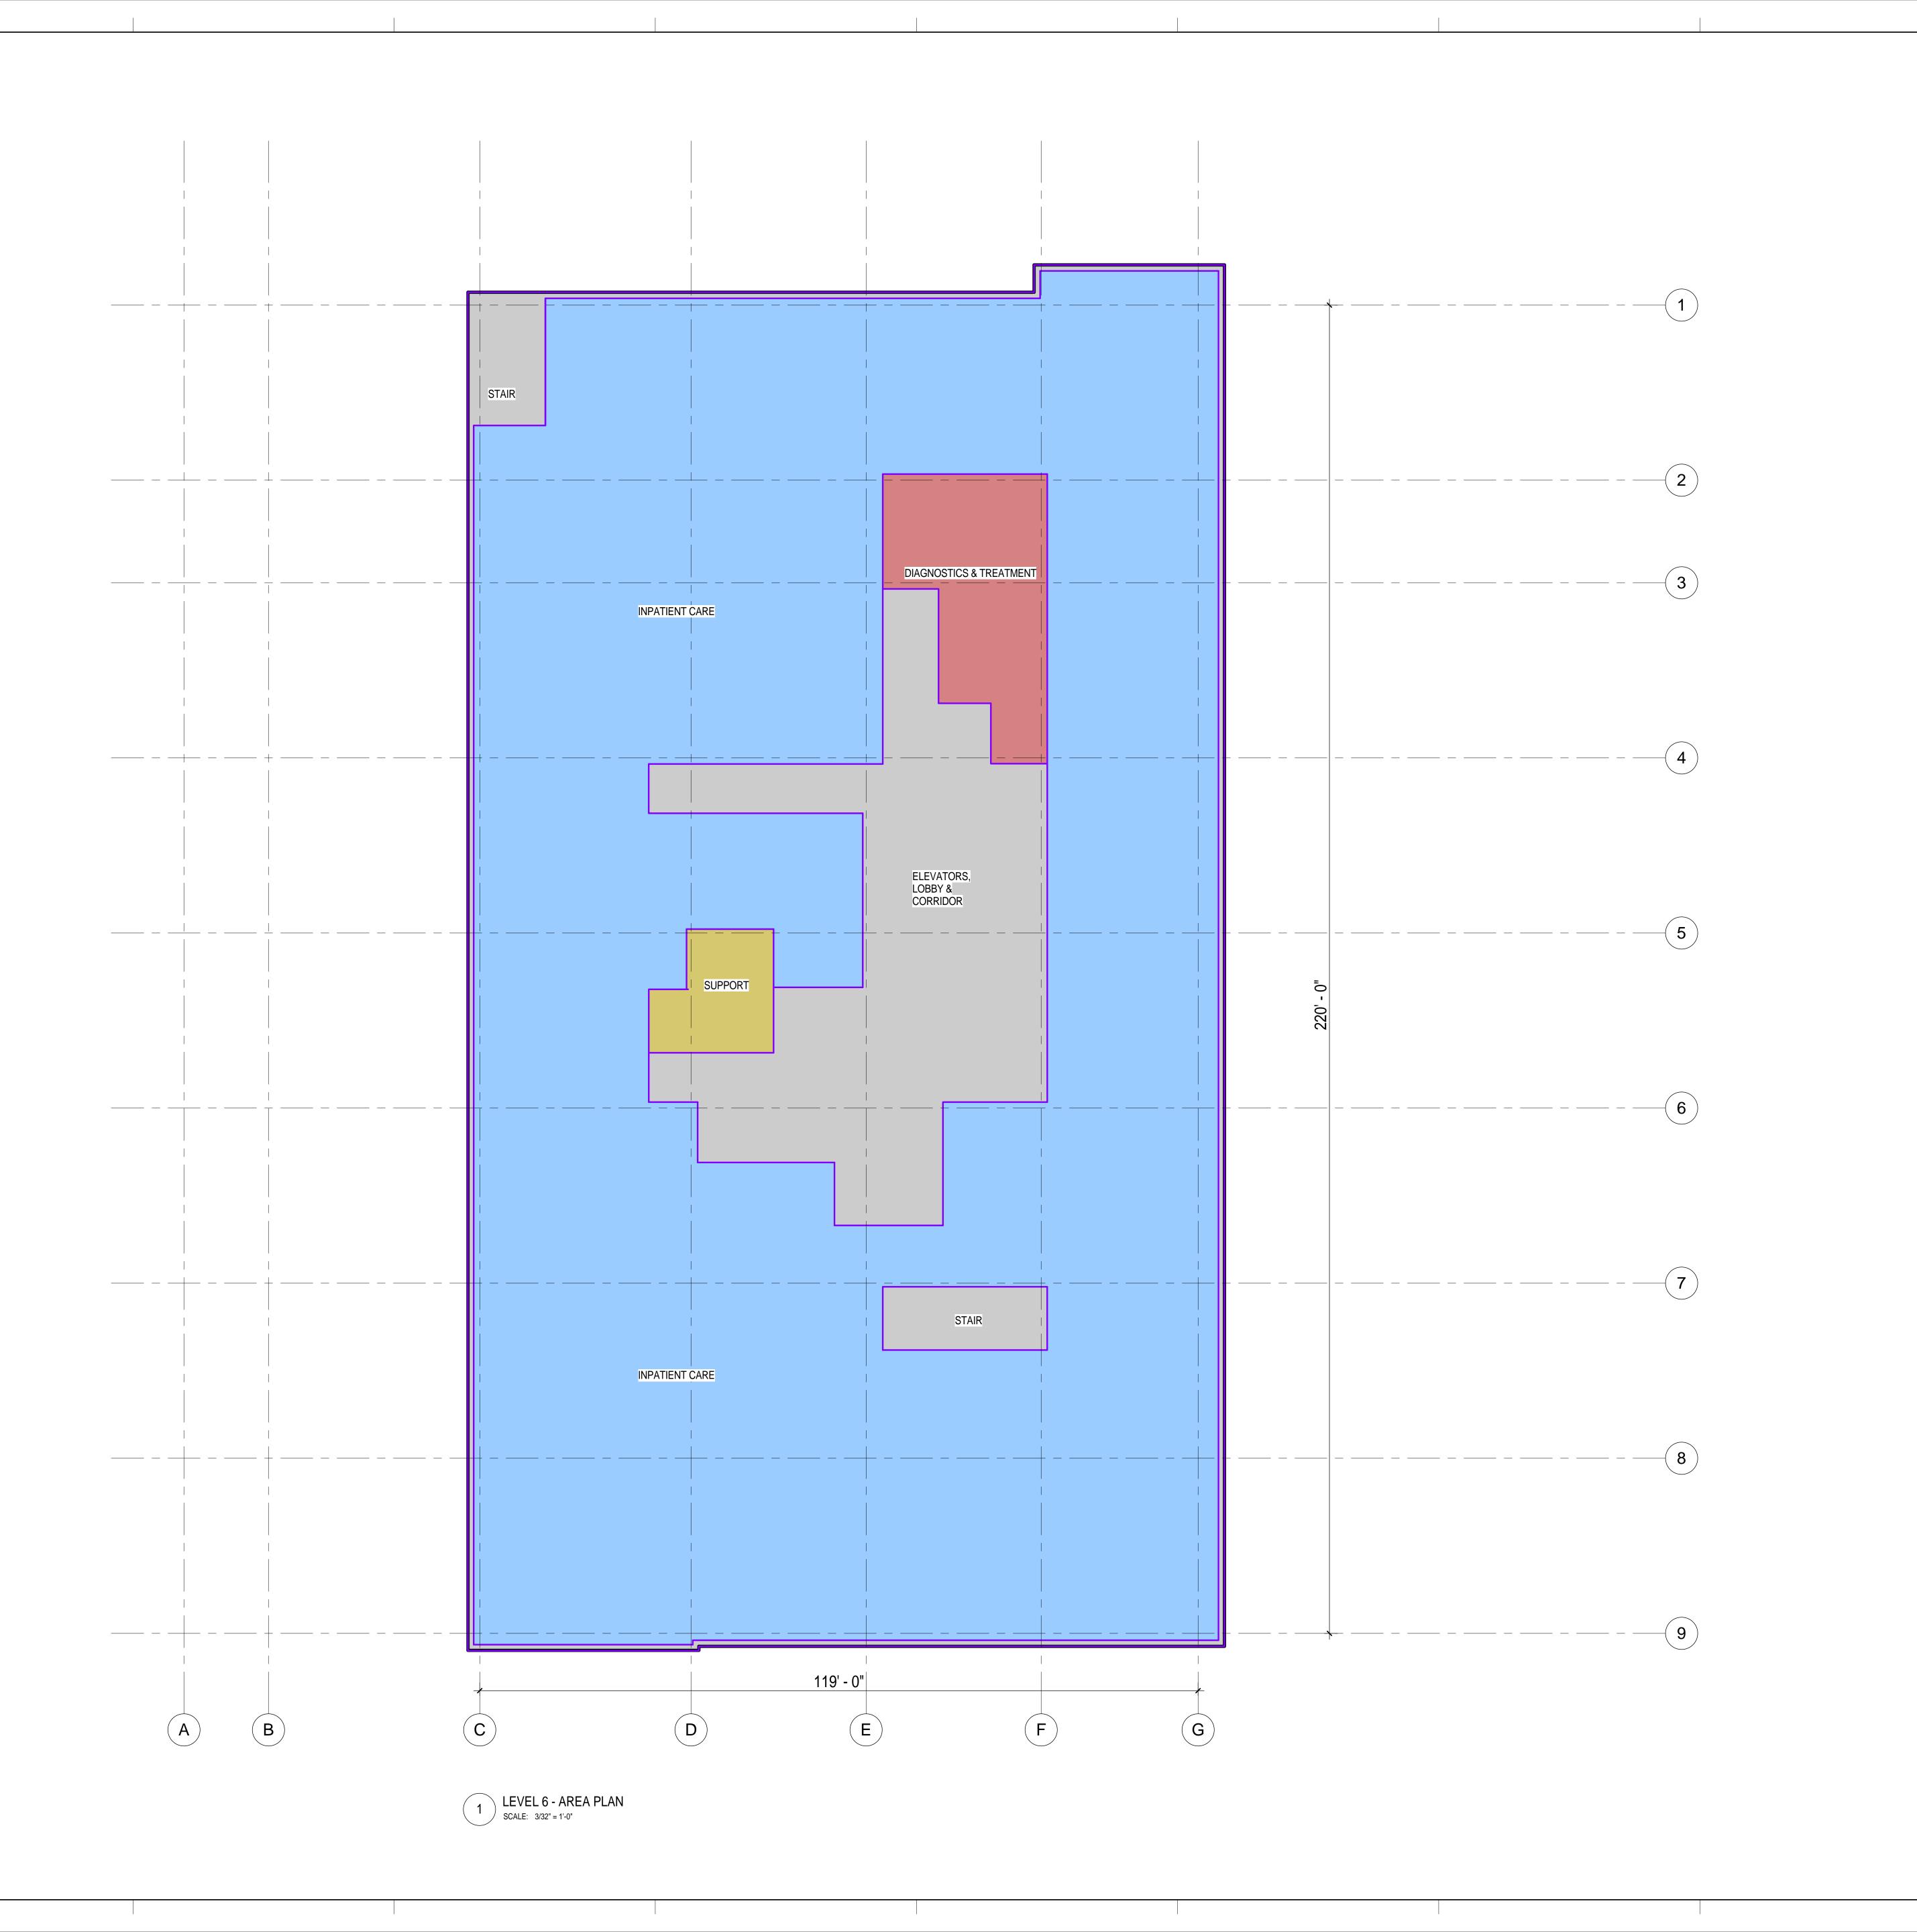
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HOSPITAL LEVEL 5 PLAN

3/32" = 1'-0" PROJECT NUMBER

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A2.5





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SEALS AND SIGNATURES

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PUC CUP RESUBMITTAL 2


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HOSPITAL LEVEL 6 PLAN

SCALE 3/32" = 1'-0"
PROJECT NUMBER 38412.000

DRAWING NUMBER

A2.6



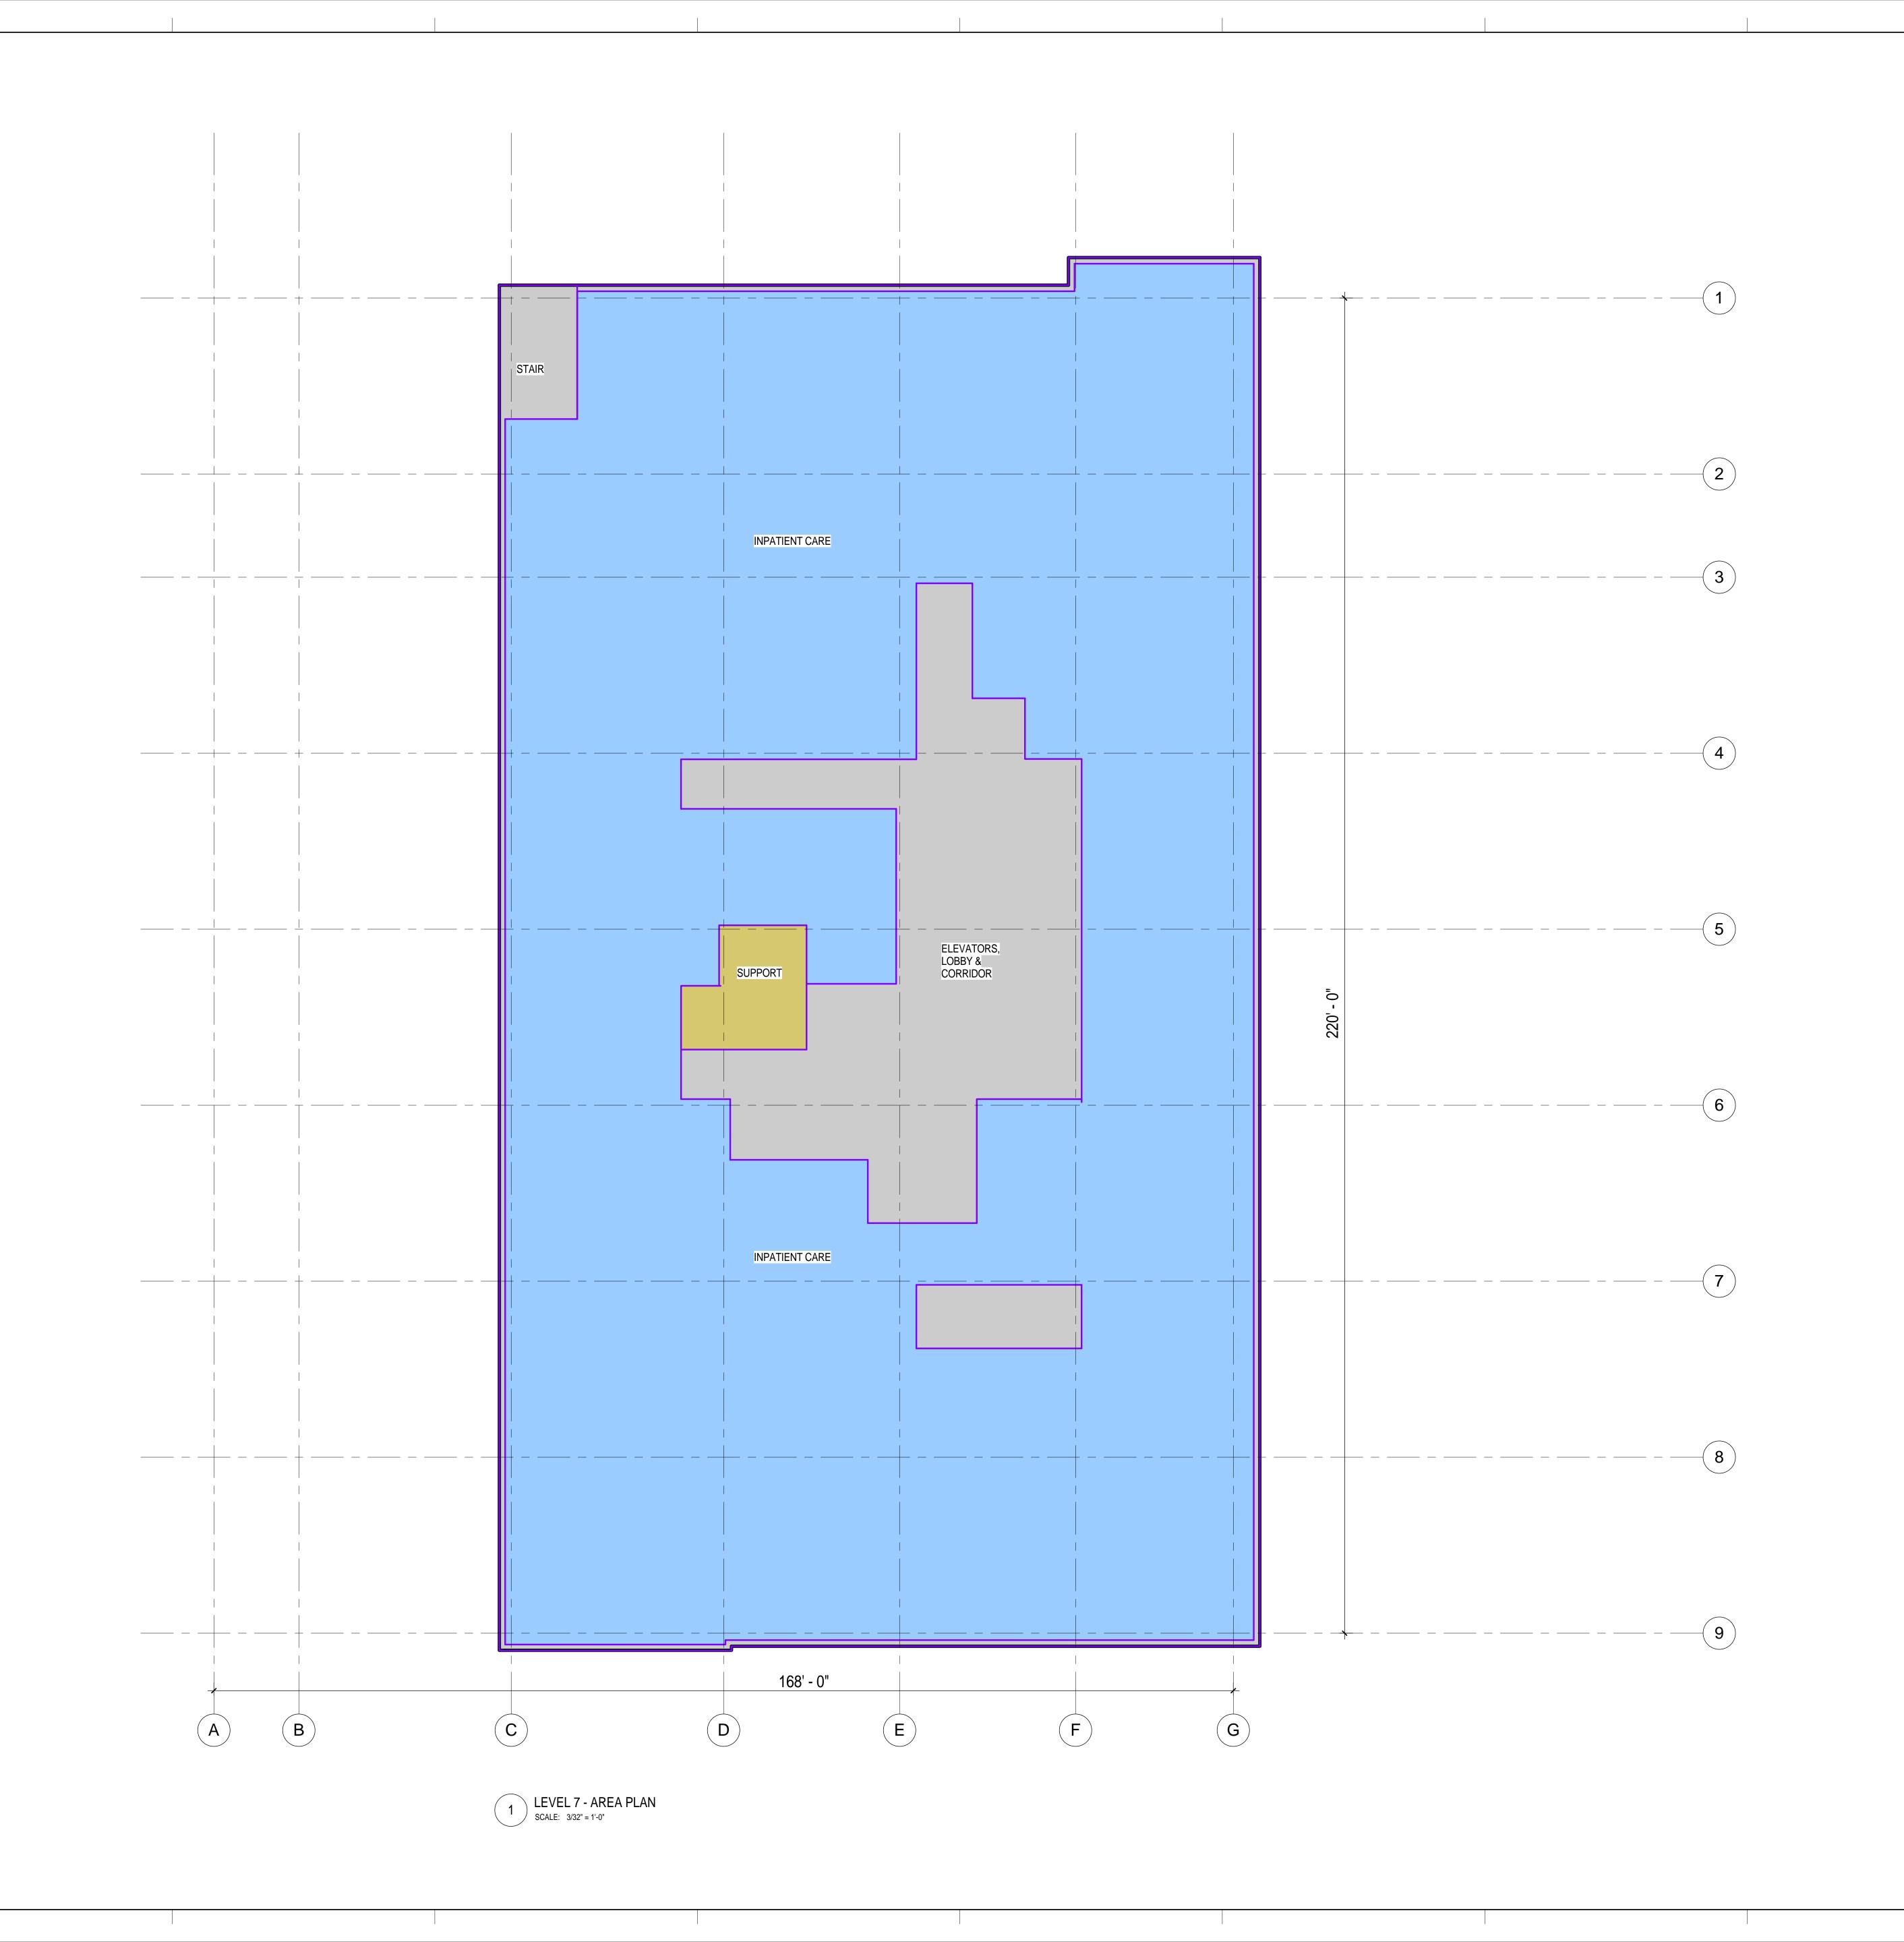

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HOSPITAL LEVEL 7 PLAN

PROJECT NUMBER

DRAWING NUMBER

A2.7

3/32" = 1'-0"





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HOSPITALPENTHOUSE LEVEL PLAN

3/32" = 1'-0" PROJECT NUMBER

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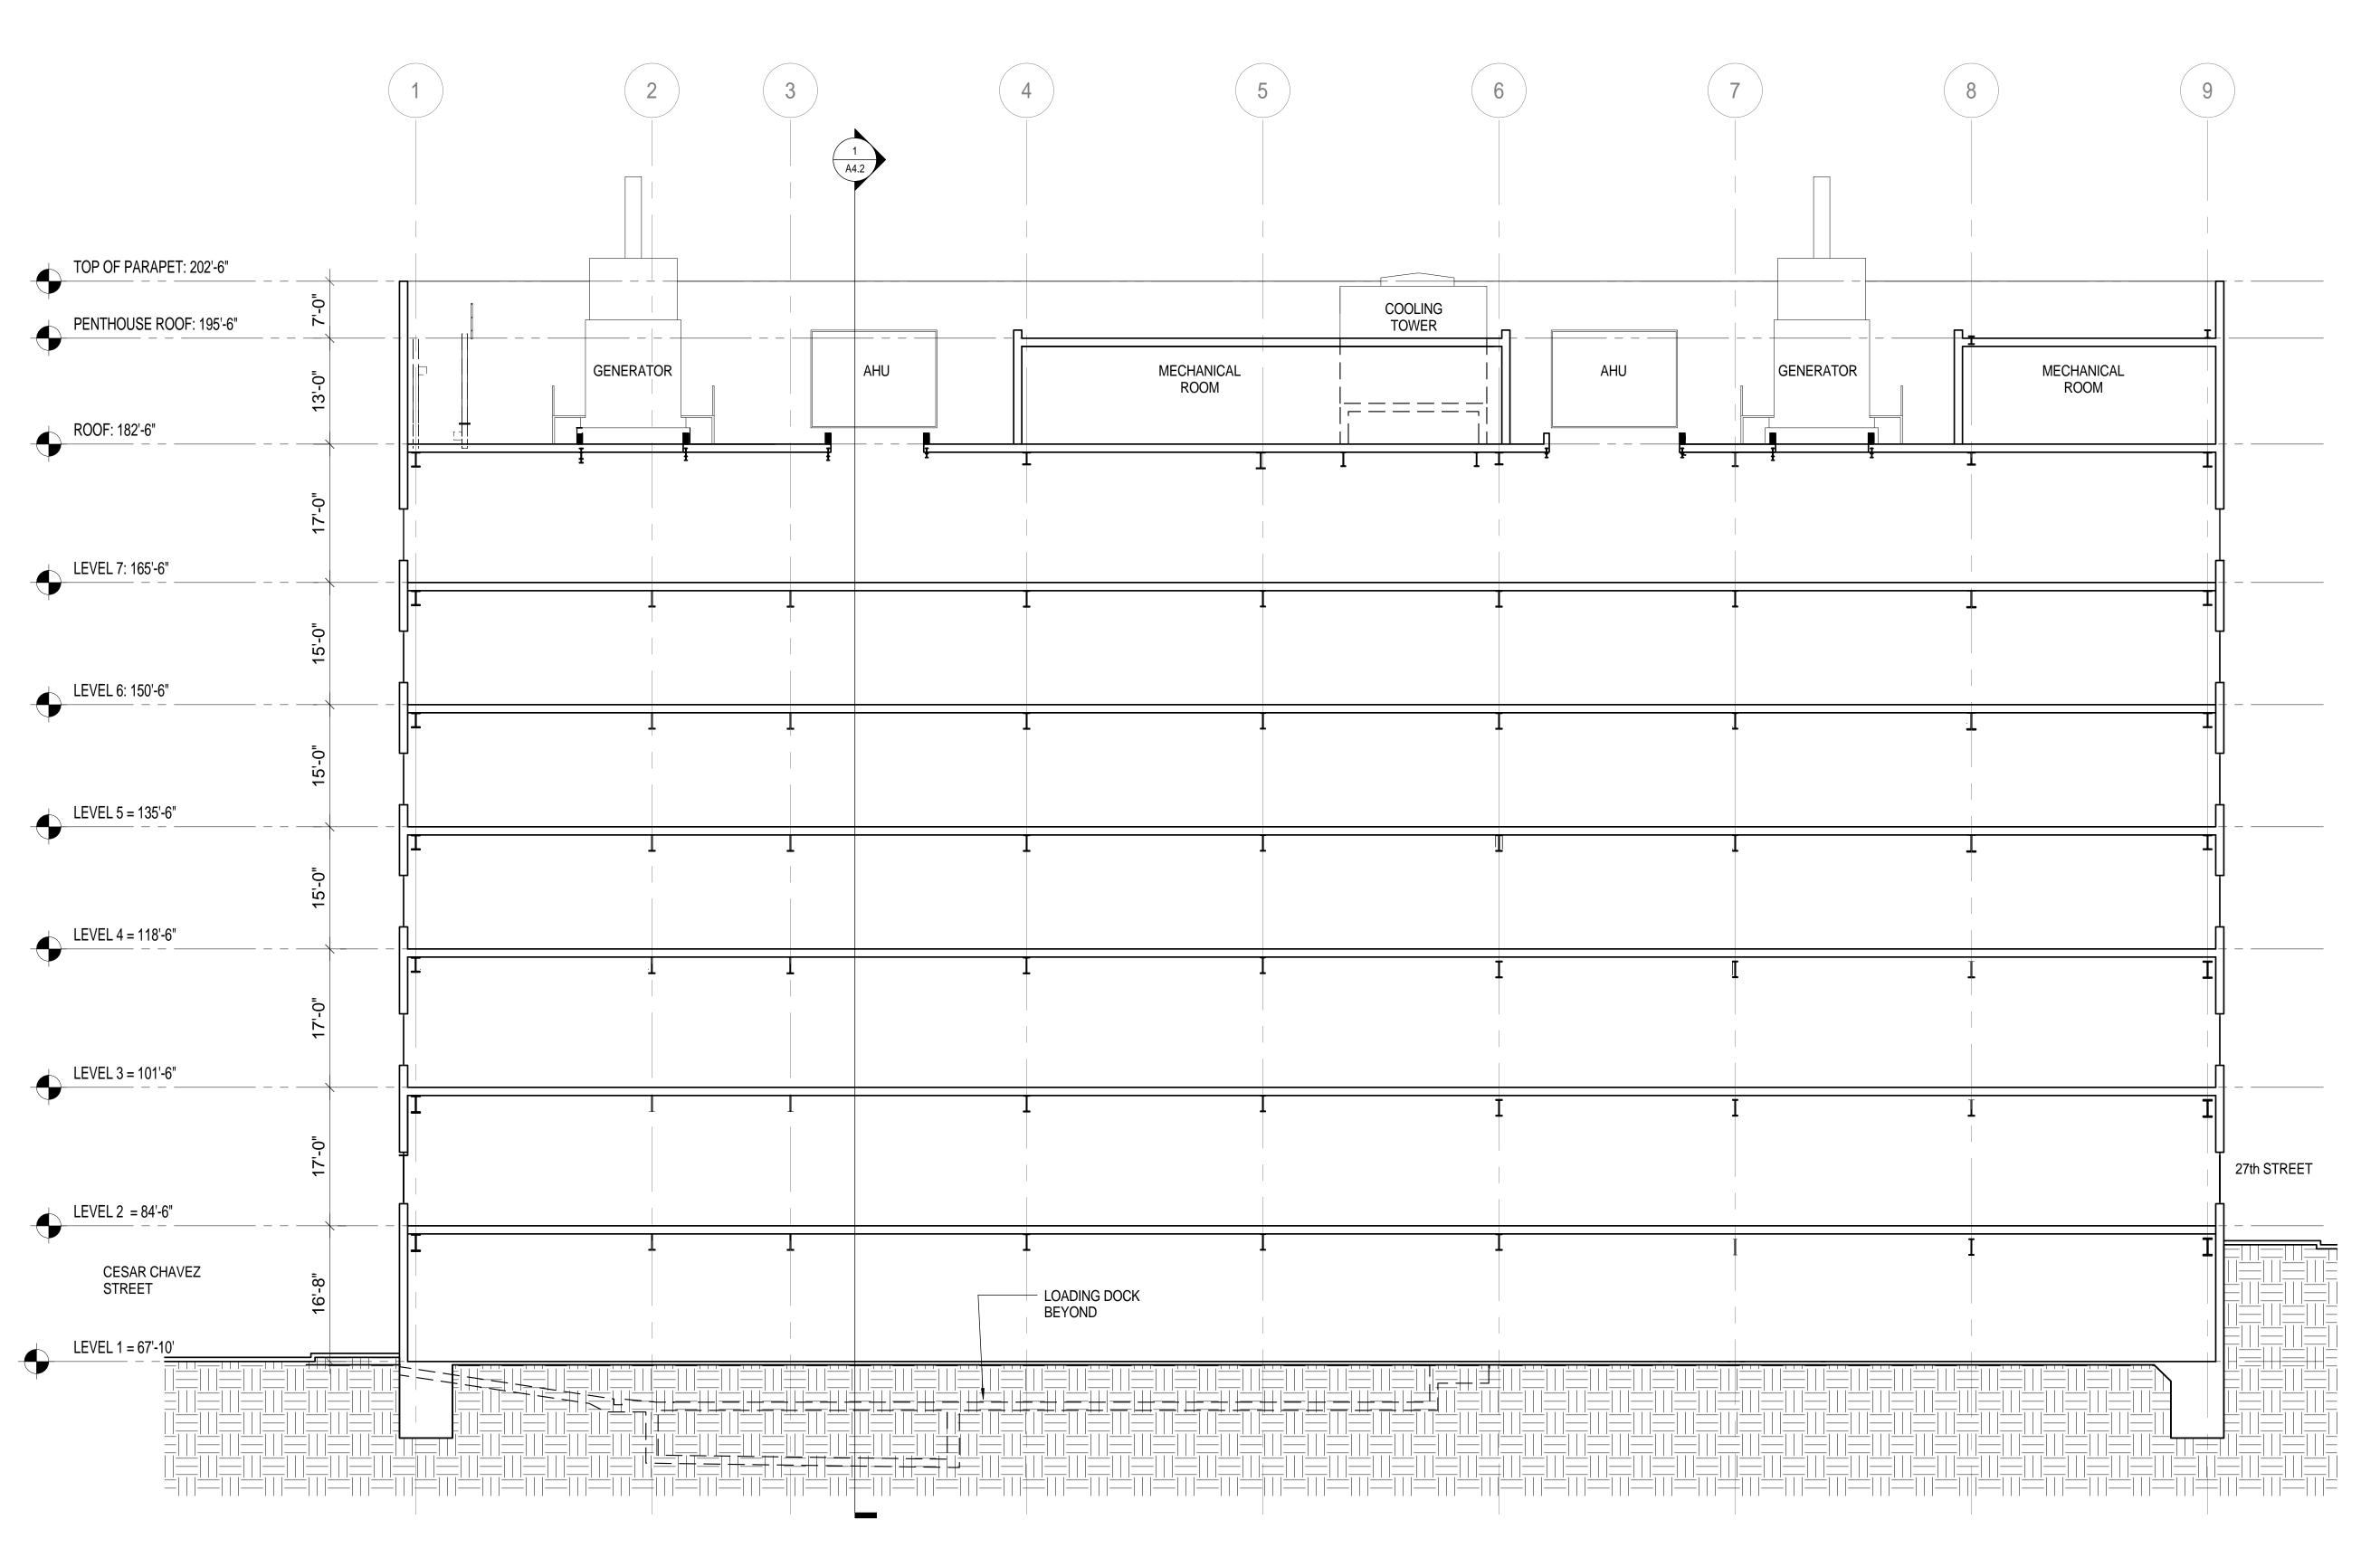
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REV DATE

3/32" = 1'-0" 38412.000





1 LONGITUDINAL SECTION SCALE: 3/32" = 1'-0"



California Pacific Medical Center

A Sutter Health Affiliate

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ST LUKE'S HOSPITAL OSHPD # IS-082199

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LANDSCAPE ARCHITECT 2200 Bridgeway Boulevard Sausalito, CA 94966

SEALS AND SIGNATURES

REV DATE PUC CUP RESUBMITTAL 2011 05 27

2013 05 06


PUC CUP RESUBMITTAL 2

HOSPITAL SECTION

PROJECT NUMBER

DRAWING NUMBER **A4.1**

3/32" = 1'-0"

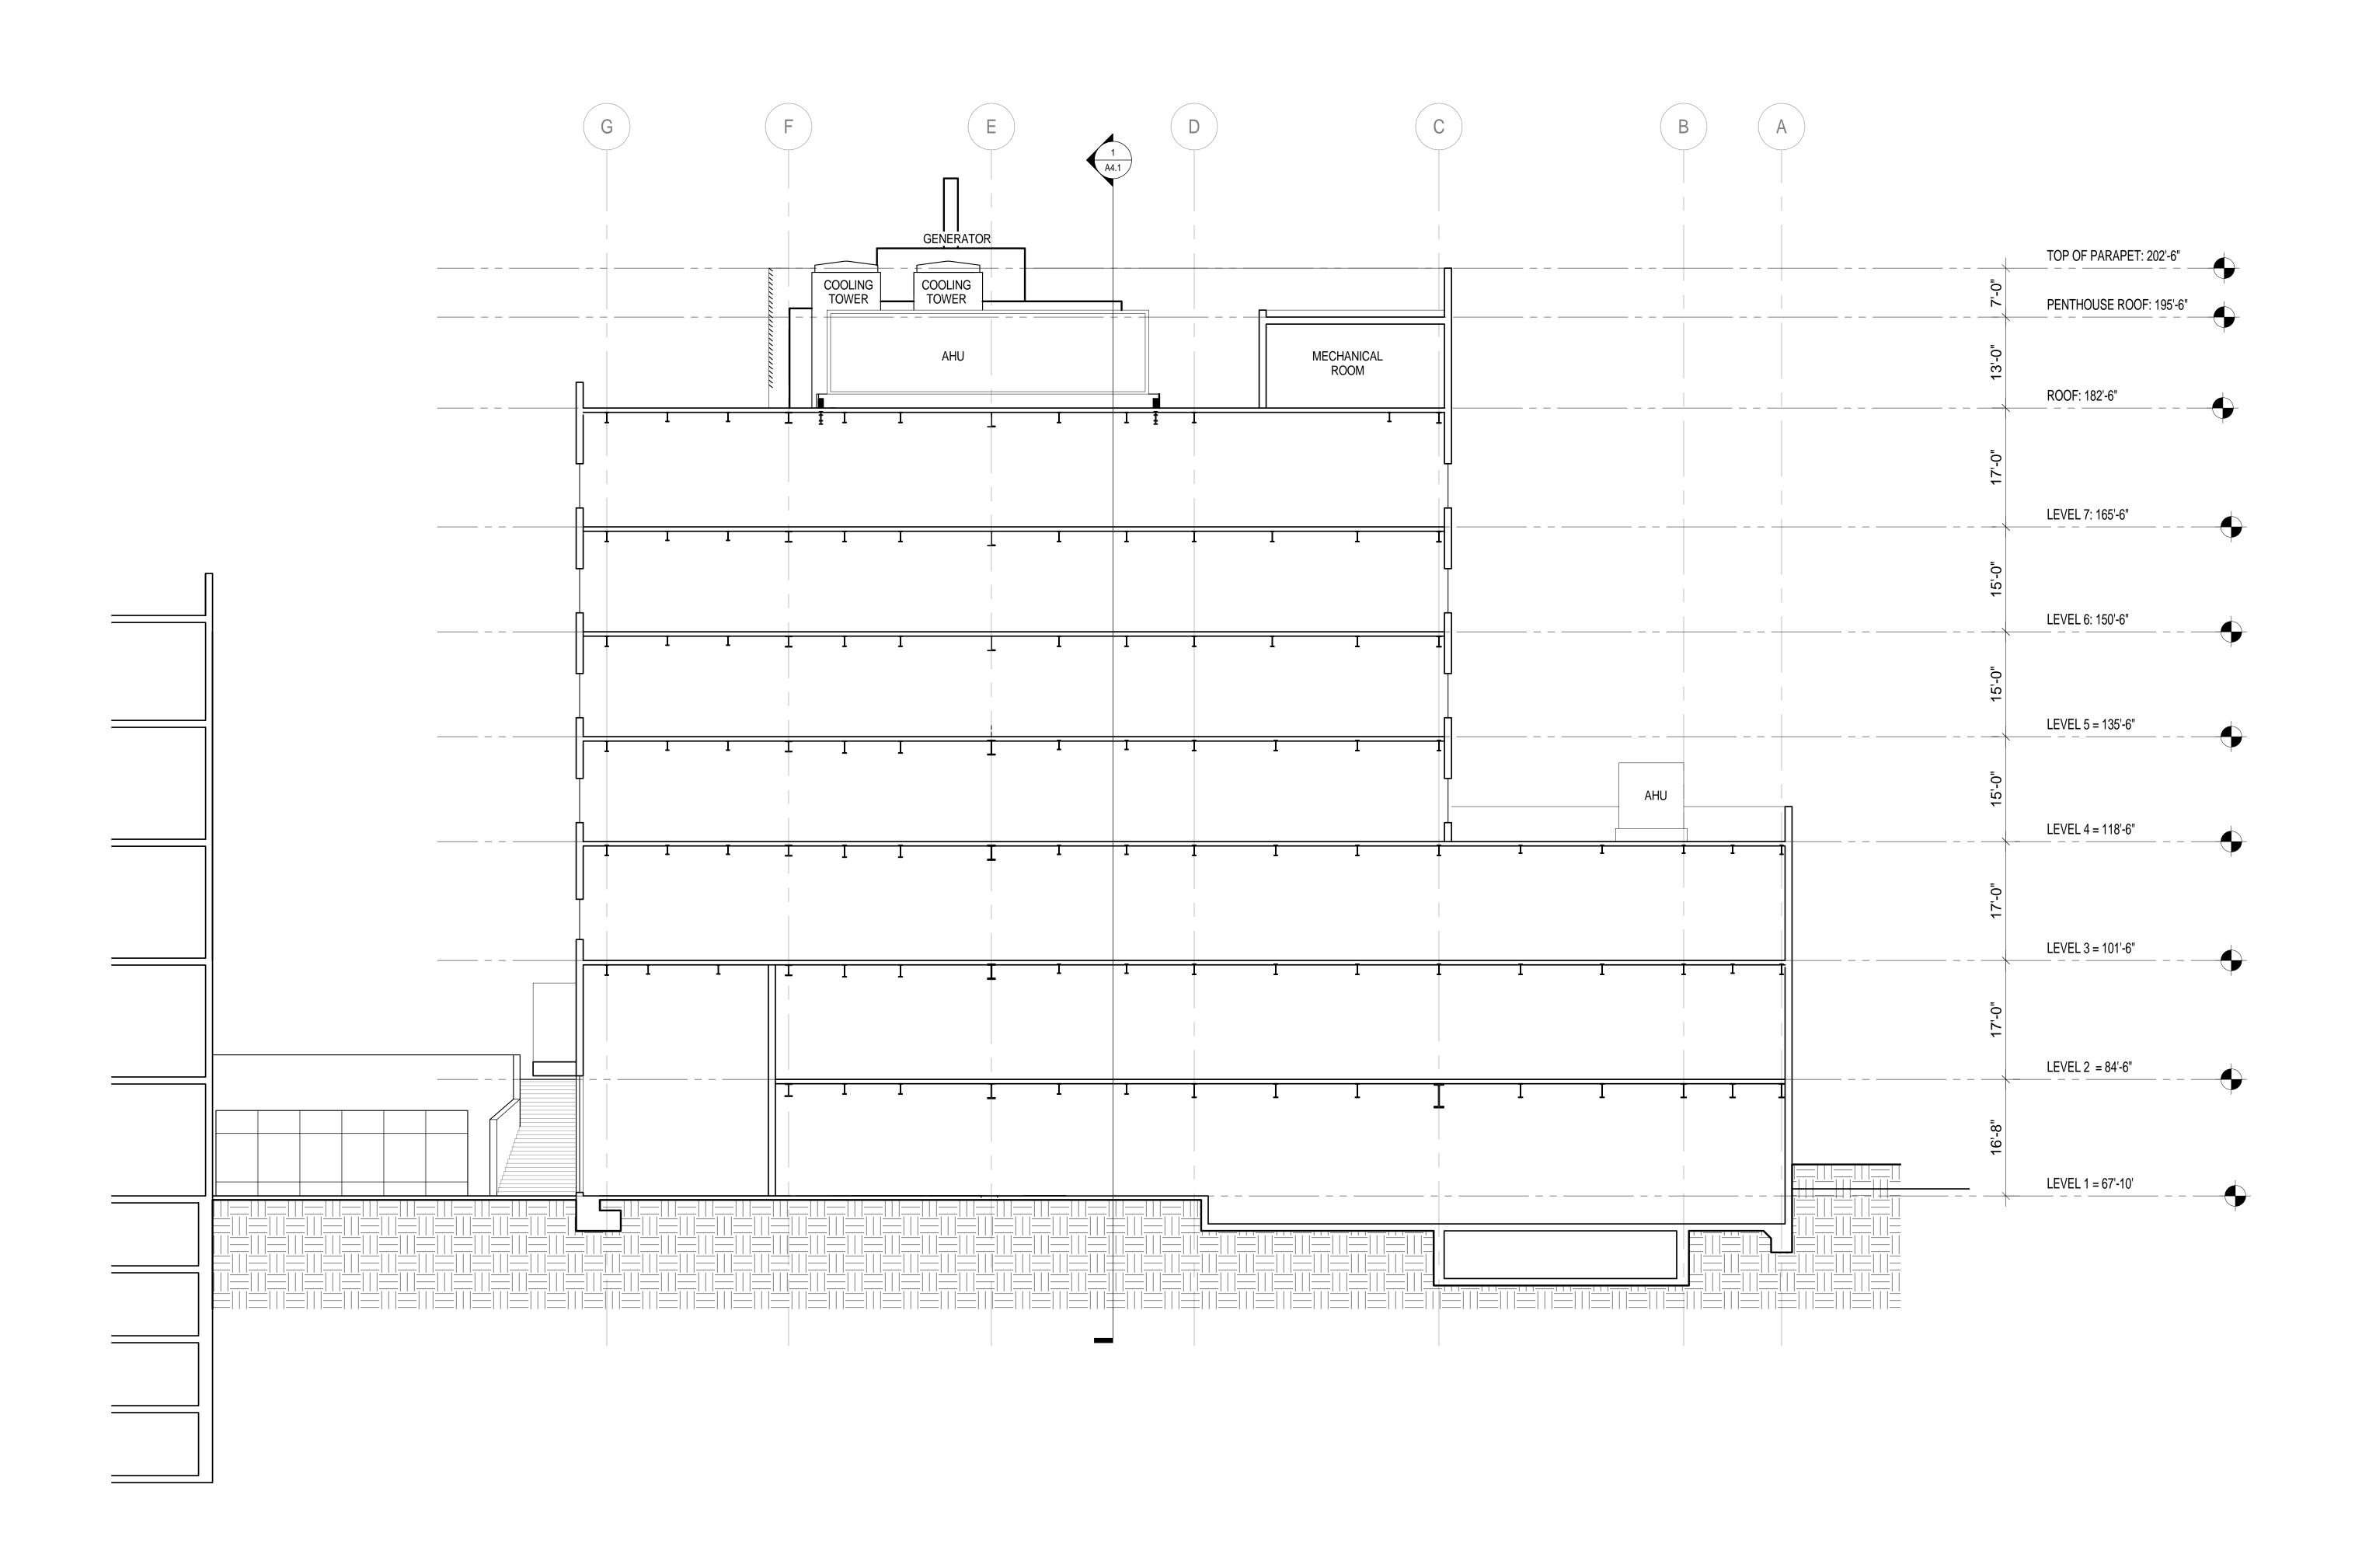



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Sausalito, CA 94966 415.332.5100

SWA

SEALS AND SIGNATURES

REV DATE PUC CUP RESUBMITTAL 2011 05 27

2013 05 06

PUC CUP RESUBMITTAL 2


HOSPITAL SECTION


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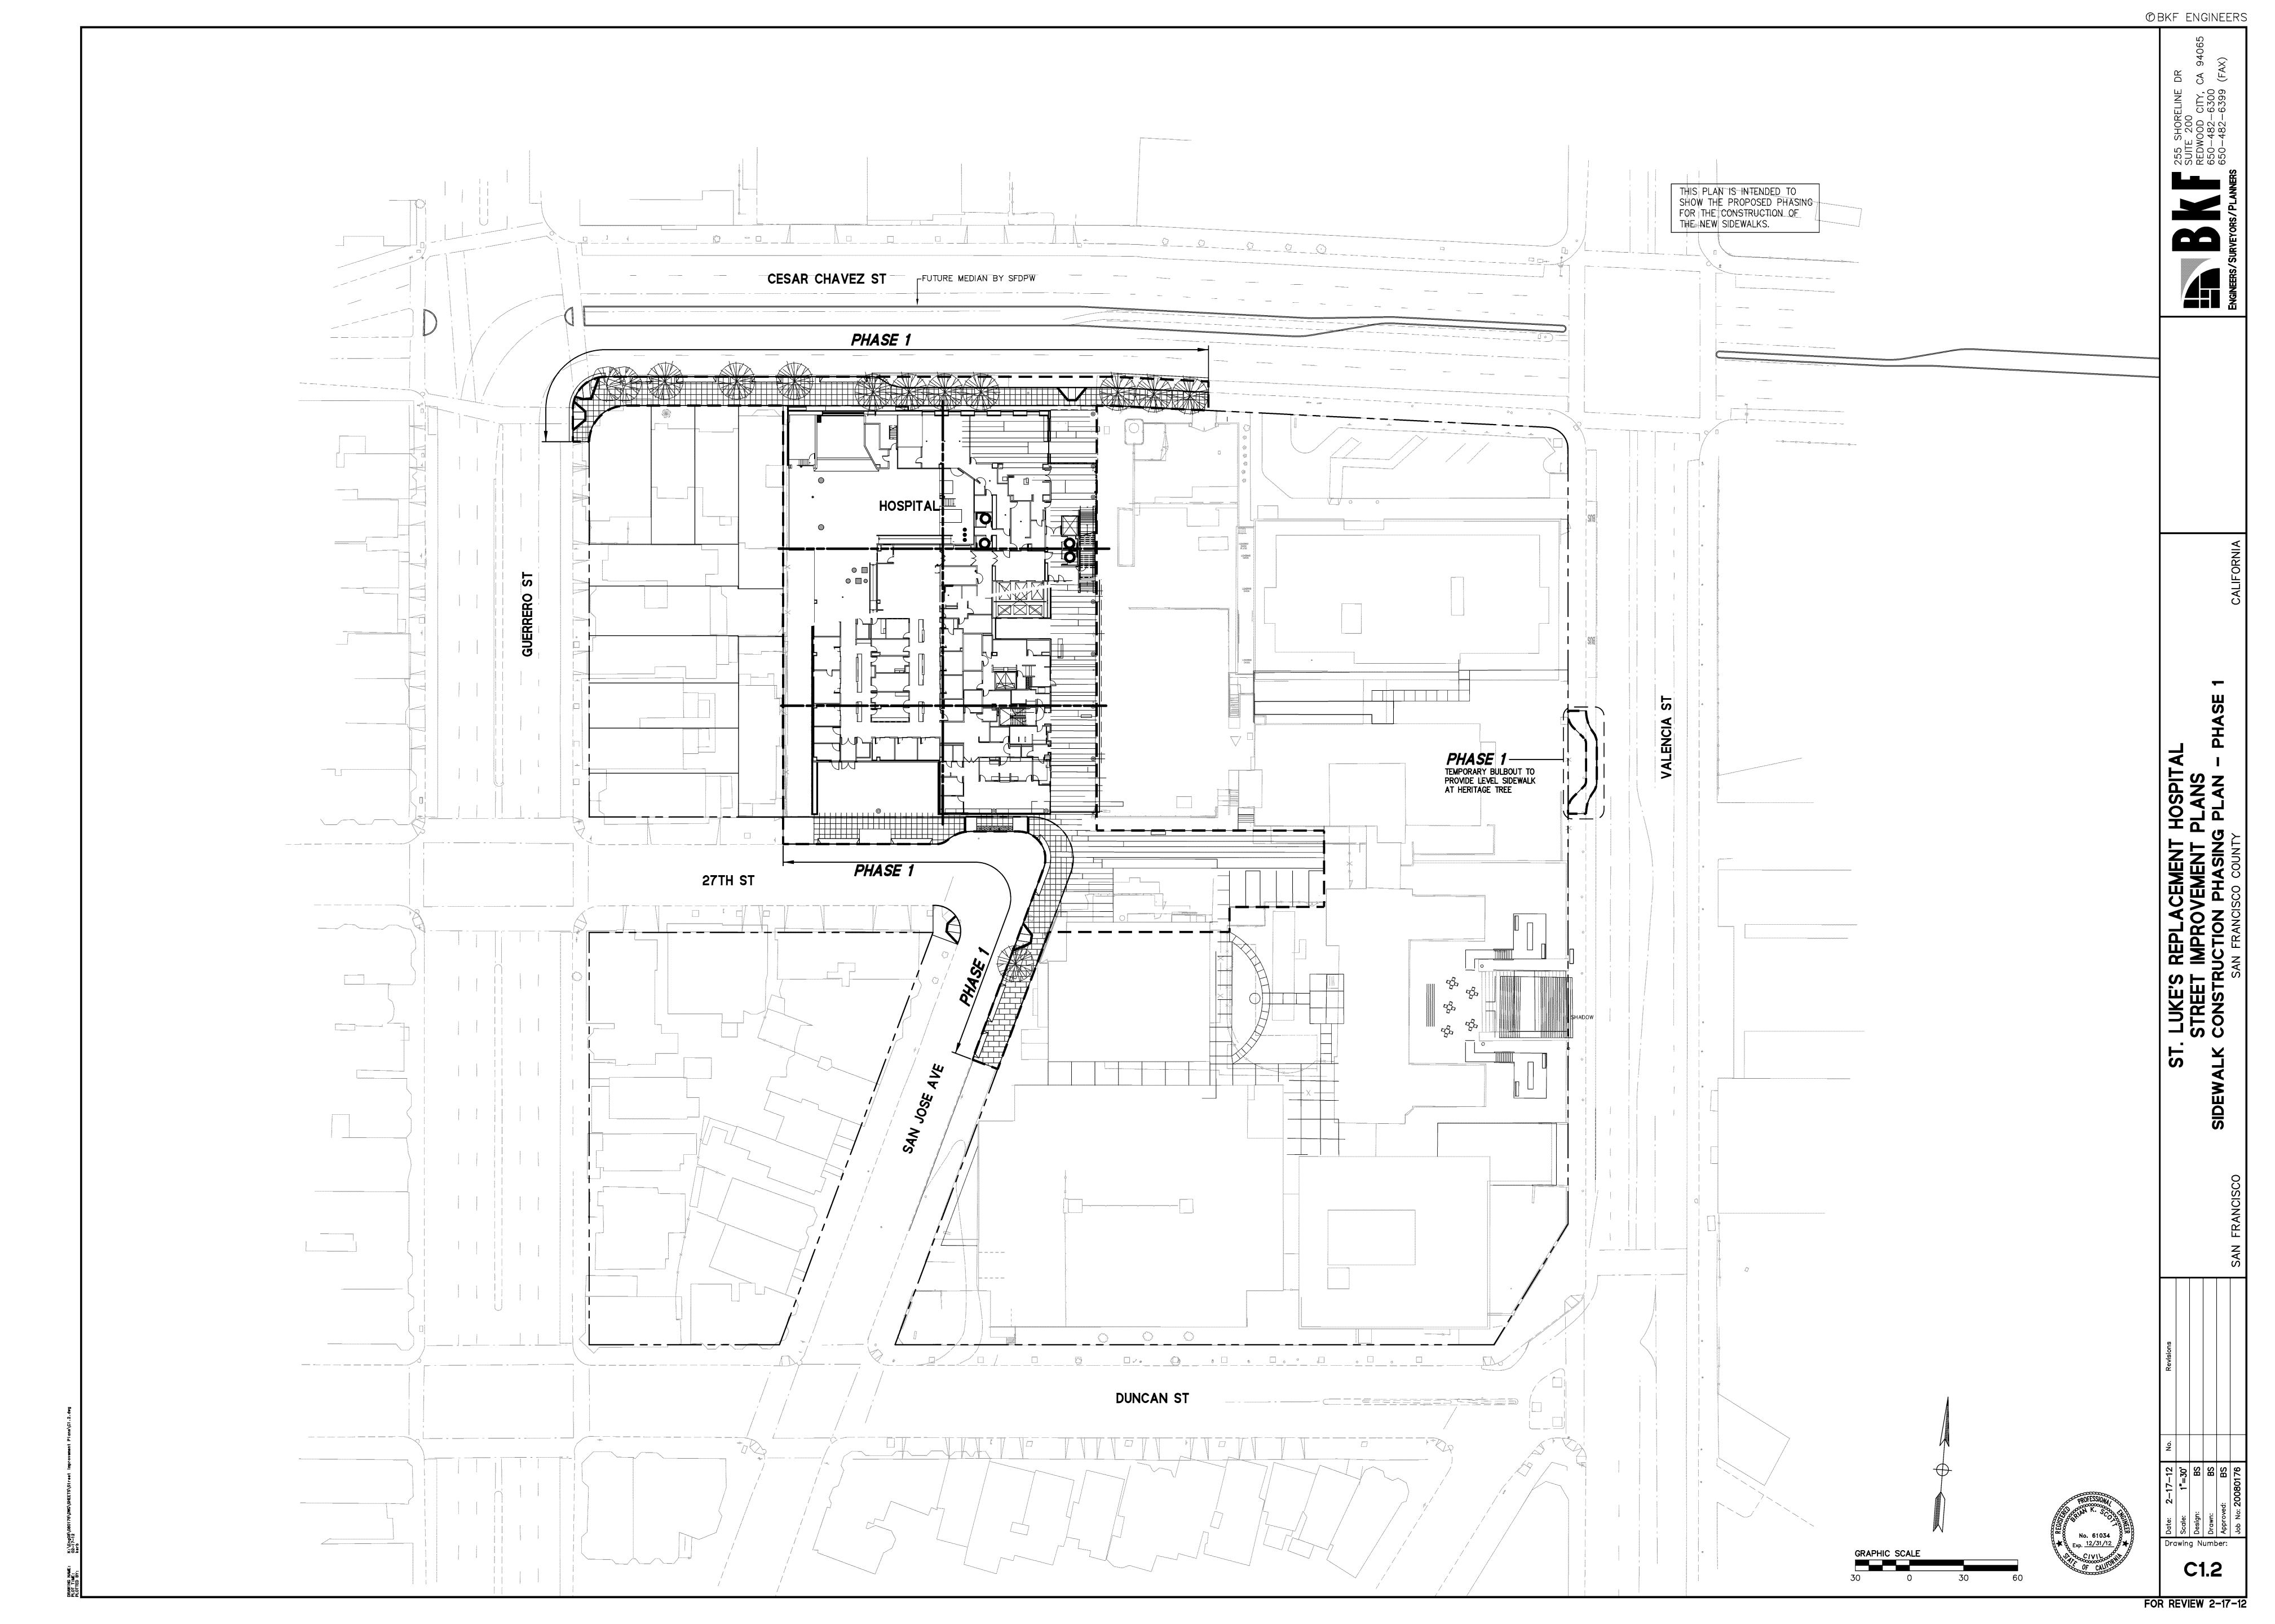
1 TRANSVERSE SECTION SCALE: 3/32" = 1'-0"


PROJECT NUMBER


3/32" = 1'-0"



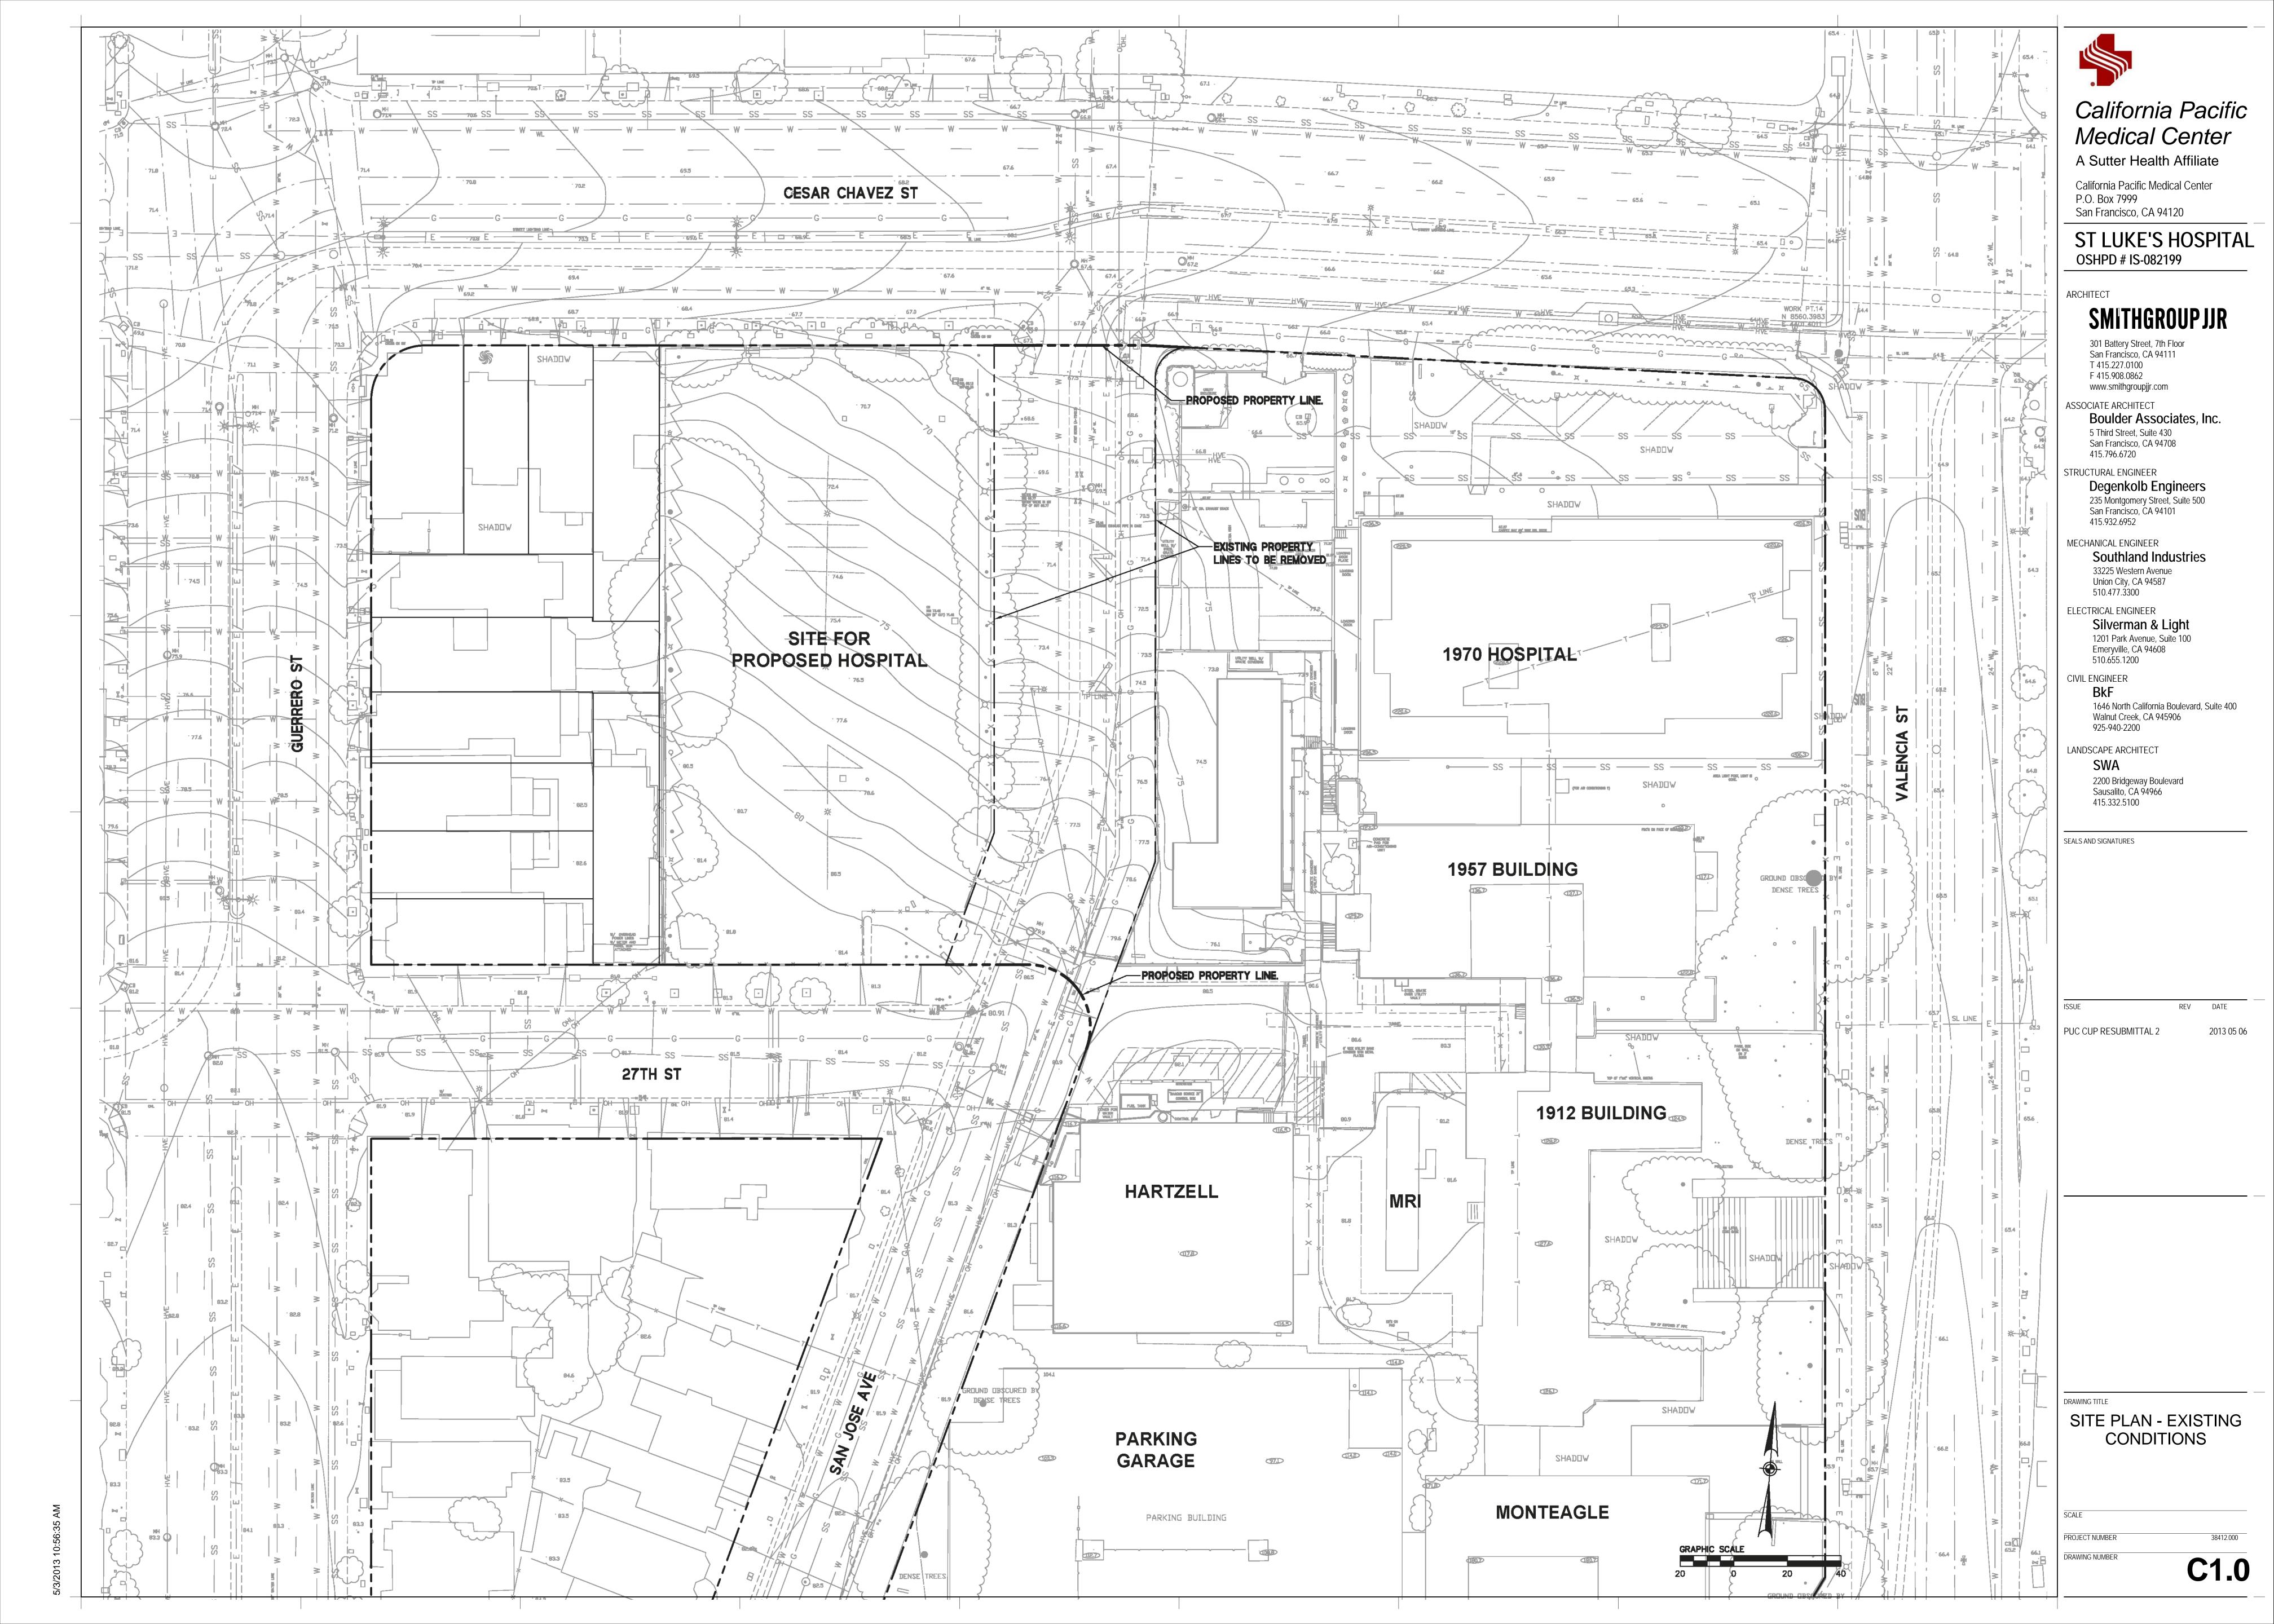

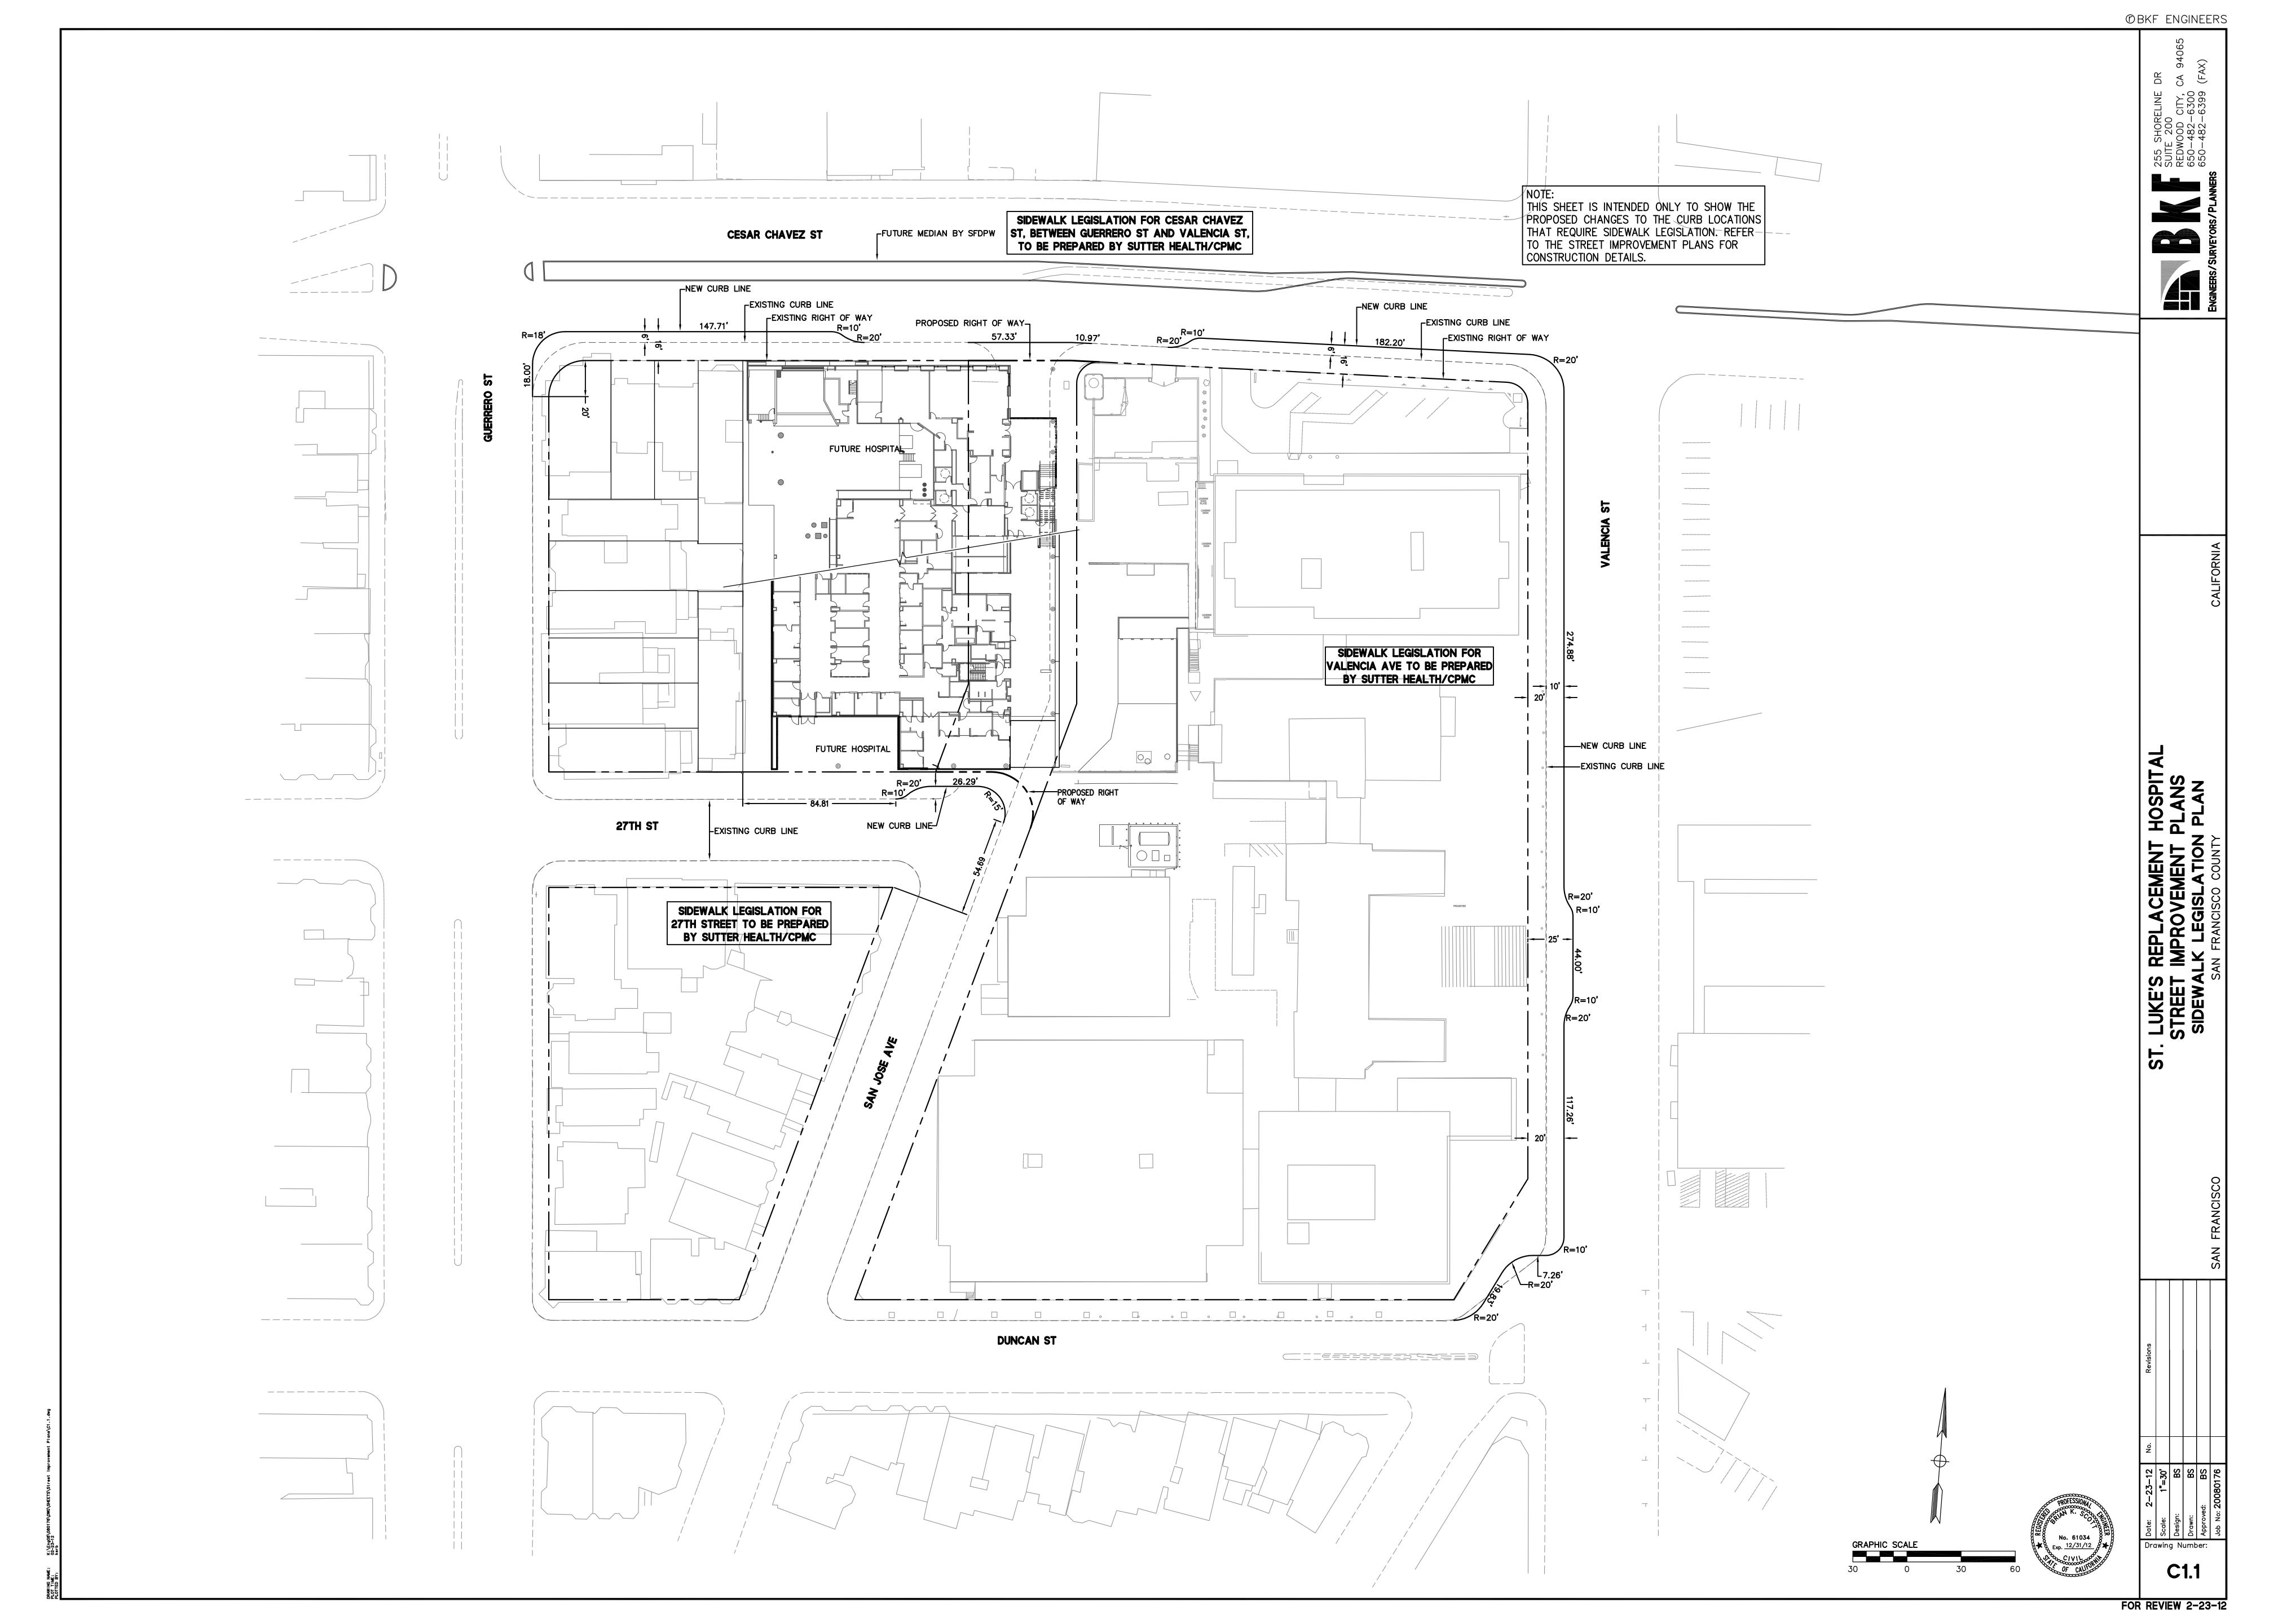

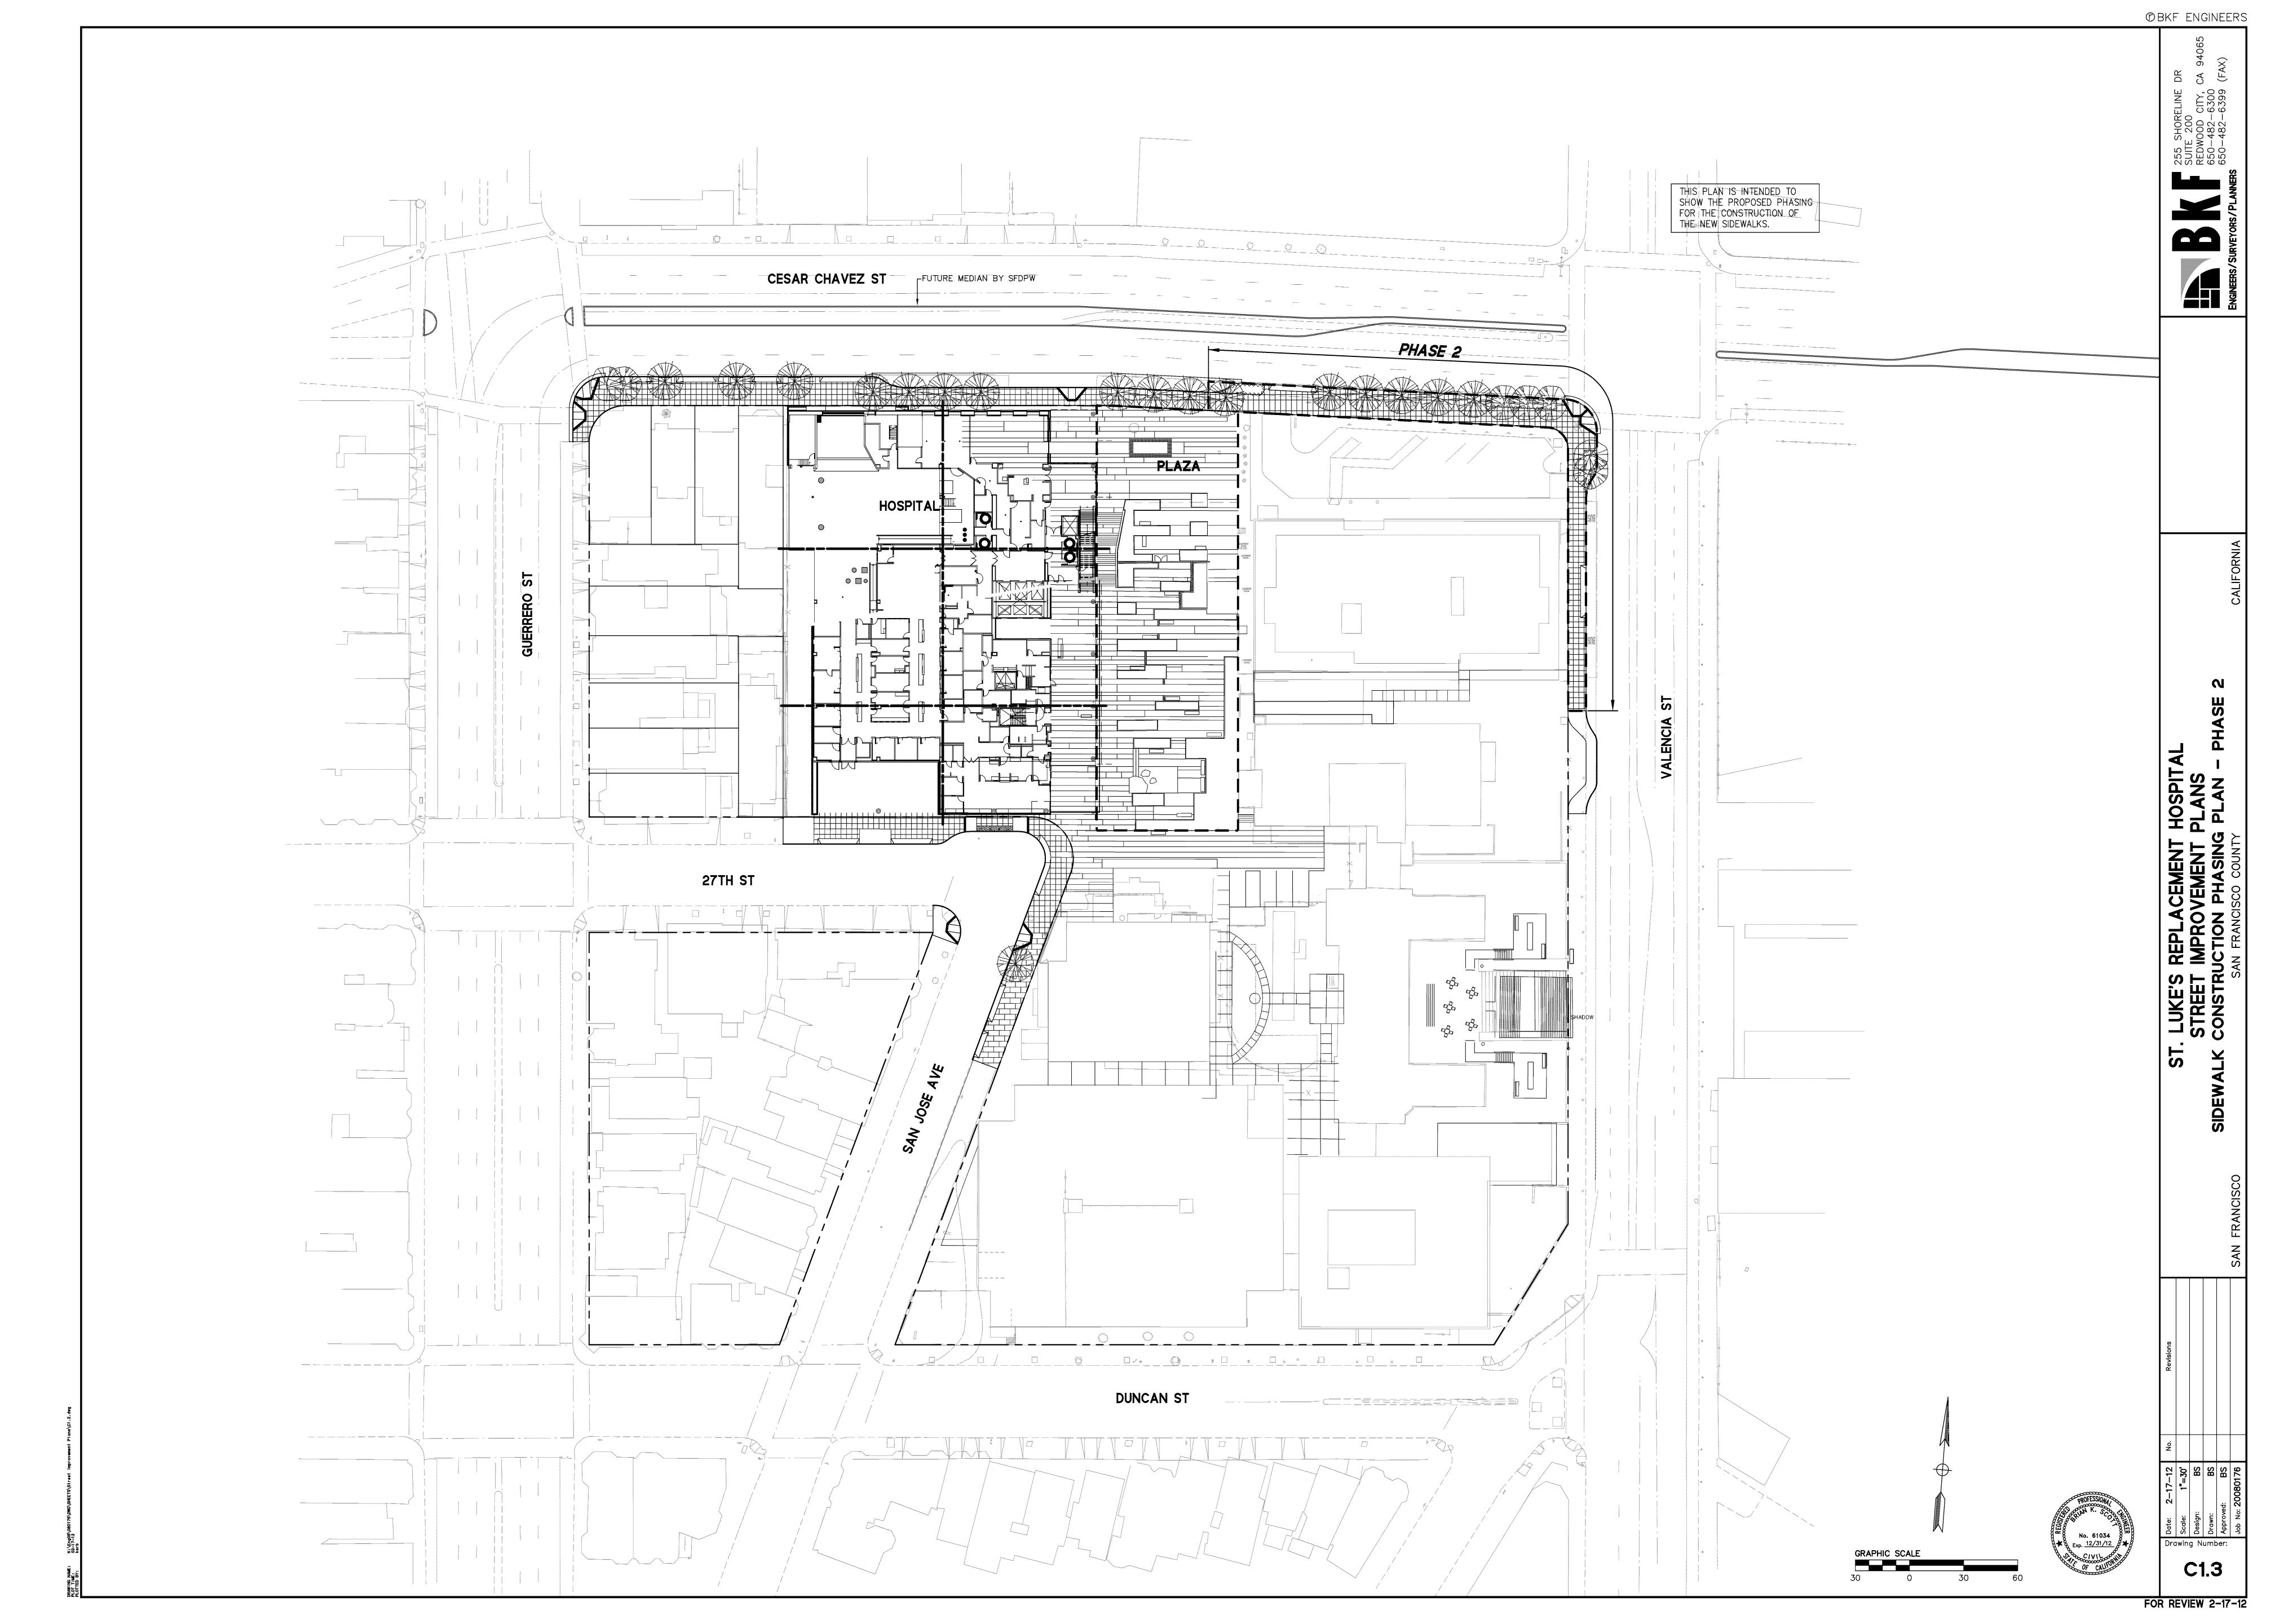

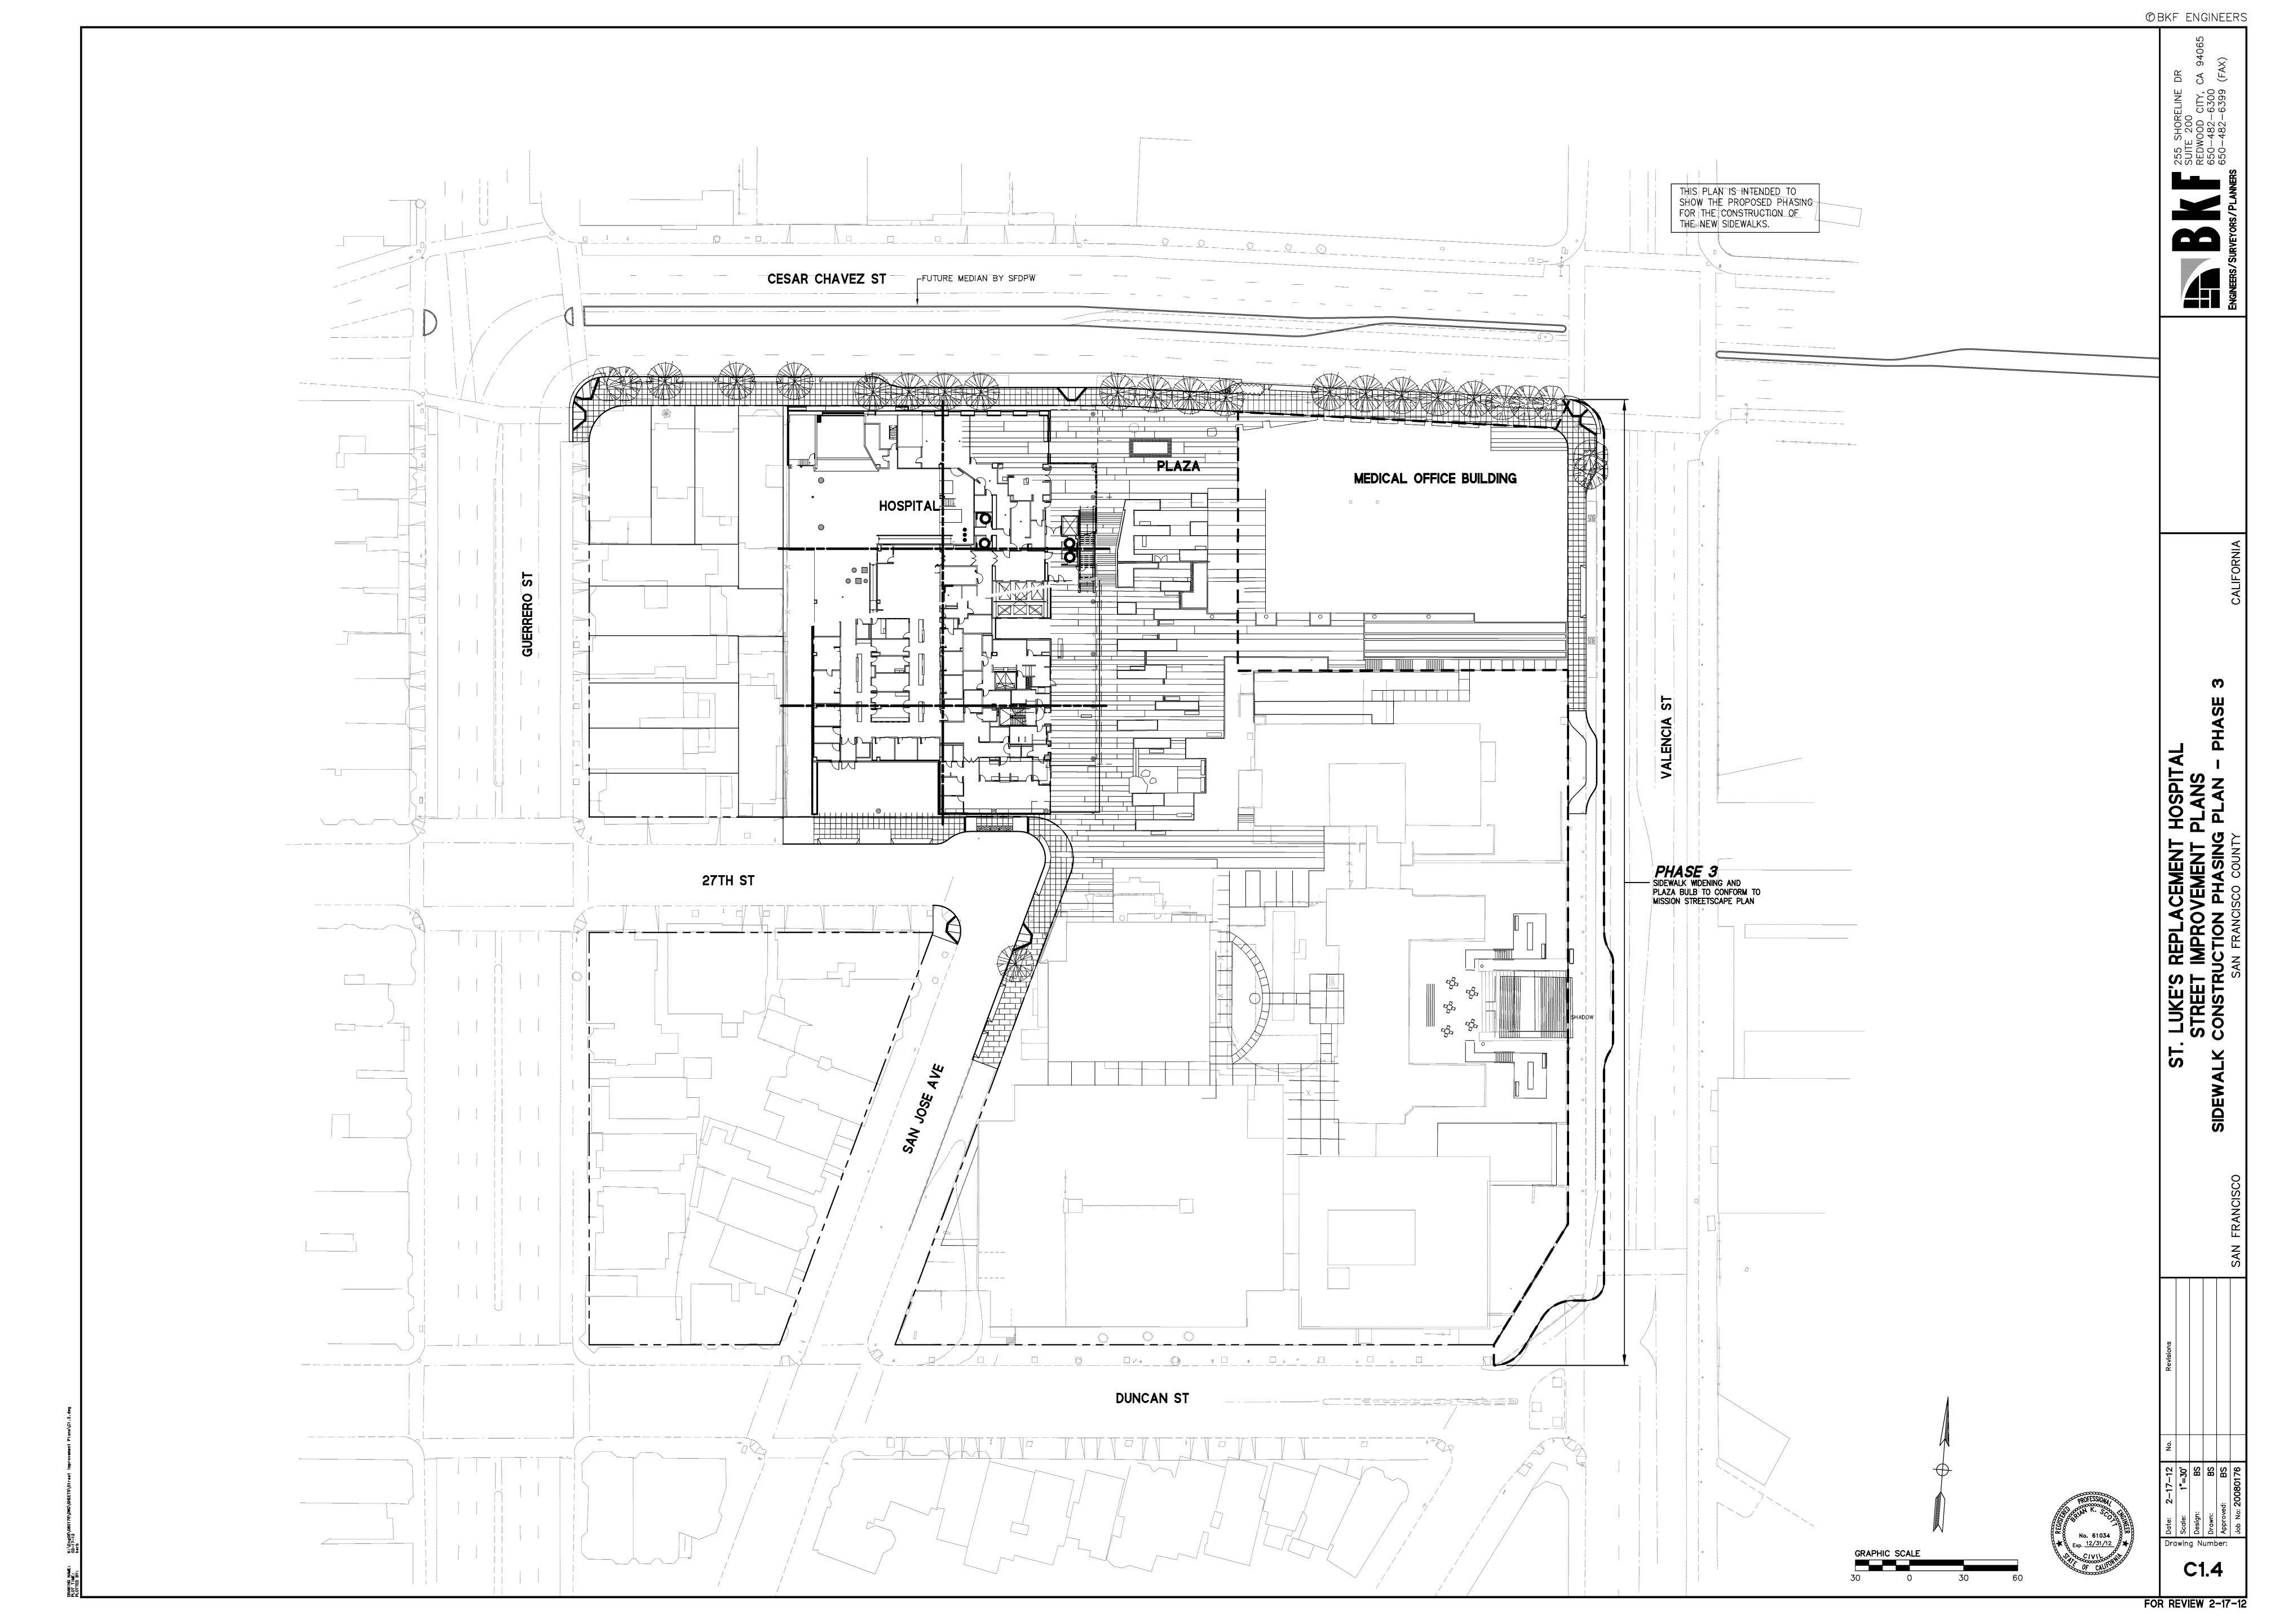

FOR REVIEW 2-17-12

